WESTBROOK ENTERTAINMENT & SPORTS DISTRICT PD PLANNING AREA PA2/PA3/PA4 1.198 ACRES SIP, PROJECT SP21-67

LEGAL DESCRIPTION


A PARCEL OF LAND LOCATED IN THE SOUTHWEST 1/4 OF SECTION 3, TONSHIP 6 SOUTH, RANGE 67 WEST, SIXTH PRINCIPAL MERIDIAN, CITY OF LONE TREE, COUNTY OF DOUGLAS, STATE OF COLORAD.


PURPOSE STATEMENT/DESCRIPTION

THE PURPOSE OF THIS SITE IMPROVEMENT PLAN IS TO INCLUDE THE ADDITION OF A PROPOSED TUNNEL CAR WASH BUILDING. THE PROPOSED BUILDING IS LOCATED AT 9155 PARK MEADOWS DRIVE.

NOTES

- 1. THE PROPERTY HEREIN IS SUBJECT TO ALL APPLICABLE REQUIREMENTS OF THE LONE TREE ZONING CODE, INCLUDING, BUT NOT LIMITED TO, MAINTENANCE, LIGHTING, PARKING, SIGNAGE, AND OUTDOOR STORAGE, EXCEPT AS MAY OTHERWISE BE ADDRESSED IN AN APPROVED DEVELOPMENT PLAN OR SUB-AREA PLAN.
- 2. THE APPLICANT ASSUMES RESPONSIBILITY TO ENSURE THE PROJECT IS COMPLETED IN ACCORDANCE WITH THE APPROVED SIP AND ANY ASSOCIATED MATERIALS SAMPLE BOARDS AND FURTHER ASSUMES THE RISK ASSOCIATED WITH ANY CHANGES OR OMISSIONS MADE WITHOUT PRIOR CITY APPROVAL. MODIFICATIONS TO STRUCTURES OR SITES MAY REQUIRE AN AMENDMENT TO THE SIP AS DETERMINED BY THE DIRECTOR. UNAUTHORIZED CHANGES OR OMISSIONS MAY RESULT IN CORRECTIVE ACTIONS, DELAY OF PERMITS OR CITATIONS FOR ZONING VIOLATIONS WITH ASSOCIATED FINES AND LEGAL MEASURES. BUILDING PLANS SHALL CONFORM TO THE APPROVED SIP.
- 3. THE CITY OF LONE TREE REQUIRES THAT MAINTENANCE ACCESS BE PROVIDED TO ALL STORM DRAINAGE FACILITIES TO ASSURE CONTINUOUS OPERATIONAL CAPABILITY OF THE SYSTEM. THE PROPERTY OWNER SHALL BE RESPONSIBLE FOR THE MAINTENANCE OF ALL DRAINAGE FACILITIES, INCLUDING INLETS, PIPES, CULVERTS, CHANNELS, DITCHES, HYDRAULIC STRUCTURES AND DETENTION BASINS LOCATED ON THEIR LAND UNLESS MODIFIED BY THE SUBDIVIDER'S AGREEMENT. SHOULD THE OWNER FAIL TO ADEQUATELY MAINTAIN SAID FACILITIES, THE CITY OF LONE TREE SHALL HAVE THE RIGHT TO ENTER SAID LAND FOR THE PURPOSES OF OPERATIONS AND MAINTENANCE. ALL SUCH MAINTENANCE COSTS WILL BE ASSESSED TO THE PROPERTY OWNER.
- 4. THE OWNER/DEVELOPER IS RESPONSIBLE FOR INSTALLATION OF ALL ROADWAY SIGNAGE, INCLUDING NO PARKING/FIRE LANE SIGNAGE, AS REQUIRED BY THE CITY PUBLIC WORKS DEPARTMENT AND FIRE DISTRICT.

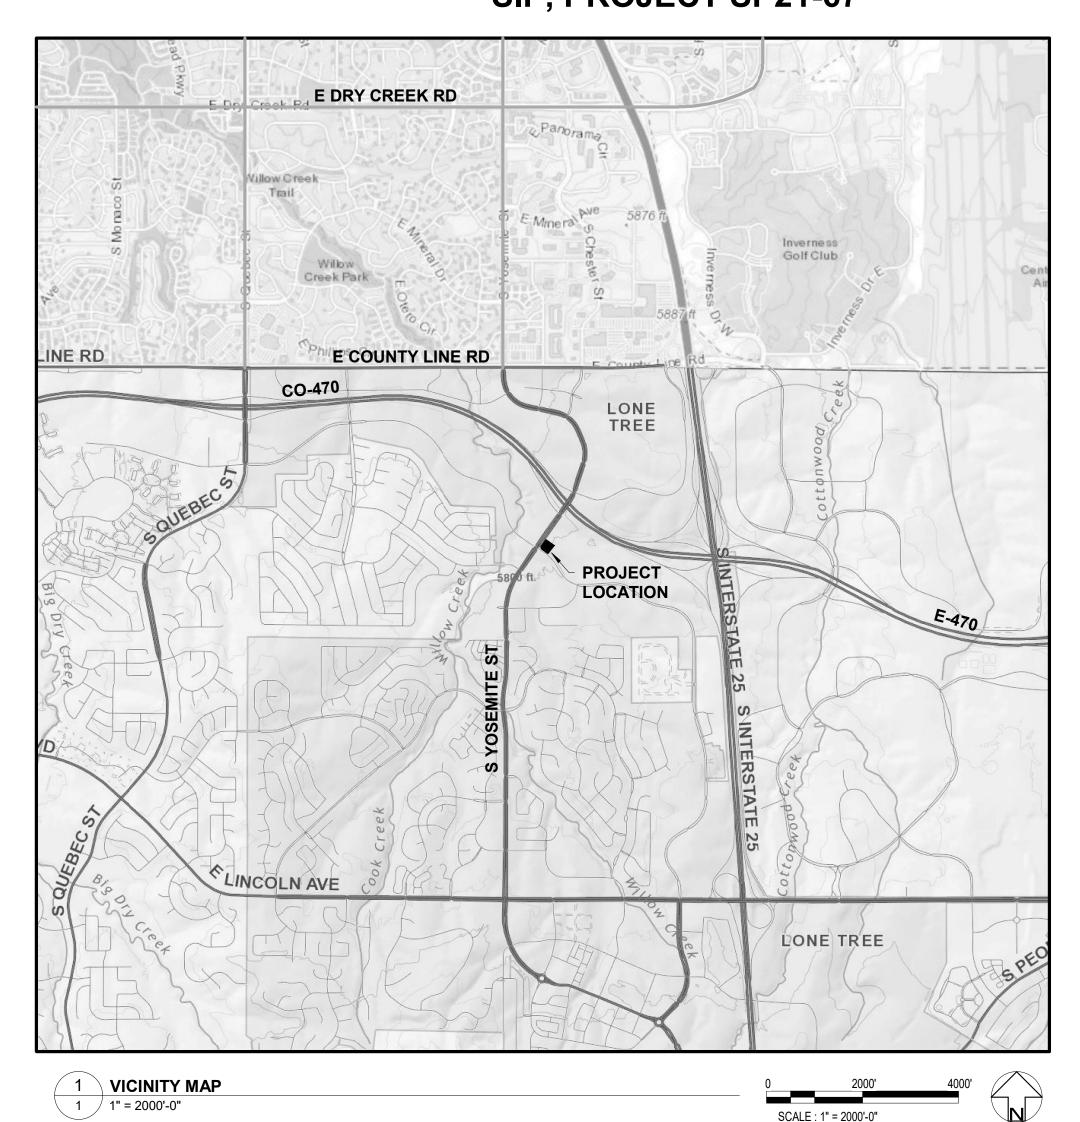

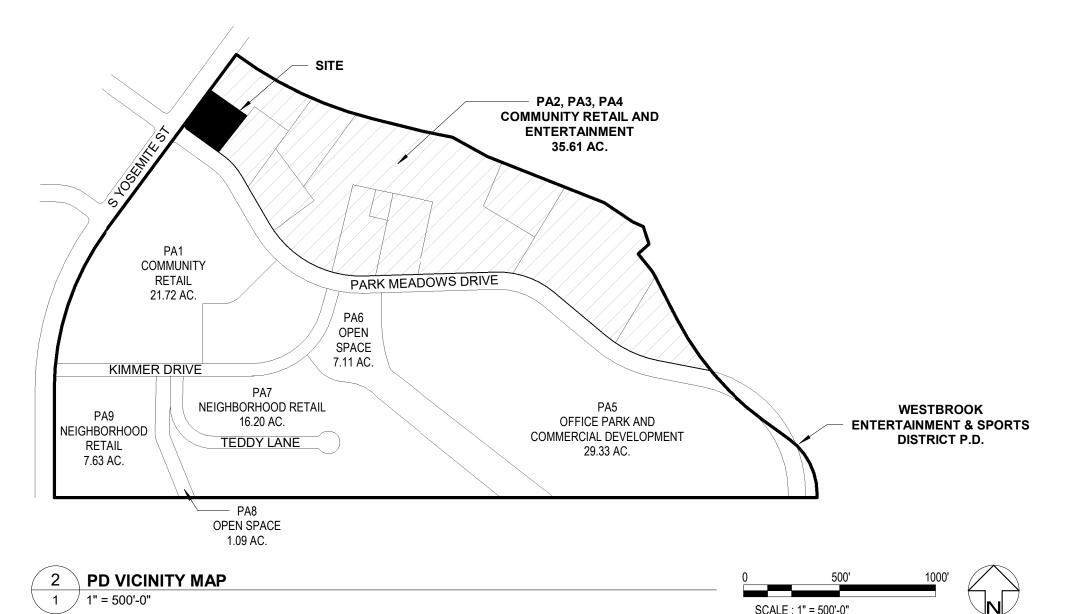

CORNERSTONE CAPITAL
6635 SOUTH DAYTON STREET, UNIT 250
GREENWOOD VILLAGE, CO 80111
PH: 303.956.3455

ADCUITEC

CHAD ROACH

HOVER ARCHITECTURE 385 INVERNESS PKWY, STE 190 ENGLEWOOD, CO 80112 720.534.3013 MARK BRAZEE, AIA, NCARB, LEED AP

LANDSCAPE ARCHITECT

SEVEN 29 DESIGN 5856 S LOWELL BLVD, UNIT 32 #260 LITTLETON, CO 80123 303.883.3278 CHRIS MARCH, PLA

PROOF CIVIL

TITLE: MAYOR

600 GRANT STREET, STE 210 DENVER, CO 80203 303.325.5709 TODD LYON SHEET INDEX

COVER SHEET ARCHITECTURAL SITE PLAN LANDSCAPE PLAN LANDSCAPE DETAILS IRRIGATION PLAN **IRRIGATION DETAILS IRRIGATION DETAILS** GRADING PLAN UTILITY PLAN SITE FURNISHINGS/DETAILS SITE FURNISHINGS/DETAILS PHOTOMETRIC PLAN LIGHTING DETAILS **BUILDING ELEVATIONS BUILDING ELEVATIONS - COLOR** PHOTO RENDERINGS MATERIAL BOARD

APPROVAL CERTIFICATE

(SIGNATURE)

THE OWNER(S) OF THE LANDS DESCRIBED HEREIN, HEREBY AGREE(S) (1) TO DEVELOP AND MAINTAIN THE PROPERTY DESCRIBED HEREON IN ACCORDANCE WITH THIS APPROVED SITE IMPROVEMENT PLAN AND IN COMPLIANCE WITH CHAPTER 16 OF THE LONE TREE MUNICIPAL CODE AND THAT (2) THE HEIRS, SUCCESSORS AND ASSIGNS OF THE OWNER(S) SHALL ALSO BE BOUND. THE SIGNATURES OF THE OWNER(S)'(S) REPRESENTATIVE(S) BELOW INDICATE THAT ANY REQUIRED AUTHORIZATIONS TO ENTER THIS AGREEMENT, INCLUDING ANY CORPORATE AUTHORIZATIONS, HAVE BEEN OBTAINED.

(NAME OF OWNER)

(SIGNATURE OF OWNER)

) SS.
COUNTY OF ________)
SUBSCRIBED AND SWORN TO BEFORE ME THIS _

WITNESS MY HAND AND OFFICIAL SEAL.
MY COMMISSION EXPIRES:
/

NOTARY PUBLIC

APPROVAL BY THE CITY OF LONE TREE DOES NOT SIGNIFY THAT THE REQUIREMENTS OF THE AMERICANS WITH DISABILITIES ACT (ADA) HAVE BEEN SATISFIED. THE OWNER IS RESPONSIBLE TO ENSURE THAT SAID ADA REQUIREMENTS HAVE BEEN MET.

REVISIONS

 08/19/21
 1ST SIP SUBMITTAL

 09/22/21
 2ND SIP SUBMITTAL

 11/18/21
 3RD SIP SUBMITTAL

DATE: 11.18.2021
SCALE: As indicated
DRAWN BY: CLT

CHECKED BY:

HOVER
ARCHITECTUR

385 INVERNESS PKWY, STE 190

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AND INFRINGEMENTS WILL BE ENFORCED AND PROSECUTION

1202.28

ENGLEWOOD, CO 80112 (720) 773-2800

PROJECT NUMBER

CHEE

1 OF 17

COVER SHEET


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WESTBROOK ENTERTAINMENT & SPORTS DISTRICT PD PLANNING AREA PA2/PA3/PA4

1.198 ACRES

SIP, PROJECT SP21-67



SITE DATA TABLE					
ITEM	SQUARE FOOTAGE	% OF GROSS SIT			
GROSS SITE AREA	53,522	100			
BUILDING FOOTPRINT	6,096	11			
PARKING/ROADS (INCLUDING PLANTED INTERIOR PARKING ISLANDS)	31,399	59			
LANDSCAPED AREA (EXCLUDING PLANTED INTERIOR PARKING ISLANDS, TRAILS AND WALKS)	13,167	24			
NATURAL AREAS (NOT INCLUDED IN THE NATURAL LANDSCAPED AREA)	0	0			
HARDSCAPE AREA	3,226	6			
BUILDING SIZE					
MAXIMUM HEIGHT (AS MEASURED BY THE CITY'S BUILDING CODE)	35'-0"				
TOTAL FLOOR AREA (SEE DEFINITION OF FLOOR AREA IN SECTION 16, ARTICLE XXXVI)	6,096 SF				
PARKING					
REQUIRED (1 SPACE PER MAX EMPLOYEE COUNT, PLUS 2 SPACES PER WASH BAY)	7 (5+2)				
PROVIDED	25				
ADA PARKING					
REQUIRED	1				
PROVIDED	2				
BICYCLE PARKING					
REQUIRED	1				
PROVIDED	1				

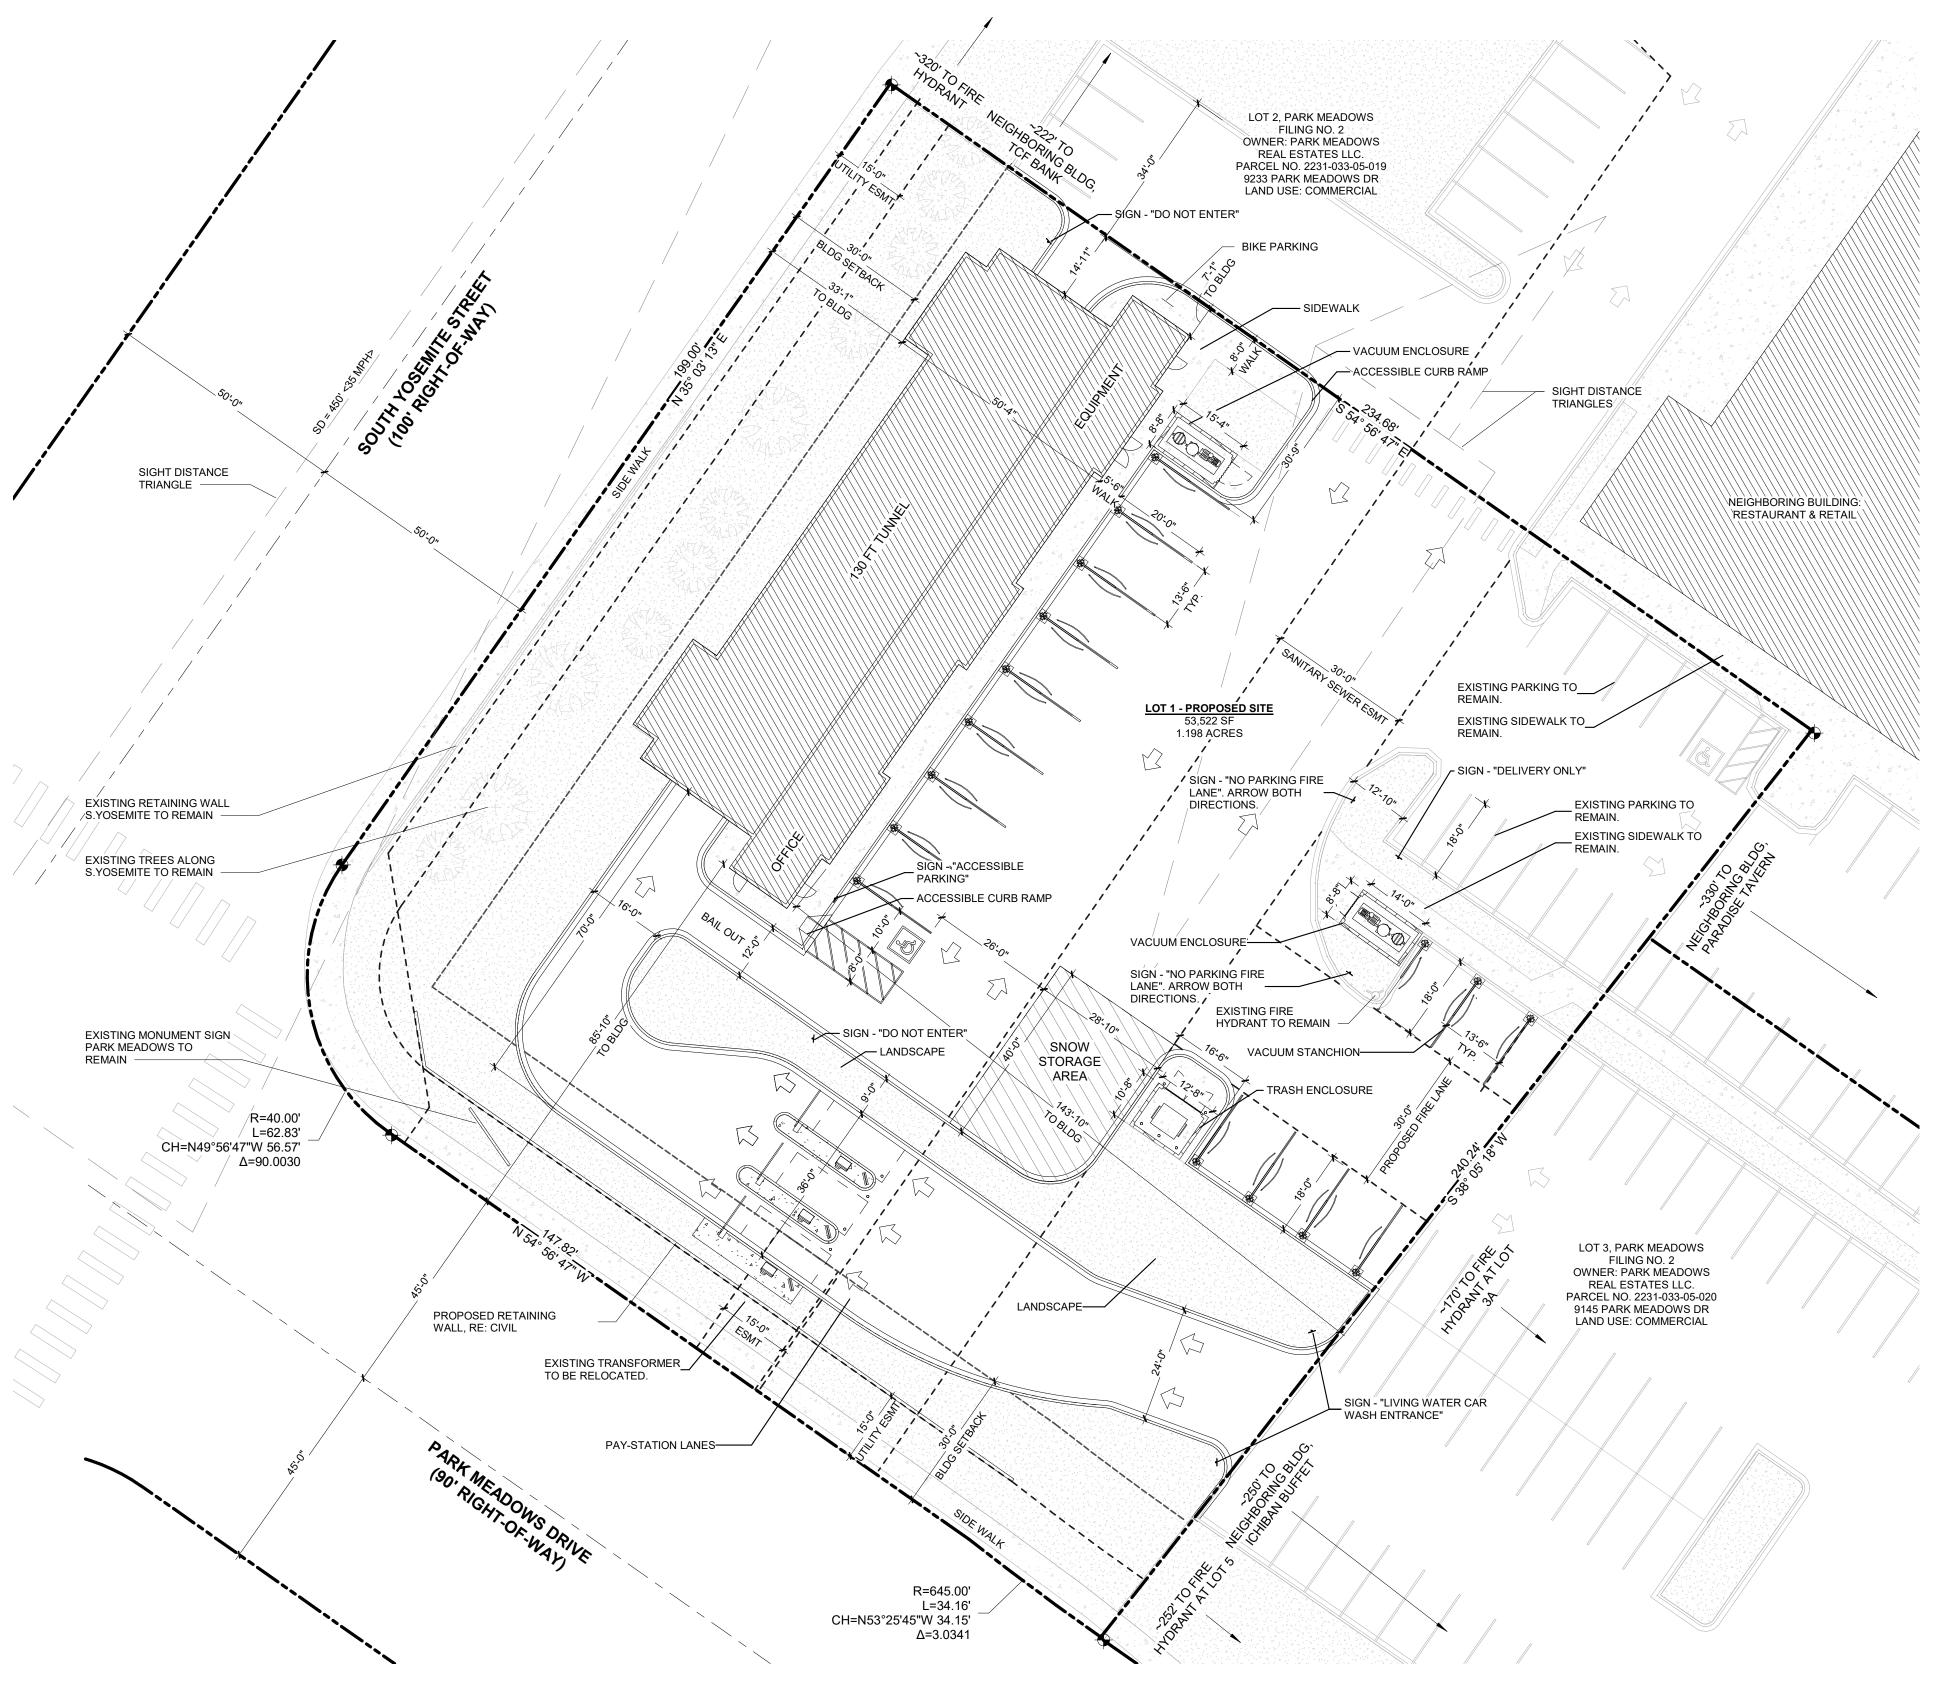REVISIONS

08/19/21 1ST SIP SUBMITTAL 09/22/21 2ND SIP SUBMITTAL 11/18/21 3RD SIP SUBMITTAL

ATE:	11.18.2021
CALE:	1" = 20'-0"
RAWN BY:	CLT
CHECKED BY:	MBB



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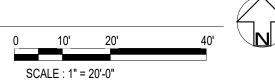
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PROJECT NUMBER

2 OF 17

ARCHITECTURAL SITE PLAN

1 SITE PLAN 2 1" = 20'-0"




WESTBROOK ENTERTAINMENT & SPORTS DISTRICT PD PLANNING AREA PA2/PA3/PA4

1.198 ACRES

SIP, PROJECT SP21-67

SCALE: 1"=20'-0"

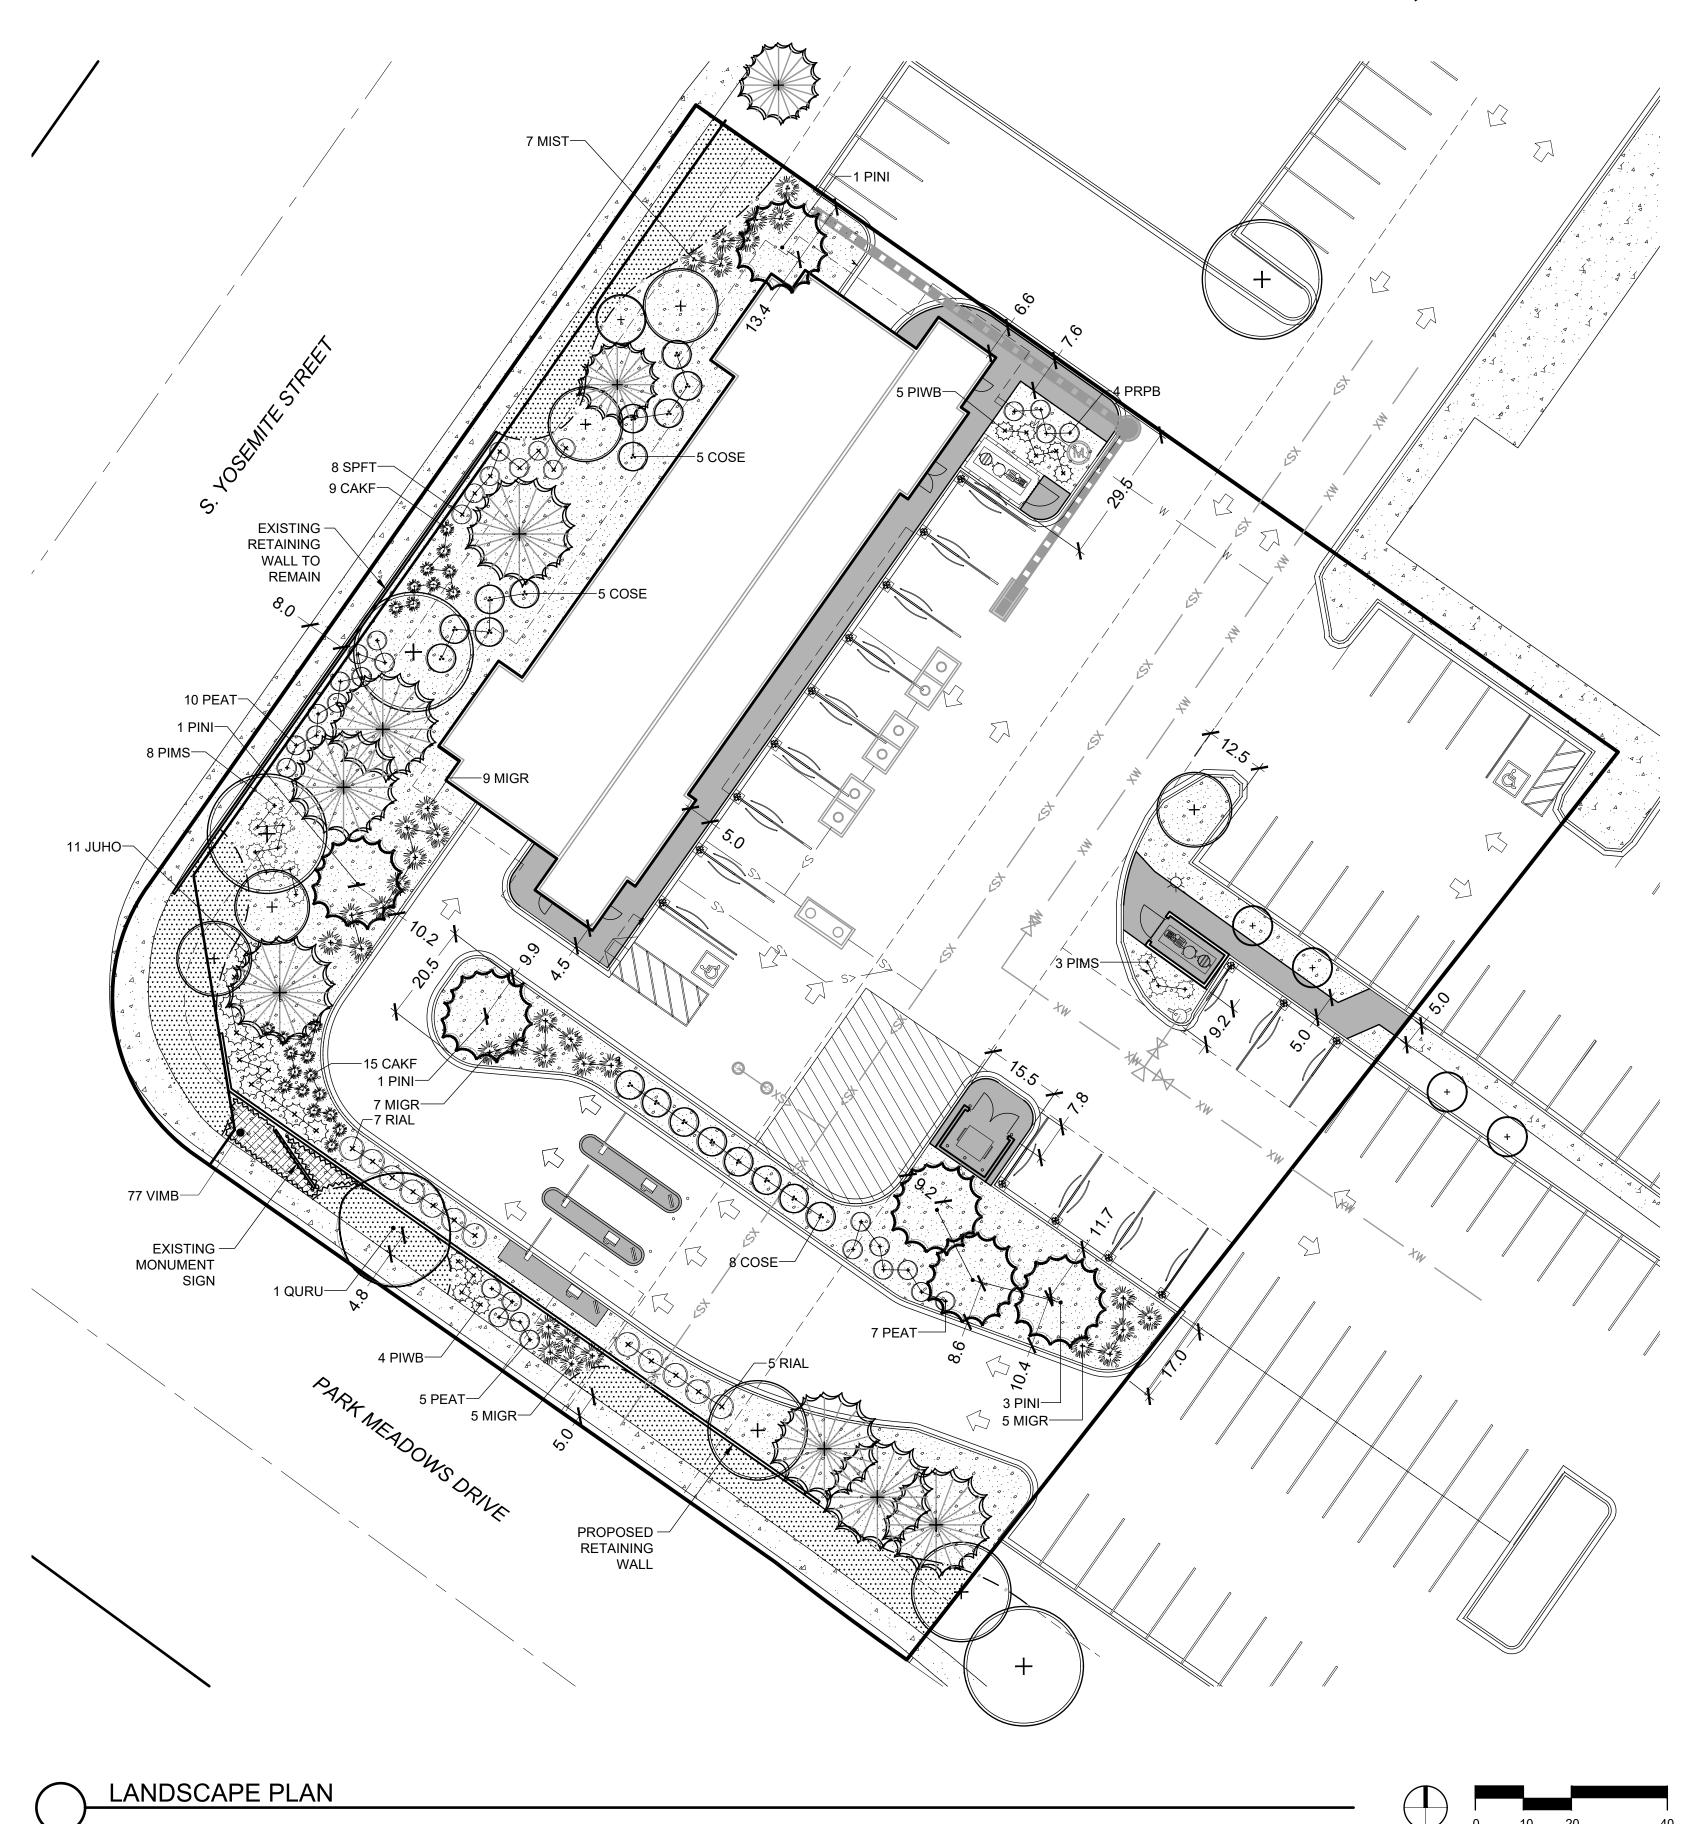

LANDSCAPE CALCULATIONS

DESCRIPTION	TOTAL SITE AREA	REQUIREMENT	AREA REQUIRED	AREA PROVIDED
REQUIRED LANDSCAPE AREA	53,522 SF	15% OF TOTAL SITE AREA	8,028 SF	13,167 SF ⁽¹⁾

NOTES

1. AREA EXCLUDES INTERIOR PLANTED PARKING ISLANDS

LEGEND

SYMBOL	DESCRIPTION	SYMBOL	DESCRIPTION
+	EXISTING DECIDUOUS TREE		ORNAMENTAL GRASS
	EXISTING EVERGREEN TREE		PROPOSED CONCRETE PAVING (GRAY BROOM FINISH)
$\left(\begin{array}{c}\cdot\end{array}\right)$	DECIDUOUS SHADE TREE		EXISTING CONCRETE PAVING
(·)	EVERGREEN TREE	0 0 0	ORGANIC MULCH
(*)	ORNAMENTAL TREE		EXISTING MULCH BED
(x)	DECIDUOUS SHRUBS		TEXAS HYBRID BLUEGRASS SOD
×	EVERGREEN SHRUBS		LANDSCAPE EDGING

PLANT SCHEDULE

							_
DECIDUOUS TREES QURU	QTY 1	BOTANICAL NAME QUERCUS RUBRA	COMMON NAME NORTHERN RED OAK	CONT B & B	<u>CAL</u> 2"CAL	<u>SIZE</u>	
EVERGREEN TREES PINI	QTY 6	BOTANICAL NAME PINUS NIGRA	COMMON NAME AUSTRIAN PINE	CONT B & B	CAL	<u>SIZE</u> 6-8`	
DECIDUOUS SHRUBS COSE PEAT PRPB RIAL SPFT	QTY 18 22 4 12 8	BOTANICAL NAME CORNUS SERICEA 'BAILEYI' PEROVSKIA ATRIPLICIFOLIA PRUNUS BESSEYI 'PAWNEE BUTTES' RIBES ALPINUM SPIRAEA FRITSCHIANA	COMMON NAME RED TWIG DOGWOOD RUSSIAN SAGE PAWNEE BUTTES SAND CHERRY ALPINE CURRANT FRITCH SPIREA	CONT 5 GAL 5 GAL 5 GAL 5 GAL 5 GAL			
EVERGREEN SHRUBS JUHO PIMS PIWB	QTY 11 11 9	BOTANICAL NAME JUNIPERUS HORIZONTALIS 'BLUE CHIP' PINUS MUGO 'SLOWMOUND' PINUS MUGO 'WHITEBUD'	COMMON NAME BLUE CHIP JUNIPER SLOWMOUND MUGO PINE WHITEBUD MUGO PINE	CONT 5 GAL 5 GAL 5 GAL			
ORNAMENTAL GRASS CAKF MIGR MIST	QTY 24 26 7	BOTANICAL NAME CALAMAGROSTIS ACUTIFLORA 'KARL FOERSTER' MISCANTHUS SINENSIS 'GRACILLIMUS' MISCANTHUS SINENSIS 'STRICTUS'	COMMON NAME FEATHER REED GRASS MAIDEN GRASS ZEBRA GRASS	CONT 5 GAL 5 GAL 5 GAL			
GROUNDCOVERS VIMB	<u>QTY</u> 77	BOTANICAL NAME VINCA MINOR `BOWLES VARIETY`	COMMON NAME BOWLES COMMON PERIWINKLE	CONT @ 1 GAL		18	,"



DEVISIONS

08/19/21 1ST SIP SUBMITTAL 09/22/21 2ND SIP SUBMITTAL 11/18/21 3RD SIP SUBMITTAL

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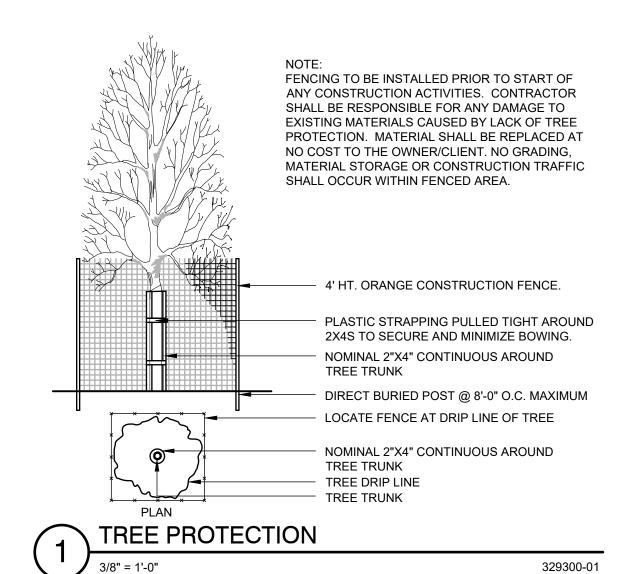
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SHEET

LANDSCAPE PLAN

3 OF 17

WESTBROOK ENTERTAINMENT & SPORTS DISTRICT PD PLANNING AREA PA2/PA3/PA4 1.198 ACRES SIP, PROJECT SP21-67



CUT AND REMOVE ALL TWINE WRAPPING

(3) 12 GAUGE GALV. GUY WIRES AT+/- 36" ABOVE GRADE W/ ½ DIA. X 18" P.V.C. PIPE ON EACH WIRE.

(3) $2\frac{1}{2}$ " DIA STAKE, DRIVE (MIN 24") FIRMLY INTO SUBGRADE PRIOR TO BACKFILLING. PLANT SO THAT TOP OF ROOT BALL IS 2" ABOVE FINISHED GRADE. PLACE FERTILIZER PER SPECS PRIOR TO MULCH APPLICATION. FEATHER MULCH TO TREE TRUNK. APPLY CEDAR MULCH WITH A 3' DIA. MULCH RING WHEN LOCATED IN GRASS OR SEED AREAS. KEEP MULCH FROM CONTACTING TRUNK OF TREE. → FORM SAUCER W/ 3" CONT. RIM.

AND BURLAP FROM TOP HALF OF BALL. CUT AND REMOVE ALL TWINE/WIRE BASKET FROM ROOTBALL. WATER AND TAMP POCKETS TO REMOVE AIR BUBBLES. BACKFILL PLANT PIT WITH AMENDED SOIL PER SPECIFICATIONS — 3" TAMPED TOPSOIL.

SCARIFY EXISTING SOIL TO 4" DEPTH.

329343.39-07

1. DO NOT CUT LEADER. PRUNE ALL DAMAGED OR DEAD WOOD AFTER PLANTING, STAKING 2. KEEP CROWN SHAPE TYPICAL OF SPECIES.

3. REMOVE ALL PLANTING LABELS AFTER FINAL ACCEPTANCE BY LANDSCAPE ARCHITECT. 4. REFER TO PLANTING SPECIFICATIONS FOR FULL DESCRIPTION OF INSTALLATION

MULTI-STEM TREE PLANTING

AND BURLAP FROM TOP HALF OF BALL.

PROTECTIVE CAP, DRIVE (MIN 24") FIRMLY INTO SUBGRADE PRIOR TO BACKFILLING. (2) 12 GAUGE GALV. GUY WIRES AT 3'-0" ABOVE GRADE W/ 1/2" DIA. X 18" P.V.C. PIPE ON EACH WIRE. - PLANT SO THAT TOP OF ROOT BALL IS 2" ABOVE FINISHED GRADE. - PLACE FERTILIZER PER SPECS PRIOR TO MULCH APPLICATION. APPLY CEDAR

MULCH WITH A 3' DIA. MULCH RING WHEN LOCATED IN GRASS OR SEED AREAS. KEEP MULCH FROM CONTACTING TRUNK MULCH AS SPECIFIED, FORM SAUCER W/ 3" CONT. RIM. - CUT AND REMOVE ALL TWINE WRAPPING

 CUT AND REMOVE ALL TWINE/WIRE BASKET FROM ROOTBALL. SCARIFY EXISTING SOIL TO 4" DEPTH. WATER AND TAMP POCKETS TO REMOVE

1. DO NOT CUT LEADER. PRUNE ALL DAMAGED OR DEAD WOOD AFTER PLANTING, STAKING

2. KEEP CROWN SHAPE TYPICAL OF SPECIES. 3. REMOVE ALL PLANTING LABELS AFTER FINAL ACCEPTANCE BY LANDSCAPE ARCHITECT. 4. REFER TO PLANTING SPECIFICATIONS FOR FULL DESCRIPTION OF INSTALLATION PROCEDURES TO BE FOLLOWED.

DECIDUOUS TREE


329300-02

PLANT SO THAT TOP OF ROOTBALL IS LEVEL W/ FINISH GRADE PLACE SPECIFIED FERTILIZER PRIOR TO MULCH APPLICATION. FEATHER MULCH TO BASE OF SHRUB BRANCHES. FORM W/ 3" CONTINUOUS RIM. — WATER AND TAMP POCKETS TO REMOVE AIR. BACKFILL PLANT PIT WITH AMENDED SOIL PER SPECIFICATIONS REMOVE ALL CONTAINER MATERIAL. PLACE OVER UNDISTURBED SOIL. UNDISTURBED SOIL. VAR. ROOTBALL + 12"

1. DO NOT CUT LEADER. PRUNE ALL DAMAGED OR DEAD WOOD AFTER PLANTING, STAKING & MULCHING.

2. KEEP CROWN SHAPE TYPICAL OF SPECIES. 3. REMOVE ALL PLANTING LABELS AFTER FINAL ACCEPTANCE BY LANDSCAPE 4. REFER TO PLANTING SPECIFICATIONS FOR FULL DESCRIPTION OF INSTALLATION

SHRUB / ORNAMENTAL GRASS PLANTING

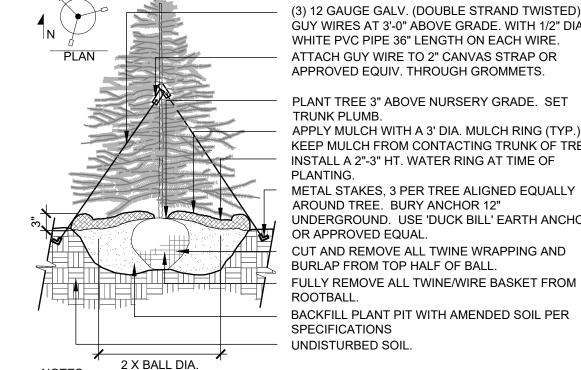

(3) 12 GAUGE GALV. (DOUBLE STRAND TWISTED) GUY WIRES AT 3'-0" ABOVE GRADE. WITH 1/2" DIA. WHITE PVC PIPE 36" LENGTH ON EACH WIRE. ATTACH GUY WIRE TO 2" CANVAS STRAP OR APPROVED EQUIV. THROUGH GROMMETS.

PLANT TREE 3" ABOVE NURSERY GRADE. SET TRUNK PLUMB. APPLY MULCH WITH A 3' DIA. MULCH RING (TYP.) KEEP MULCH FROM CONTACTING TRUNK OF TREE. INSTALL A 2"-3" HT. WATER RING AT TIME OF PLANTING.

AROUND TREE. BURY ANCHOR 12" UNDERGROUND. USE 'DUCK BILL' EARTH ANCHOR OR APPROVED EQUAL CUT AND REMOVE ALL TWINE WRAPPING AND BURLAP FROM TOP HALF OF BALL. FULLY REMOVE ALL TWINE/WIRE BASKET FROM

BACKFILL PLANT PIT WITH AMENDED SOIL PER SPECIFICATIONS

329300-03


UNDISTURBED SOIL.

1. DO NOT CUT LEADER. PRUNE ALL DAMAGED OR DEAD WOOD AFTER PLANTING, STAKING AND MULCHING.


2. KEEP CROWN SHAPE TYPICAL OF SPECIES.

3. REMOVE ALL PLANTING LABELS AFTER FINAL ACCEPTANCE BY LANDSCAPE ARCHITECT 4. REFER TO PLANTING SPECIFICATIONS FOR FULL DESCRIPTION OF INSTALLATION PROCEDURES TO BE FOLLOWED.

EVERGREEN TREE PLANTING

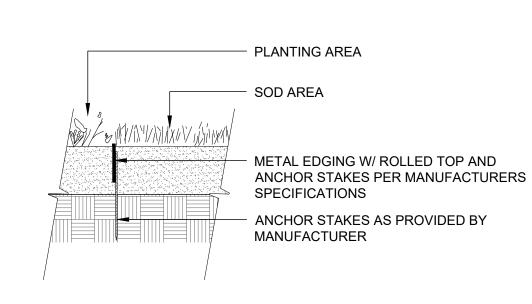

1. EDGING SHALL ABUT ALL CONCRETE CURBS AND WALKS AT PERPENDICULAR ANGLE AND FLUSH W/ GRADES OF CONCRETE. ALL OVERLAPPING JOINTS TO BE SECURELY STAKED

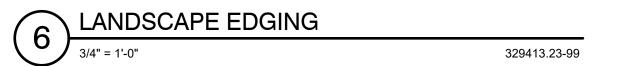



REVISIONS

08/19/21 1ST SIP SUBMITTAL 09/22/21 2ND SIP SUBMITTAL 11/18/21 3RD SIP SUBMITTAL

11.18.2021 As indicated DRAWN BY: CHECKED BY:




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PROJECT NUMBER

LANDSCAPE **DETAILS**

WESTBROOK ENTERTAINMENT & SPORTS DISTRICT PD PLANNING AREA PA2/PA3/PA4 **1.198 ACRES** SIP, PROJECT SP21-67

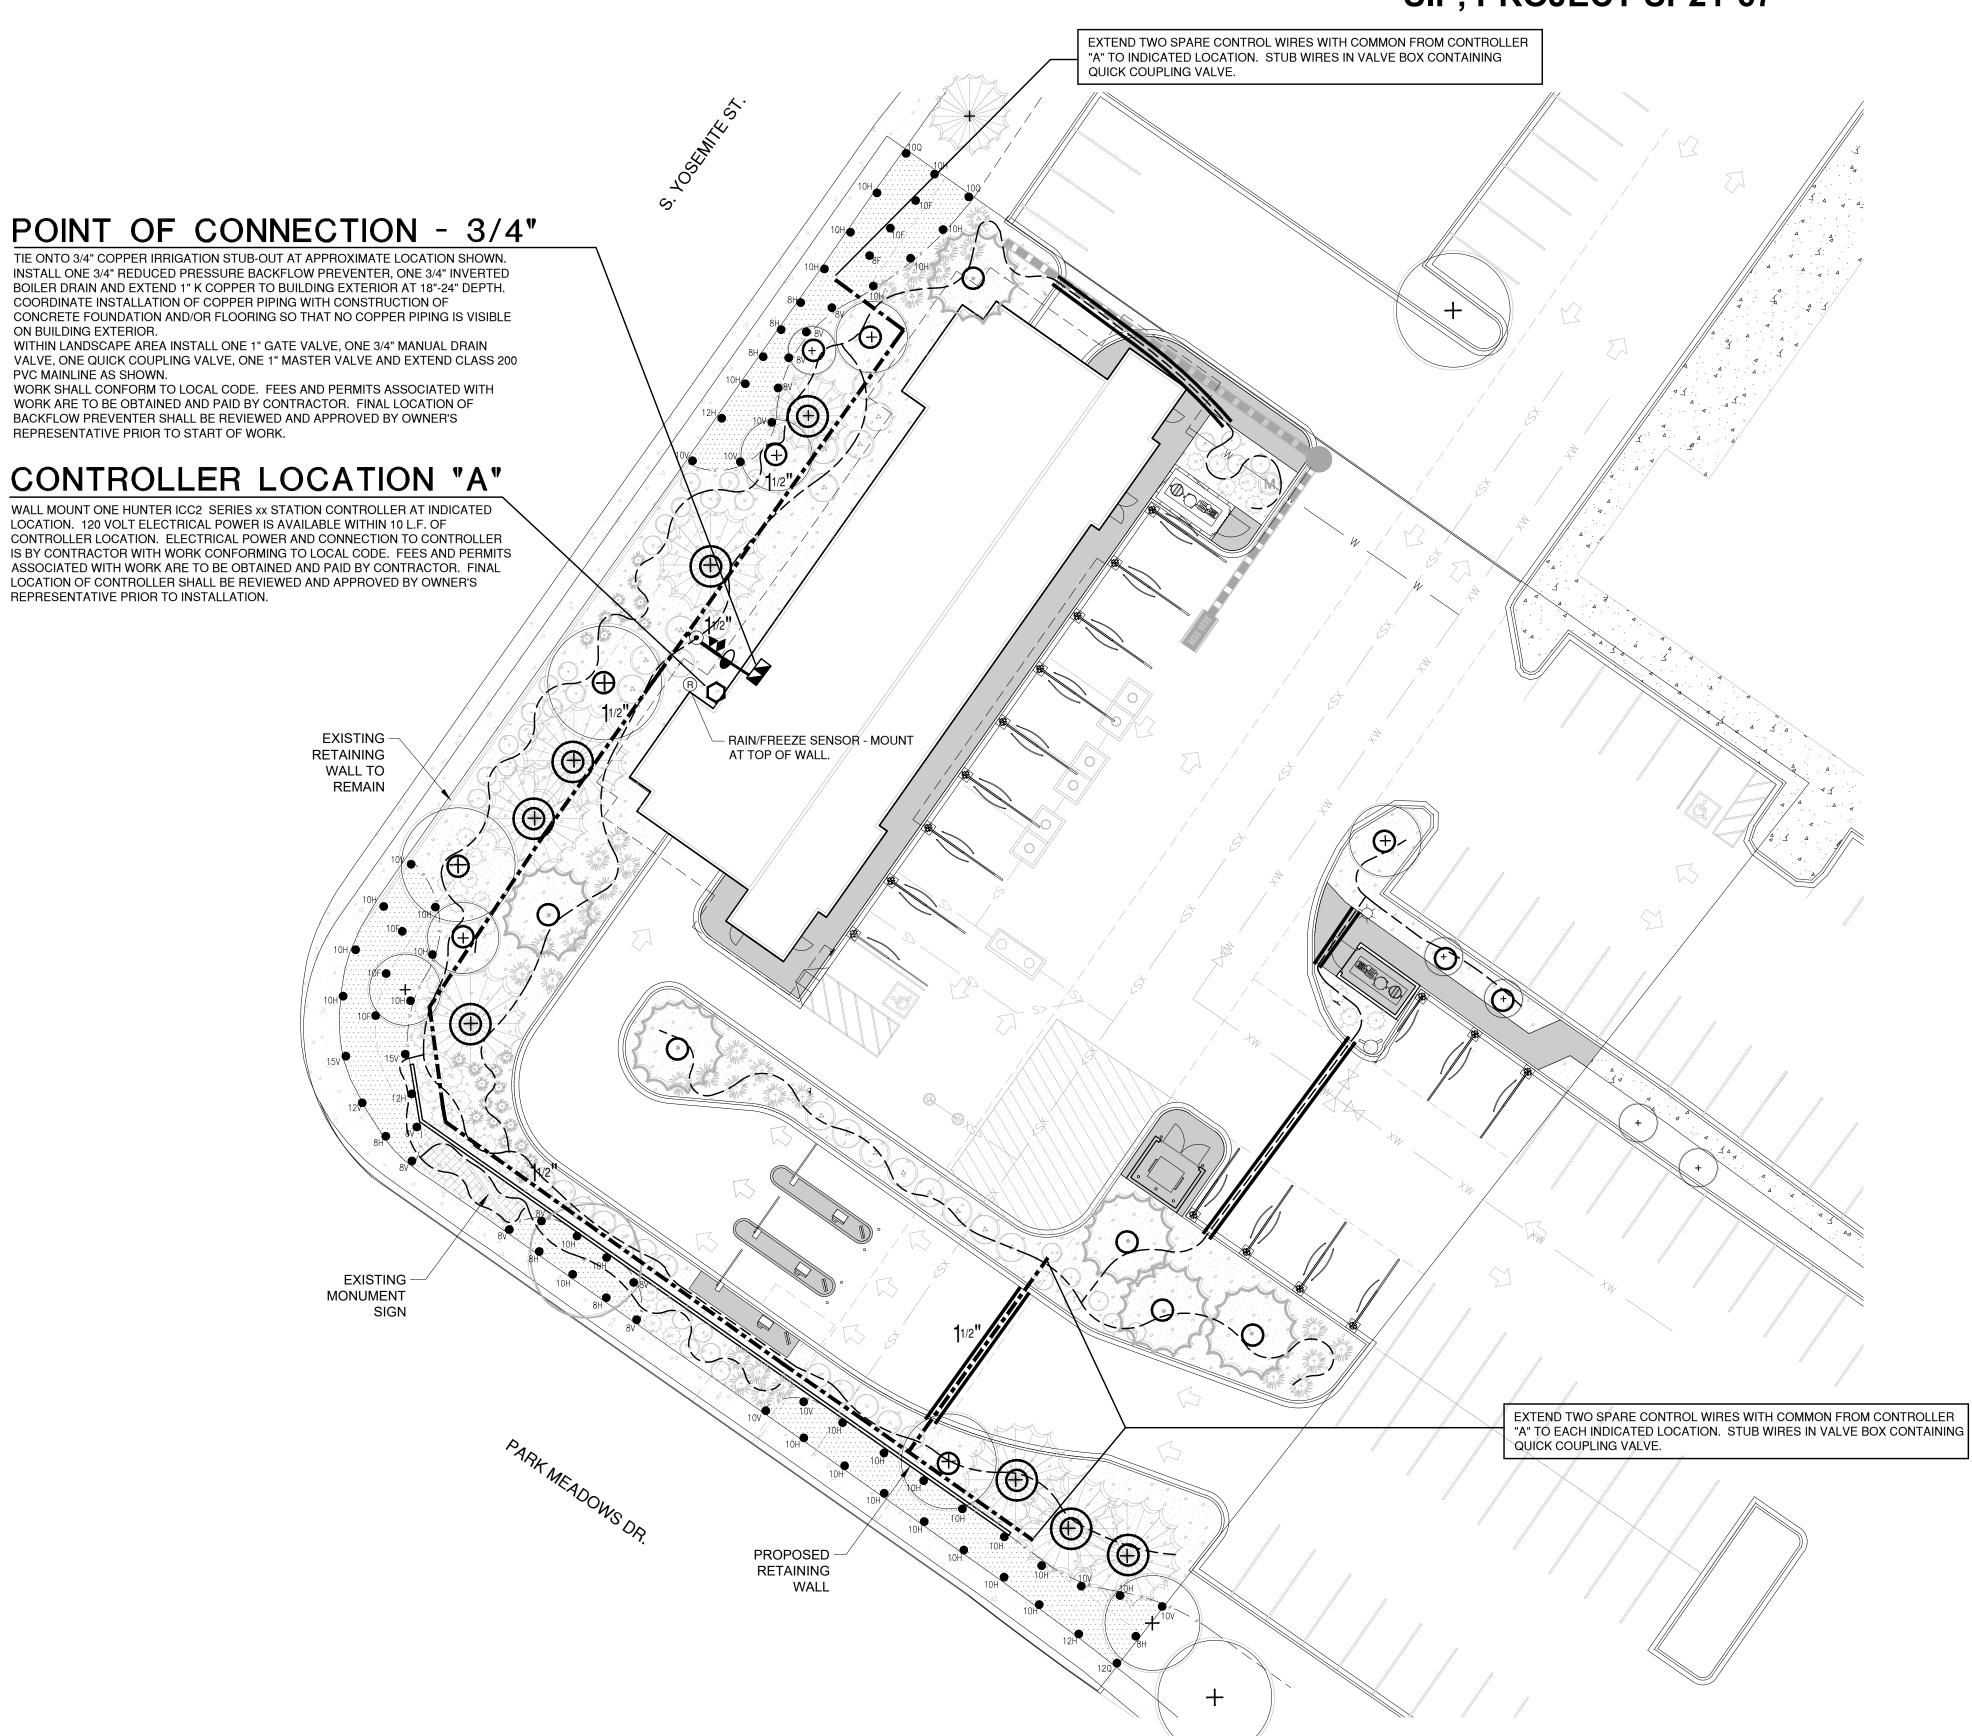

SYMBOL	MANUFACTURER	MODEL NO.	DESCRIPTION	DETAIL NO.	COMMENTS
• x	RAIN BIRD	RD06-S-P30-F W/ HE-VAN NOZZ.	POP-UP SPRAY HEAD	1	
R	HUNTER	WFR-CLIK	WIRELESS RAIN/FREEZE SENSOR	10	
•	RAIN BIRD	PEB SERIES - 1" DIA.	MASTER VALVE	6	
*		3/4" DIA.	MANUAL DRAIN VALVE	4	
▼	RAIN BIRD	44 LRC	QUICK COUPLING VALVE	5	
•	RAIN BIRD	PEB SERIES	ELECTRIC CONTROL VALVE	3	
0	HUNTER	I2C SERIES	ELECTRIC CONTROLLER	9	
•	NIBCO	T113K - LINE SIZE	GATE VALVE	7	
	FEBCO	860 - 3/4" DIA.	BACKFLOW PREVENTER	2	
		LINE SIZE	DRIP LINE BLOW-OUT STUB	13	
\oplus	RAIN BIRD	XCZ-100-PRB-LC	DRIP VALVE ASSEMBLY	14	
<u> </u>	CENTENNIAL PLASTICS	3/4" I.D.	POLY DRIP TUBING	11	
		CLASS 200 SOLVENT WELD	PVC SLEEVING		
		CLASS 200 SOLVENT WELD - 1" DIA UNLESS NOTED OTHERWISE	a. PVC LATERAL	8	
		CLASS 200 SOLVENT WELD	PVC MAINLINE	8	
0	RAIN BIRD	XFCV-09-12	IN-LINE DRIP TREE RING	12	

Irrigation Construction Notes

- 1. ALL BASE INFORMATION HAS BEEN TAKEN FROM DRAWINGS PREPARED BY SEVEN 29
- 2. REFER TO TECHNICAL SPECIFICATIONS AND CONSTRUCTION DETAILS FOR INSTALLATION PROCEDURES.
- 3. CONTRACTOR SHALL FIELD VERIFY PRESSURE AT BACKFLOW PREVENTER LOCATION FOR EACH TAP PRIOR TO ORDERING MATERIALS OR STARTING ANY IRRIGATION INSTALLATION AND NOTIFY CONSULTANT OF ANY DIFFERENCES FROM STATED RESPONSIBILITY FOR ANY SYSTEM ALTERATIONS. EACH SYSTEM HAS BEEN DESIGNED FOR A STATIC PRESSURE OF XXX PSI.

4. CONTRACTOR SHALL COORDINATE INSTALLATION OF SLEEVING WITH INSTALLATION OF CONCRETE FLATWORK AND PAVING. ALL SLEEVING IS BY CONTRACTOR UNLESS OTHERWISE NOTED. UNLESS NOTED OTHERWISE ON IRRIGATION PLANS INSTALL SLEEVING BASED ON SLEEVE SIZING GUIDE BELOW:

PIPE SIZE OR WIRE QUANTITY REQUIRED SLEEVE 3/4" - 1-1/4" PIPING 1-2" PVC SLEEVE 1-4" PVC SLEEVE 1-1/2" - 2" PIPING 1-25 CONTROL WIRES 1-2" PVC SLEEVE

NOTE: EACH LENGTH OF SLEEVED PIPE SHOWN SHALL BE ROUTED THROUGH SEPARATE SLEEVE. IRRIGATION WIRE BUNDLE SHALL BE ROUTED IN SEPARATE SLEEVE/CONDUIT WITHOUT IRRIGATION PIPING

- 5. WHERE NOT NOTED ON IRRIGATION PLANS CONTRACTOR TO INSTALL PLASTIC 15 SERIES NOZZLES ON POP-UP SPRAY HEADS SPACED GREATER THAN 12 FEET. INSTALL 12 SERIES NOZZLES ON POP-UP SPRAY HEADS SPACED 10-12 FEET. INSTALL 10 SERIES NOZZLES ON ALL POP-UP SPRAY HEADS SPACED 8-10 FEET. INSTALL 8 SERIES NOZZLES ON POP-UP SPRAY HEADS SPACED 8 FEET AND LESS.
- 6. REFER TO PLANTING PLAN FOR EXACT TREE LOCATIONS AND QUANTITIES, TREES SHOWN ON IRRIGATION PLANS ARE APPROXIMATE.
- 7. CONTRACTOR SHALL REPAIR OF REPLACE ANY EXISTING IRRIGATION EQUIPMENT, TURF, PLANT MATERIAL OR SITE FEATURES DAMAGED DURING NEW INSTALLATION. REPLACEMENT OR REPAIR OF DAMAGED EQUIPMENT OR MATERIAL SHALL BE DETERMINED BY THE OWNER AND THE CONSULTANT.
- 8. VALVE BOXES SHALL BE LOCATED 36" MINIMUM FROM CENTERLINE OF ALL SWALES, 24" MINIMUM FROM EDGES OF ALL WALKS, CURBS, DRIVES AND OTHER HARD SURFACE
- 9. REFER TO IRRIGATION TECHNICAL SPECIFICATIONS FOR PLANTING AND IRRIGATION LAY-OUT REQUIREMENTS, COORDINATION AND PRIORITIES.
- 10. LATERAL PIPING DIAMETERS SHALL INCLUDE 1". 3/4" AND 1 1/4" DIAMETER LATERAL PIPE IS NOT ACCEPTABLE.
- 11. CONTRACTOR IS RESPONSIBLE TO WINTERIZE THE IRRIGATION SYSTEM IN THE FALL OF THE YEAR IN WHICH THE IRRIGATION & LANDSCAPE WAS ACCEPTED. CONTRACTOR SHALL ALSO PERFORM SYSTEM START-UP IN APRIL OF THE FOLLOWING SPRING.
- 12. ALL IRRIGATION WIRE SHALL BE #14 AWG UFUL WIRE WITH SINGLE, SOLID COPPER CONDUCTOR AND POLYETHYLENE INSULATION (MULTI-CONDUCTOR WIRE IS NOT WIRE COLORS SHALL BE: CONTROL WIRES - RED, COMMON WIRE - WHITE, SPARE WIRES - BLACK,
- MASTER VALVE BLUE. WATERTIGHT WIRE SPLICES SHALL BE MADE WITH 3M CO. DBR/Y-6 SPLICE KITS.
- 13. ALL VALVE BOXES SHALL BE MANUFACTURED BY CARSON INDUSTRIES. MODELS #910-10: QUICK COUPLING VALVES, DRIP LINE BLOW-OUT STUBS, GATE VALVES, DRAIN #1419-12: ELECTRIC CONTROL VALVES.
- #1220-12: DRIP VALVES ASSEMBLIES, FLOW SENSOR, MASTER VALVE BOXES AND LIDS SHALL BE GREEN.
- 14. CONTRACTOR SHALL WARRANTY ALL WORK (MATERIALS, EQUIPMENT AND WORKMANSHIP) FOR A ONE YEAR PERIOD FOLLOWING FINAL ACCEPTANCE OF LANDSCAPE AND IRRIGATION BY OWNER.



REVISIONS

08/19/21 1ST SIP SUBMITTAL 09/22/21 2ND SIP SUBMITTAL 11/18/21 3RD SIP SUBMITTAL

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(720) 773-2800

PROJECT NUMBER

IRRIGATION

IRRIGATION DESIGN


7114 W. JEFFERSON AVENUE, SUITE LAKEWOOD, COLORADO 80235





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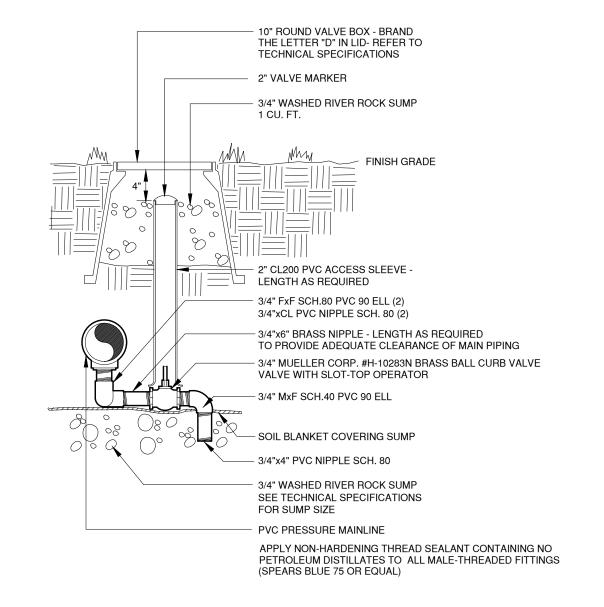


WESTBROOK ENTERTAINMENT & SPORTS DISTRICT PD PLANNING AREA PA2/PA3/PA4 1.198 **ACRES**




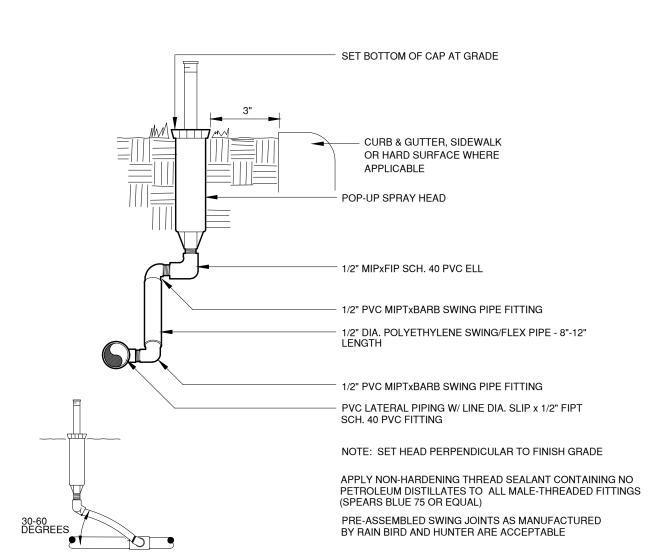

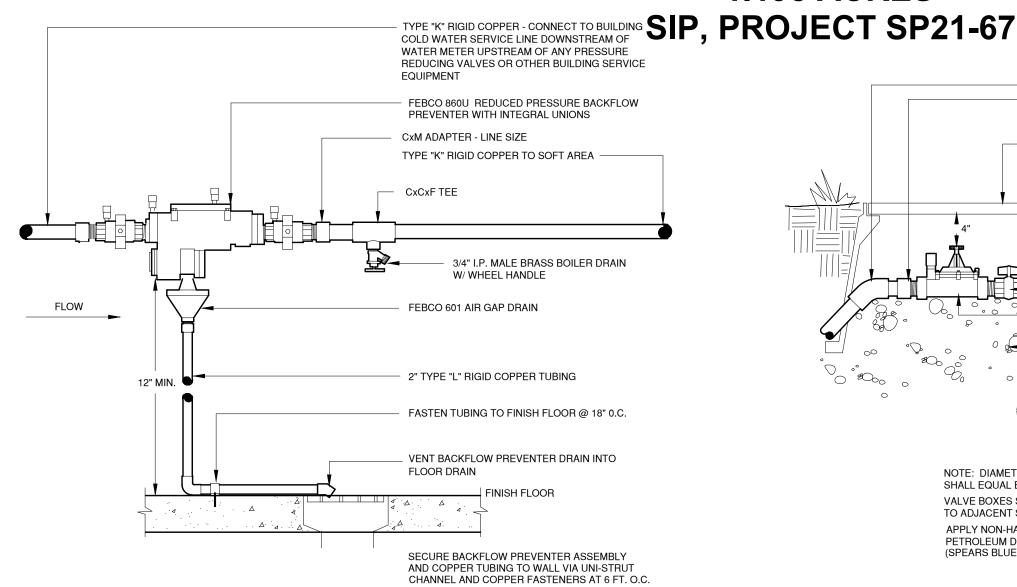


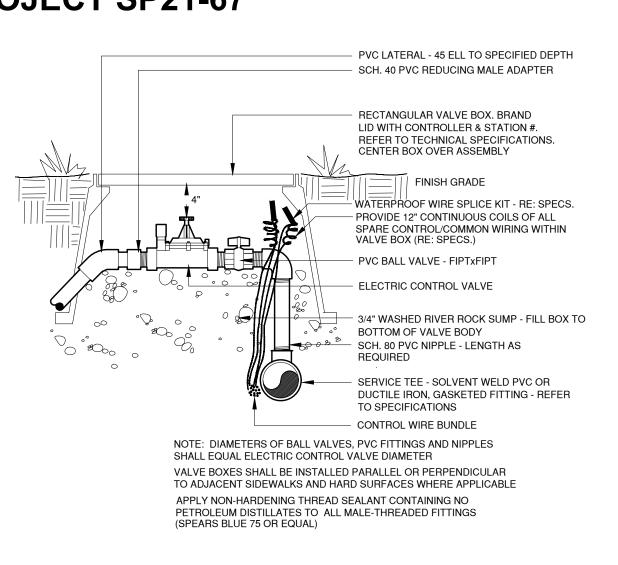




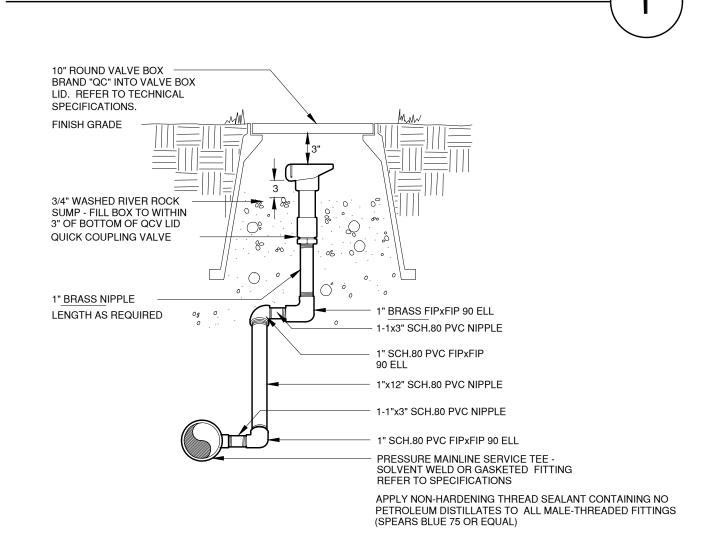




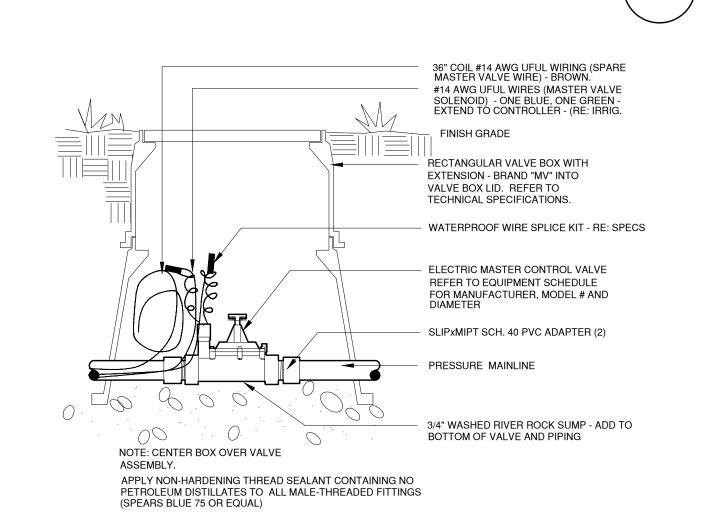

ELECTRIC CONTROL VALVE

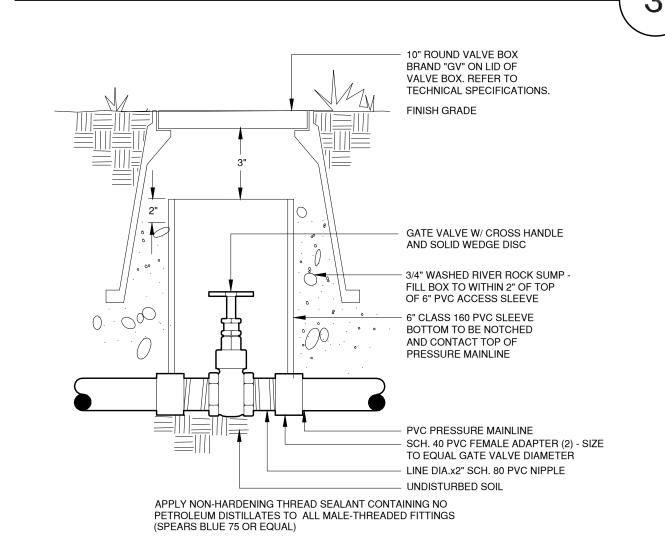

MANUAL DRAIN VALVE

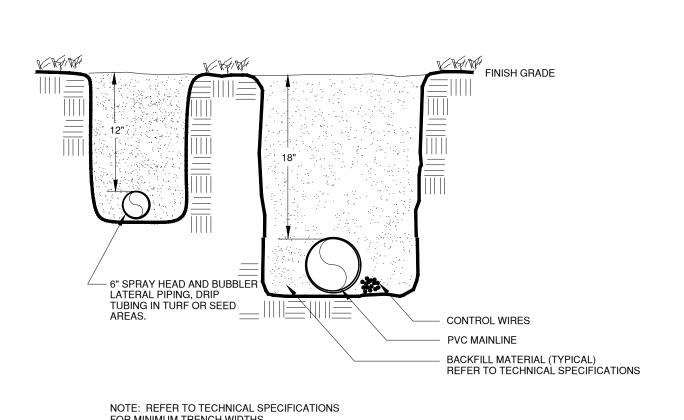




REVISIONS

08/19/21 1ST SIP SUBMITTAL 2ND SIP SUBMITTAL 11/18/21 3RD SIP SUBMITTAL

QUICK COUPLING VALVE

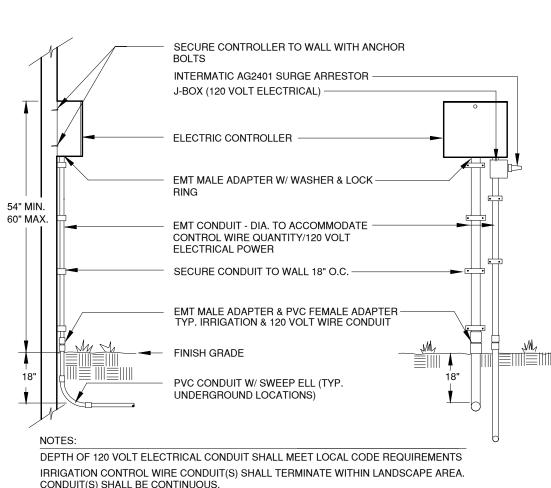


120 VOLT ELECTRICAL WIRING SHALL NOT BE ROUTED THROUGH IRRIGATION WIRE

ELECTRIC CONTROLLER

AND/OR ANY OBSTRUCTIONS HUNTER ADJUSTABLE LENGTH MOUNTING SECURE BRACKET VIA WOOD SCREWS OR SIMILAR BUILDING EAVE, FENCE POST, ETC. NOTE: MOUNT RAIN SENSOR RECEIVER WITHIN CONTROLLER PEDESTAL FINAL LOCATION OF SENSOR SHALL BE APPROVED BY OWNER PRIOR TO INSTALLATION.


GATE VALVE

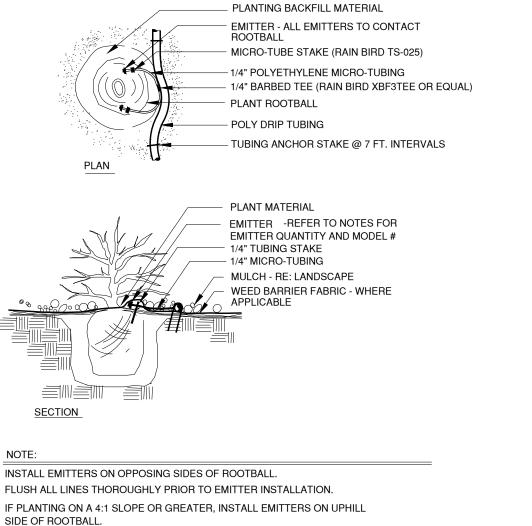

INSTALL TWO 1/2 GPH EMITTERS PER 5 GAL. SHRUB, ONE 1/2 GPH EMITTER PER 1 GAL. PLANT

SHRUB AND PERENNIAL PLANTINGS IN BED AREAS

TRENCHES

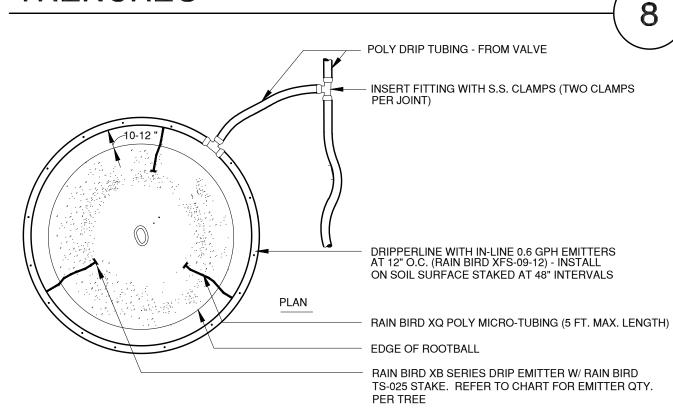

PLANT SIZE	EMITTER FLOW RATE	EMITTER QTY. AT MULCHED BED LOCATION
1 1/2" CALIPER TREE	1.0 GPH	THREE EACH
2" CALIPER TREE	1.0 GPH	FOUR EACH
2 1/2" CALIPER TREE	1.0 GPH	SIX EACH
6 FT. CONIFEROUS TREE	1.0 GPH	FOUR EACH
8 FT. CONIFEROUS TREE	1.0 GPH	SIX EACH

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SIZE	EMITTER FLOW RATE	EMITTER QTY. AT MULCHED BED LOCATIONS
R TREE	1.0 GPH	THREE EACH
REE	1.0 GPH	FOUR EACH
R TREE	1.0 GPH	SIX EACH
ROUS TREE	1.0 GPH	FOUR EACH

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TREE RING DRIP ASSEMBLY

IRRIGATION

RAIN/FREEZE SENSOR


MASTER VALVE

DRIP EMITTER


WESTBROOK ENTERTAINMENT & SPORTS DISTRICT PD PLANNING AREA PA2/PA3/PA4

1.198 ACRES

SIP, PROJECT SP21-67

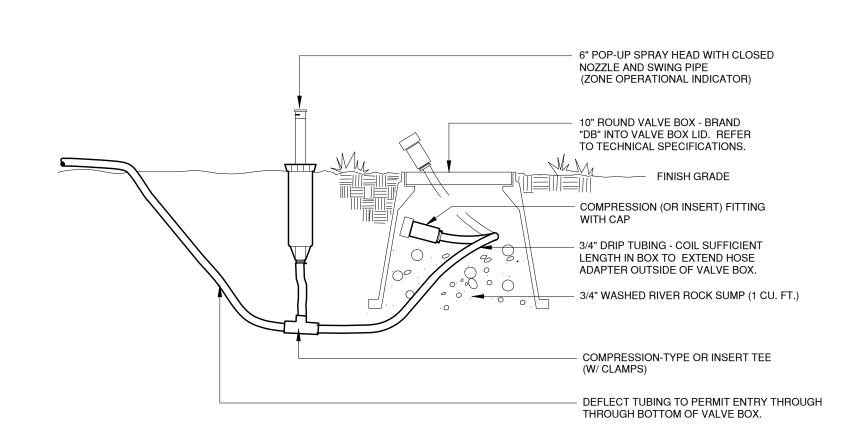

DRIP LINE FLUSH-OUT AND
OPERATIONAL INDICATOR

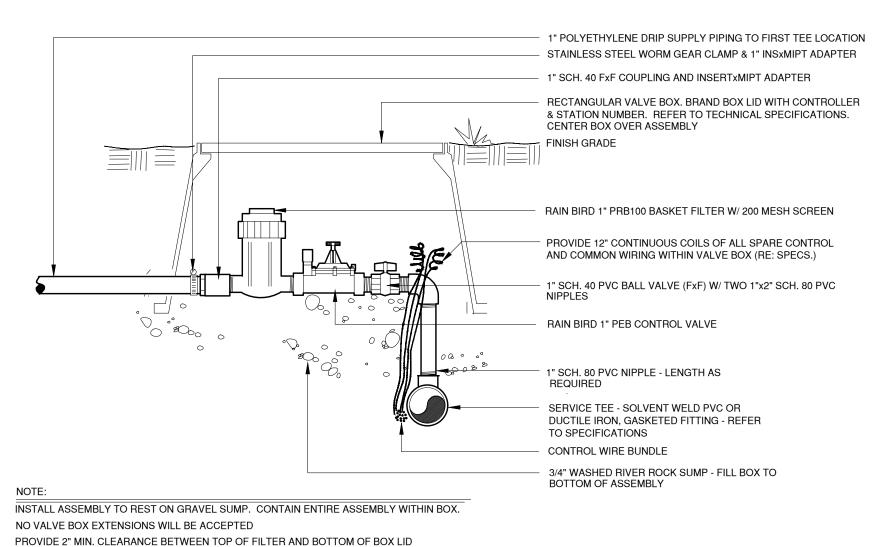

TOP OF VALVE BOX TO BE FLUSH WITH FINISH GRADE
VALVE BOX SHALL NOT REST ON DRIP TUBING/PIPING
APPLY NON-HARDENING THREAD SEALANT CONTAINING NO
PETROLEUM DISTILLATES TO ALL MALE-THREADED FITTINGS
(SPEARS BLUE 75 OR EQUAL)

DRIP VALVE ASSEMBLY

(14



DEVISION

08/19/21 1ST SIP SUBMITTAL 09/22/21 2ND SIP SUBMITTAL 11/18/21 3RD SIP SUBMITTAL

DAIE.	11.10.2021
SCALE:	As indicated
DRAWN BY:	DZ
CHECKED BY:	DZ
H	VER

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(720) 773-2800

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ARCHITECTURE

D INFRINGEMENTS WILL BE ENFORCED AND PI

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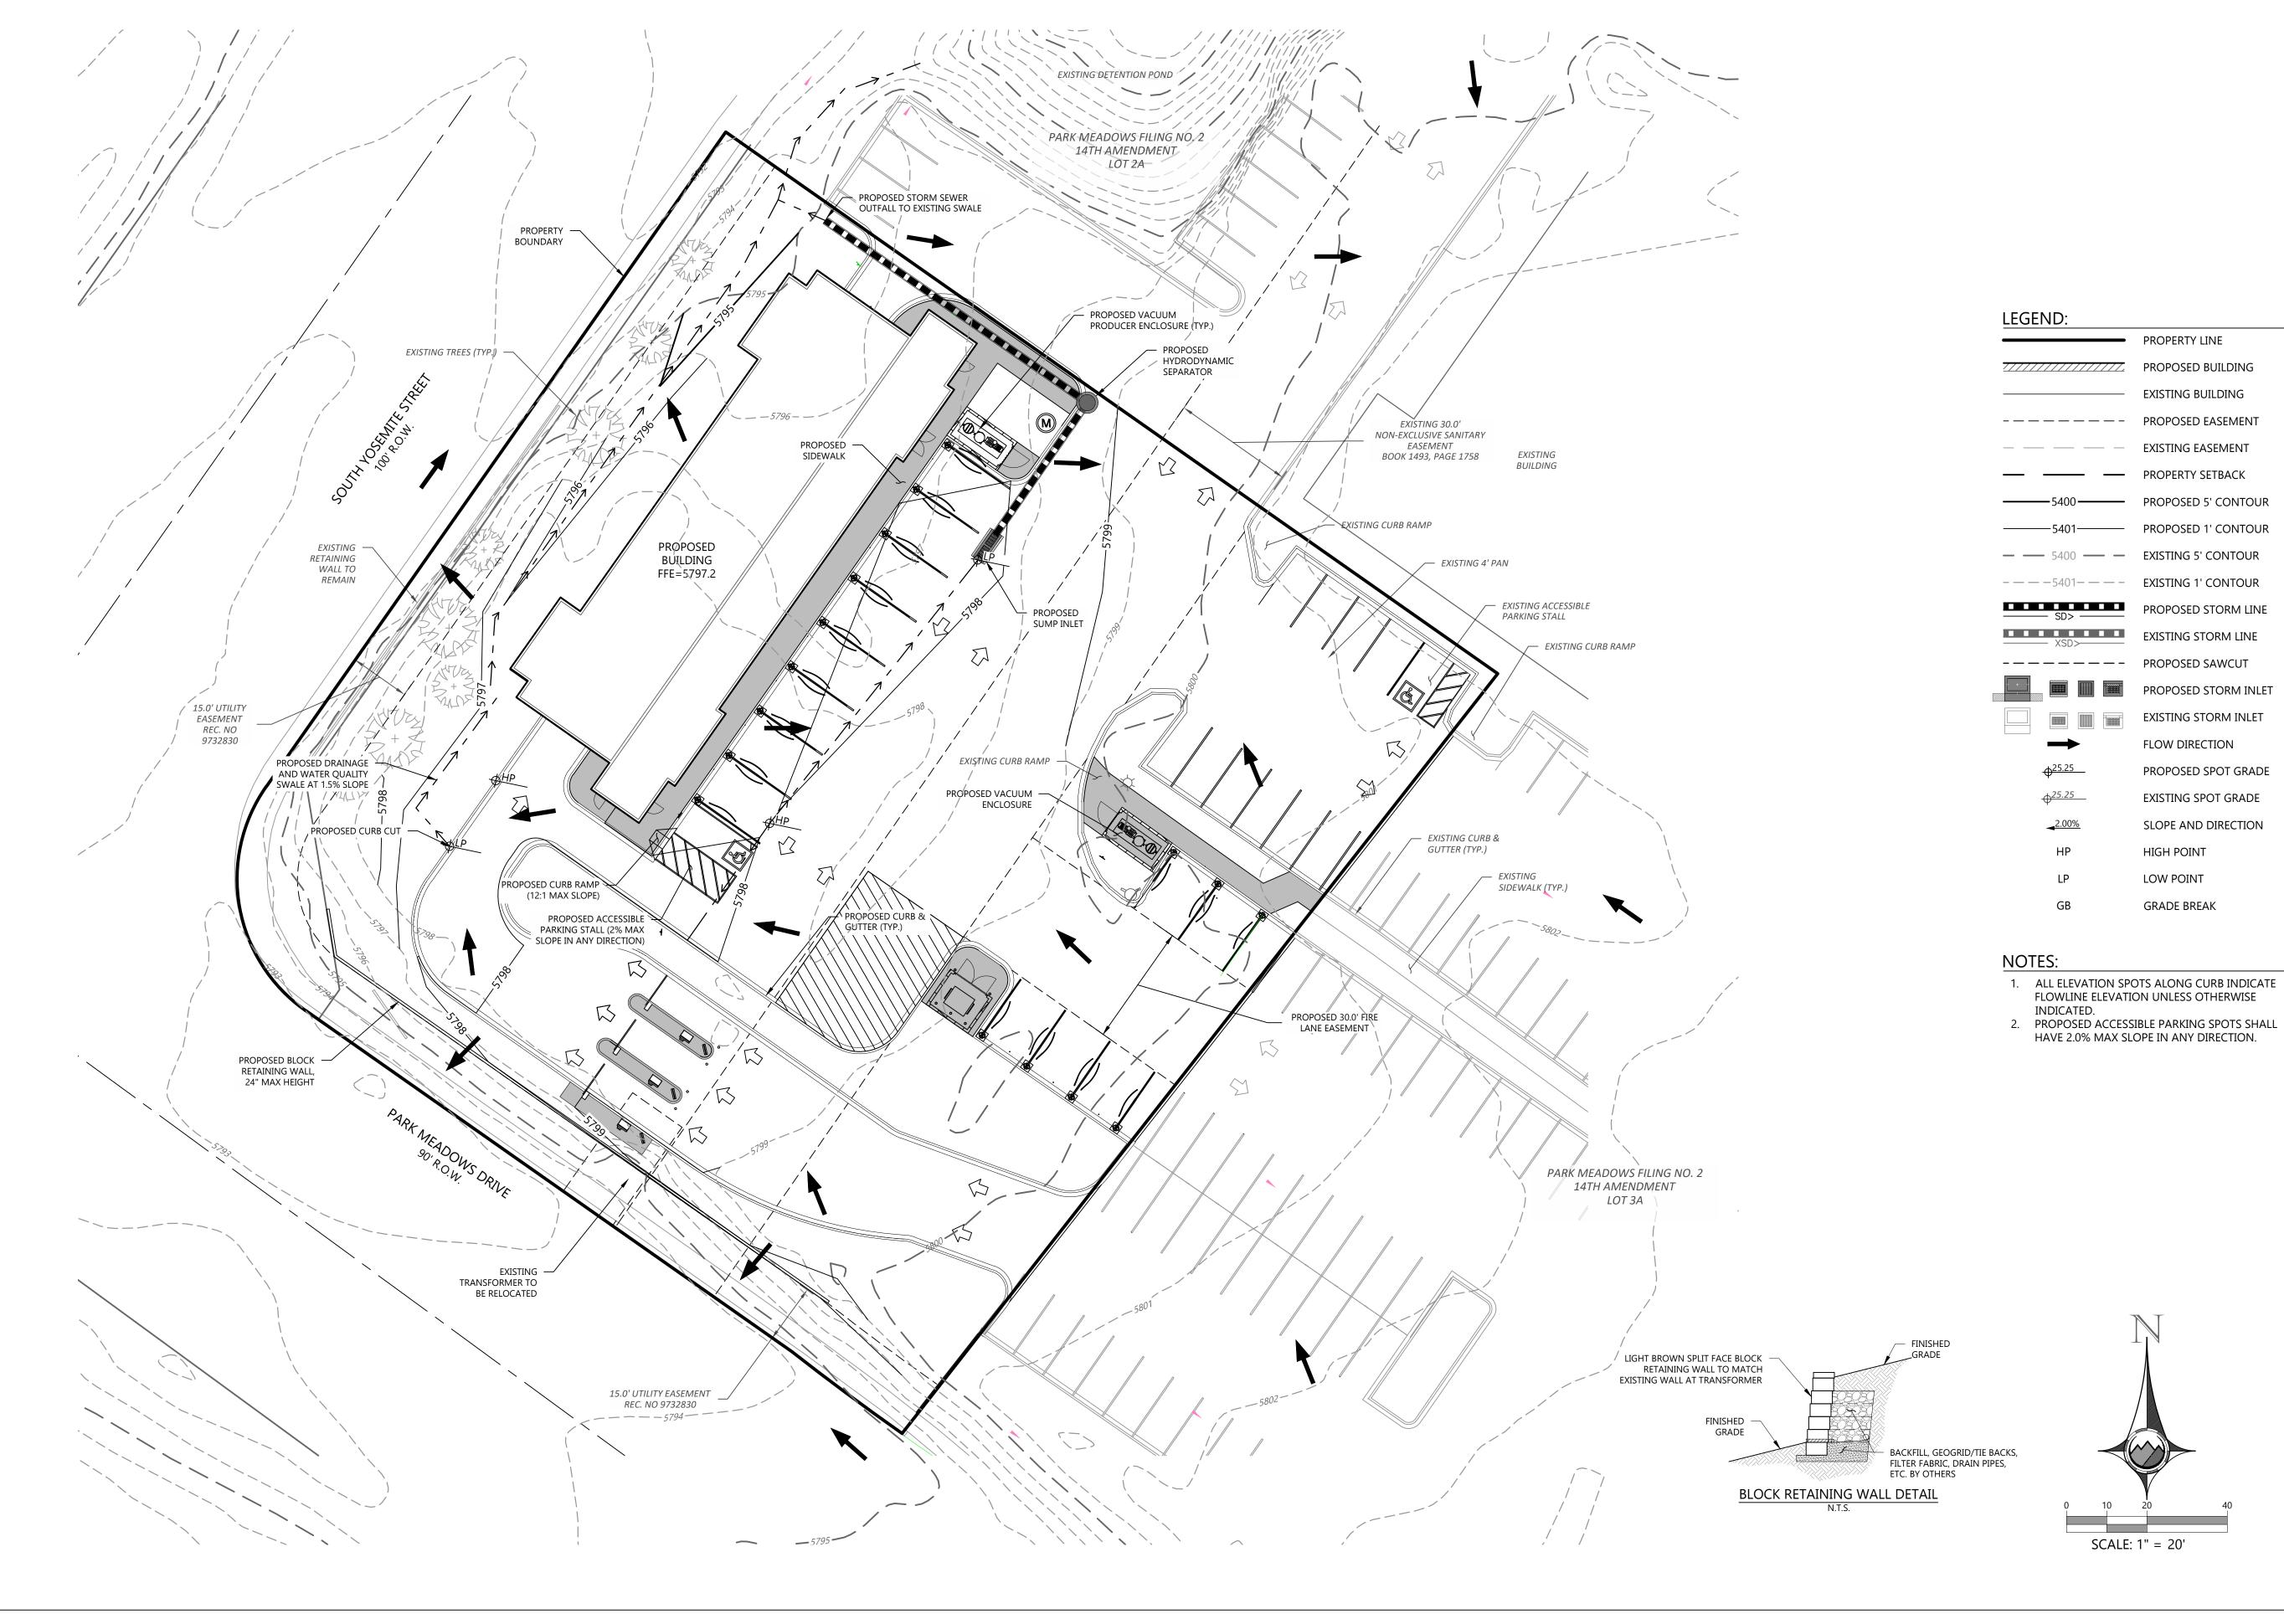
IRRIGATION DESIGN

7114 W. JEFFERSON AVENUE, SUITE 201 LAKEWOOD, COLORADO 80235 VOICE: 303.986.2175 FAX: 303.989.5814 IRRIGATION PLAN

WESTBROOK ENTERTAINMENT & SPORTS DISTRICT PD PLANNING AREA PA2/PA3/PA4

1.198 ACRES

SIP, PROJECT SP21-67



08/19/2021 1ST SIP SUBMITTAL

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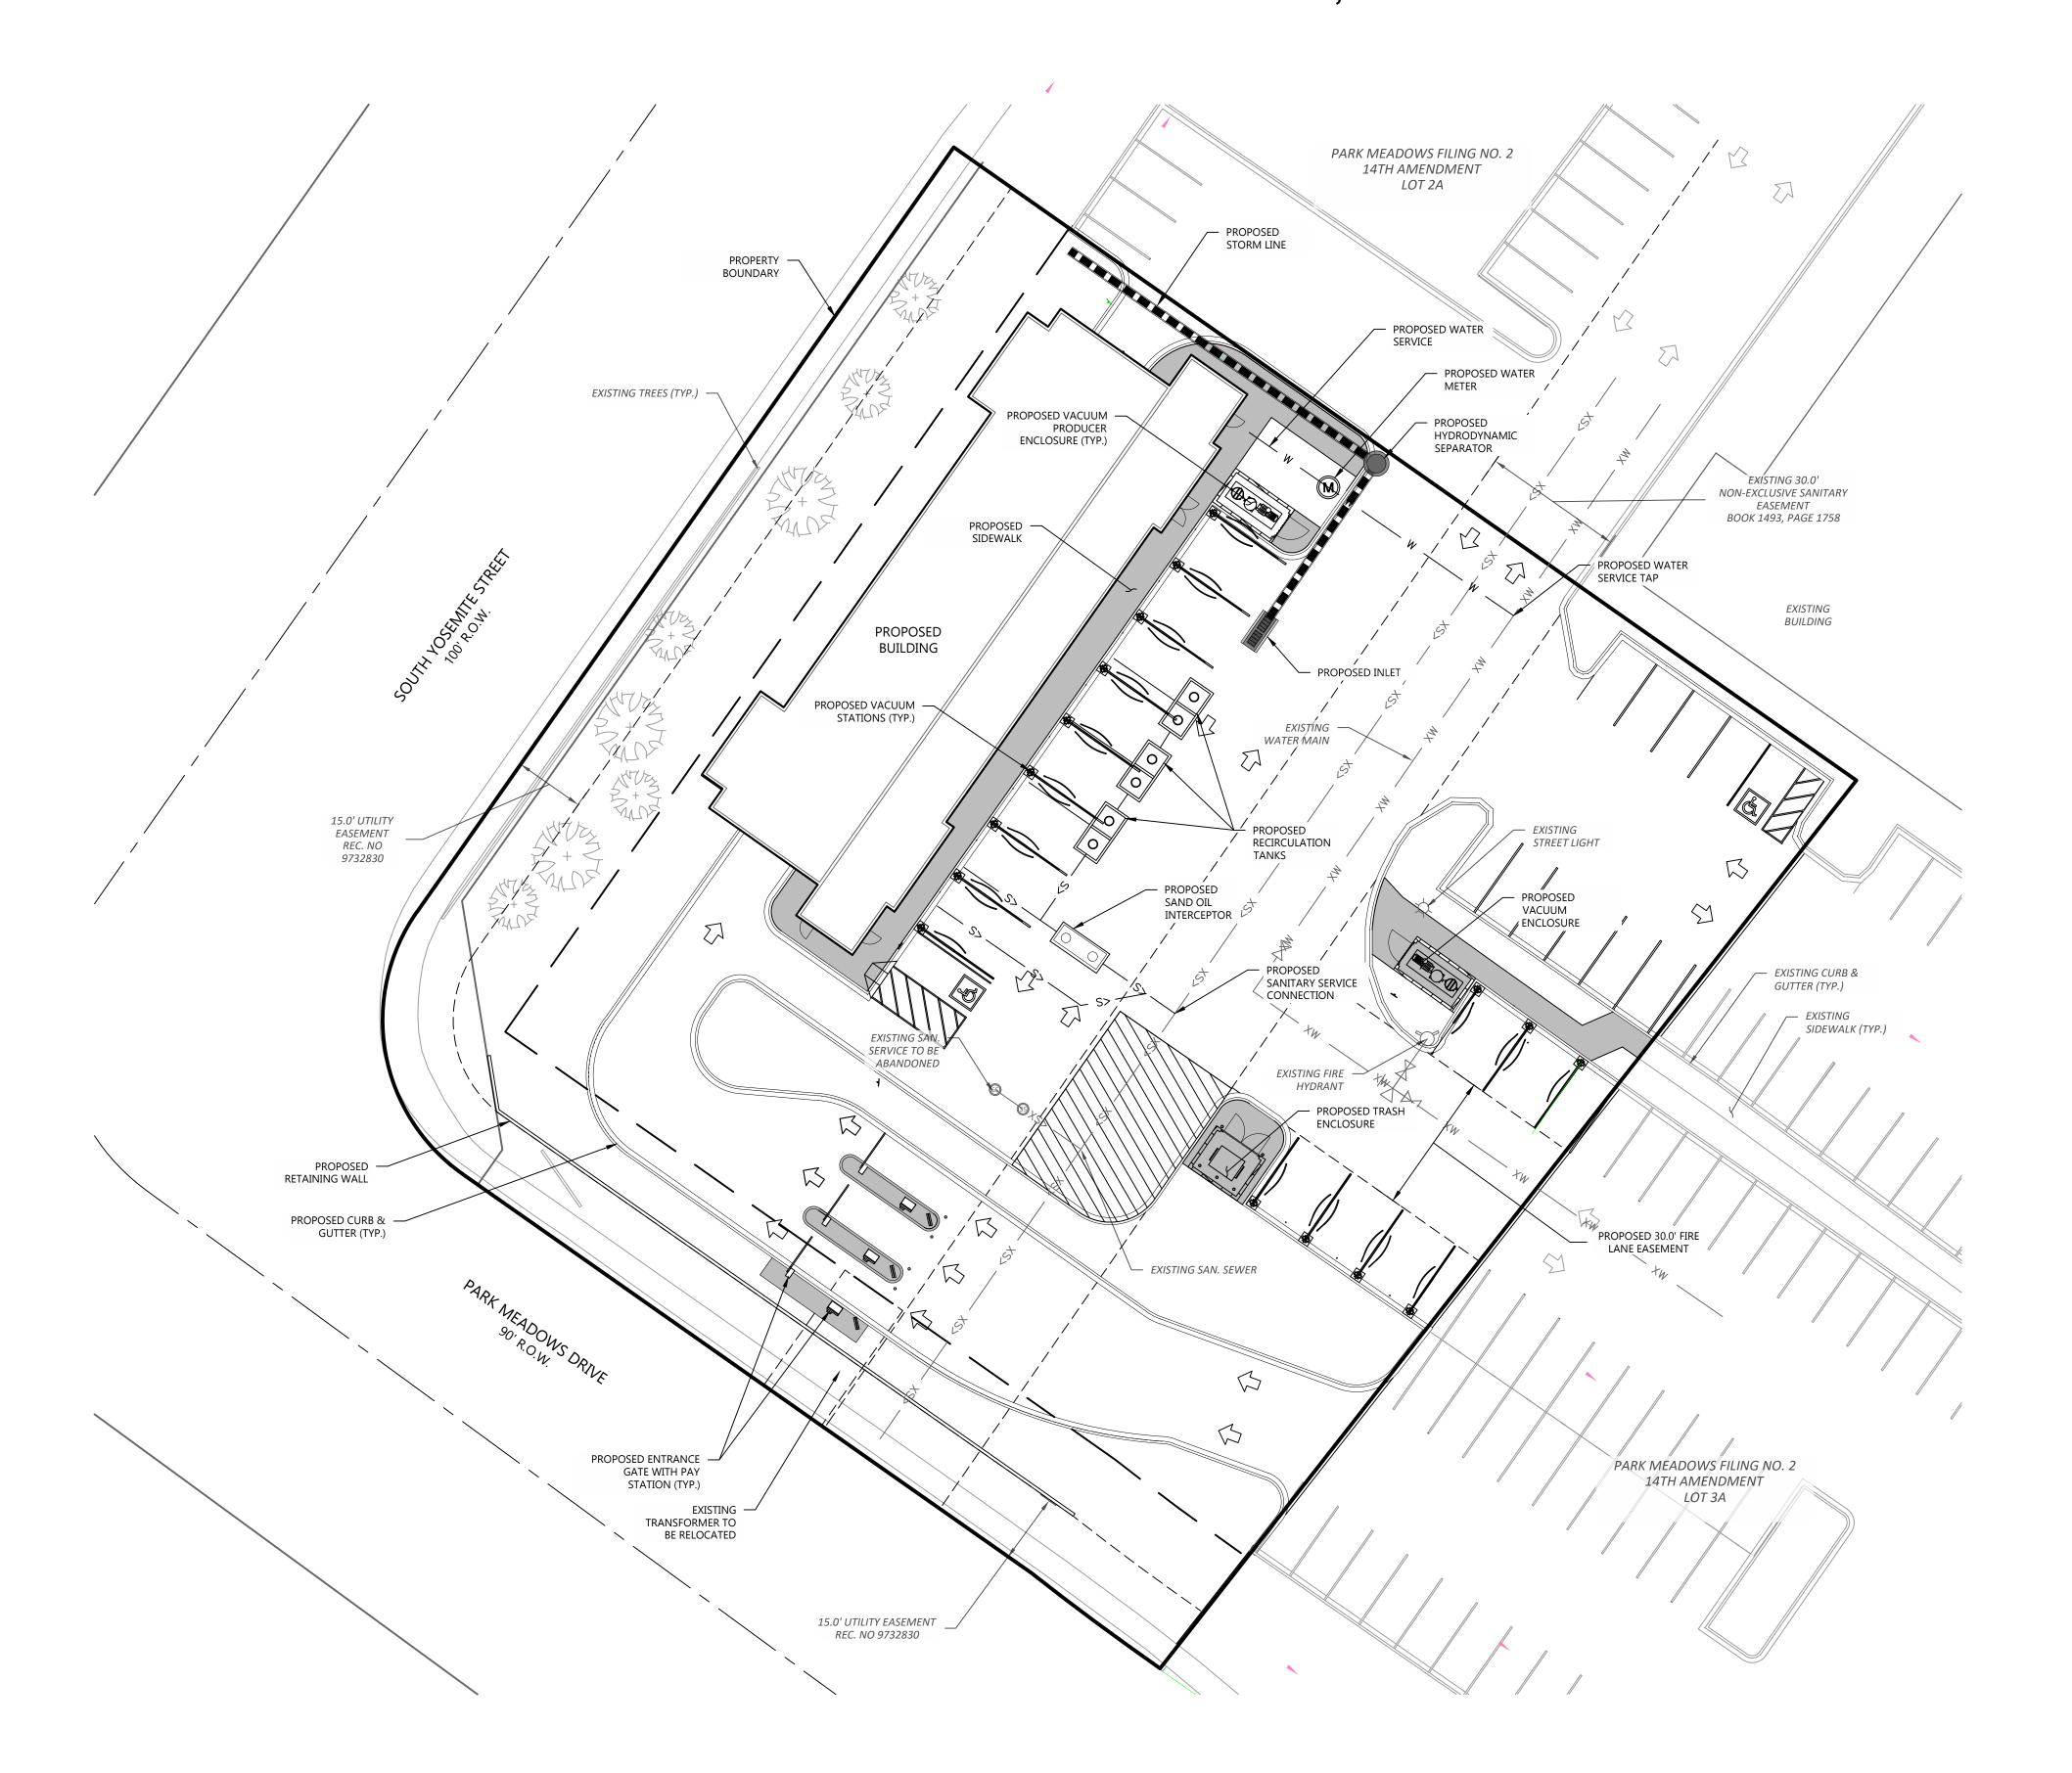
11.18.2021


AS SHOWN

WESTBROOK ENTERTAINMENT & SPORTS DISTRICT PD PLANNING AREA PA2/PA3/PA4

1.198 ACRES


SIP, PROJECT SP21-67




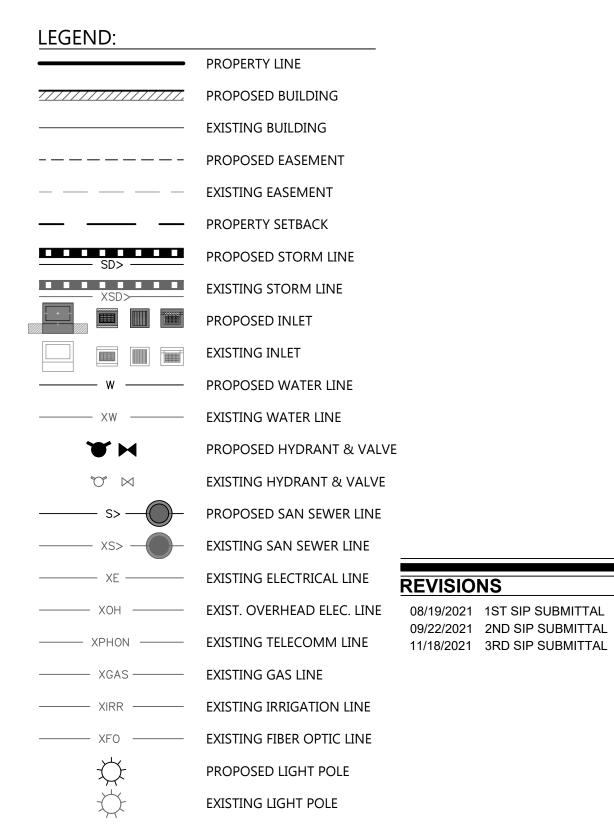

NOTES

- THE EXISTING DOMESTIC WATER SERVICE AND FIRE LINE IN PARK MEADOWS DRIVE SHALL BE ABANDONED AT THE CONNECTION TO THE MAIN PER DENVER WATER STANDARDS.
 IF THE EXISTING SANITARY SEWER SERVICE IS NOT USED, IT MUST BE ABANDONED PER
- SOUTHGATE SANITATION DISTRICT DETAIL SS-26.
 3. THE EXISTING GRAVITY GREASE INTERCEPTOR WILL NEED TO BE ABANDONED PER SOUTH
- THE EXISTING GRAVITY GREASE INTERCEPTOR WILL NEED TO BE ABANDONED PER SOI PLATTE WATER RENEW'S F.O.G. POLICY.
- PROPOSED SAND/OIL INTERCEPTOR WILL NEED TO CONFORM TO SOUTH PLATTE WATER RENEW'S P.O.G.S. POLICY.

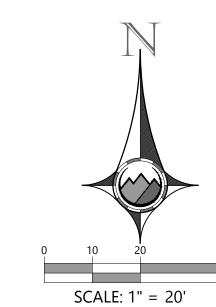

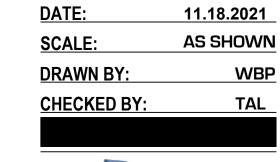



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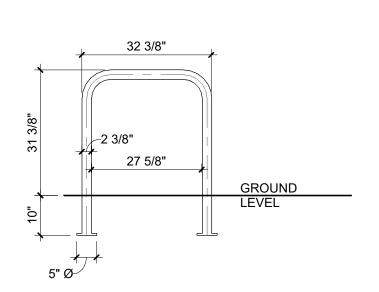
PROJECT NUMBER

SHEET

9 OF 1


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WESTBROOK ENTERTAINMENT & SPORTS DISTRICT PD PLANNING AREA PA2/PA3/PA4 1.198 ACRES SIP, PROJECT SP21-67



BASIS OF DESIGN:
ANOVA
LBR2PING - U-BIKE RACK
MATERIAL: 2.38" O.D. x 10-GAUGE WALL STEEL TUBING
FINISH: POWDER-COAT BLACK


7 **DTL-BIKE RACK-PLANNING**10 1/2" = 1'-0"

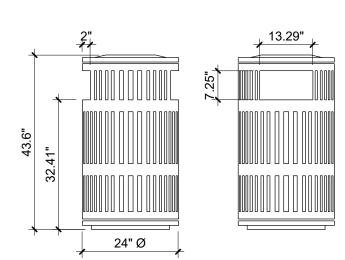

BASIS OF DESIGN:
ANOVA
L2019 - METRIX 40-GALLON TRASH RECEPTACLE WITH DUAL SIDE OPENINGS
MATERIAL: 10-GAUGE SLOTTED STEEL


8 DTL-TRASH RECEPTACLE-PLANNING
10 1/2" = 1'-0"

FINISH: POWDER-COAT BLACK

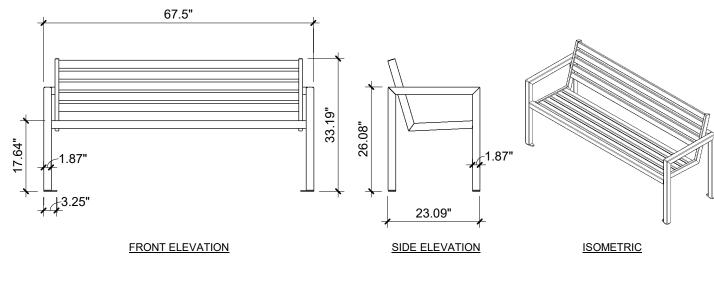


BASIS OF DESIGN:
ANOVA
L2016 - METRIX 6' CONTOUR BENCH
MATERIAL: 14-GAUGE STEEL TUBING
FINISH: POWDER-COAT BLACK

9 **DTL-SITE BENCH-PLANNING**10 1/2" = 1'-0"

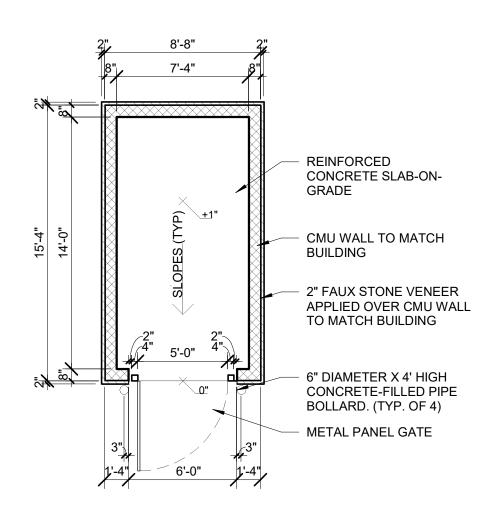


4 DTL-VACUUM ENCLOSURE PLAN - PLANNING
10 3/16" = 1'-0"

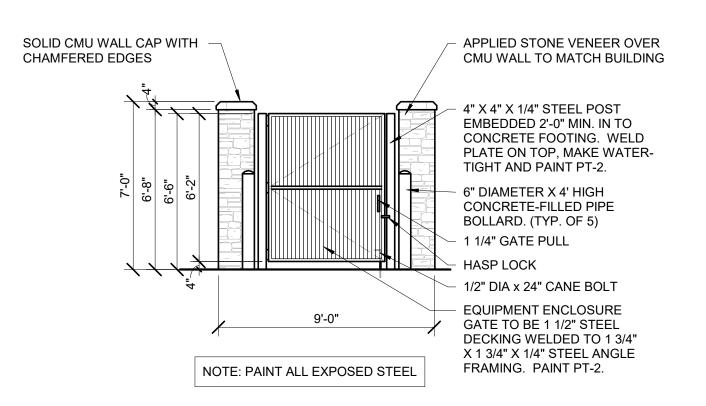


5
10
1/4" = 1'-0"

DTL-VACUUM ENCLOSURE FRONT ELEVATION - PLANNING

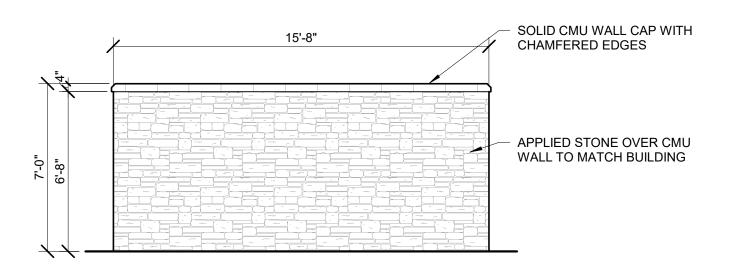


6 DTL-VACUUM ENCLOSURE SIDE ELEVATION - PLANNING
10 1/4" = 1'-0"

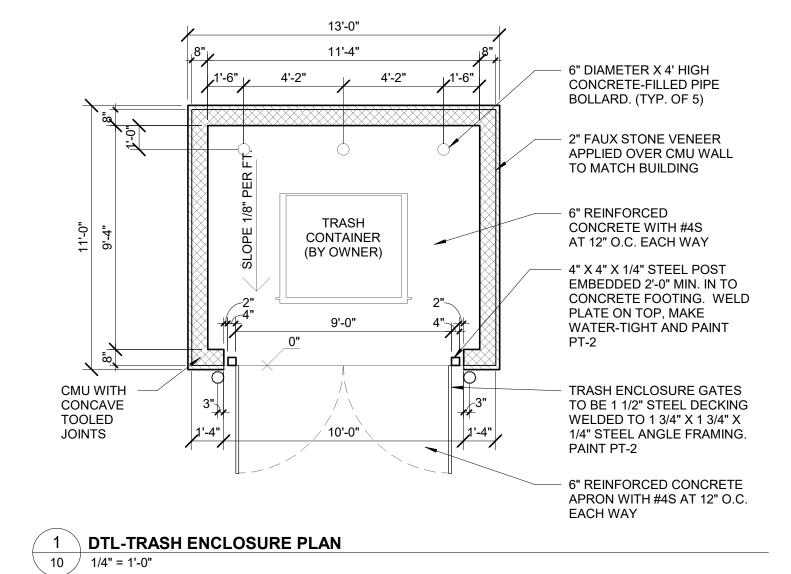

SOLID CMU WALL CAP WITH CHAMFERED EDGES APPLIED STONE VENEER OVER CMU WALL TO MATCH - 4" X 4" X 1/4" STEEL POST, 6" DIAMETER X 4' HIGH CONCRETE-FILLED PIPE BOLLARD. (TYP. OF 5) 1 1/4" GATE PULLS HASP LOCK -TRASH ENCLOSURE GATES TO BE 1 1/2" STEEL DECKING WELDED TO 1 3/4" X 1 3/4" X 1/2" DIA x 24" CANE BOLT 1/4" STEEL ANGLE FRAMING. PAINT PT-2 NOTE: PAINT ALL EXPOSED STEEL

2 DTL-TRASH ENCLOSURE FRONT ELEVATION - PLANNING
10 1/4" = 1'-0"

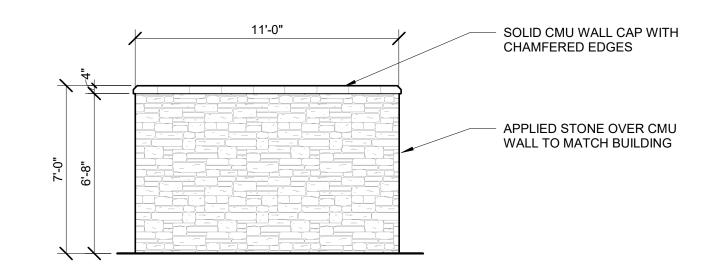

3
10
1/4" = 1'-0"

REVISIONS

 08/19/21
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 09/22/21
 2ND SIP SUBMITTAL

 11/18/21
 3RD SIP SUBMITTAL

DATE: 11.18.2021
SCALE: As indicated
DRAWN BY: CLT
CHECKED BY: MBB

ARCHITECTURE

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(720) 773-2800

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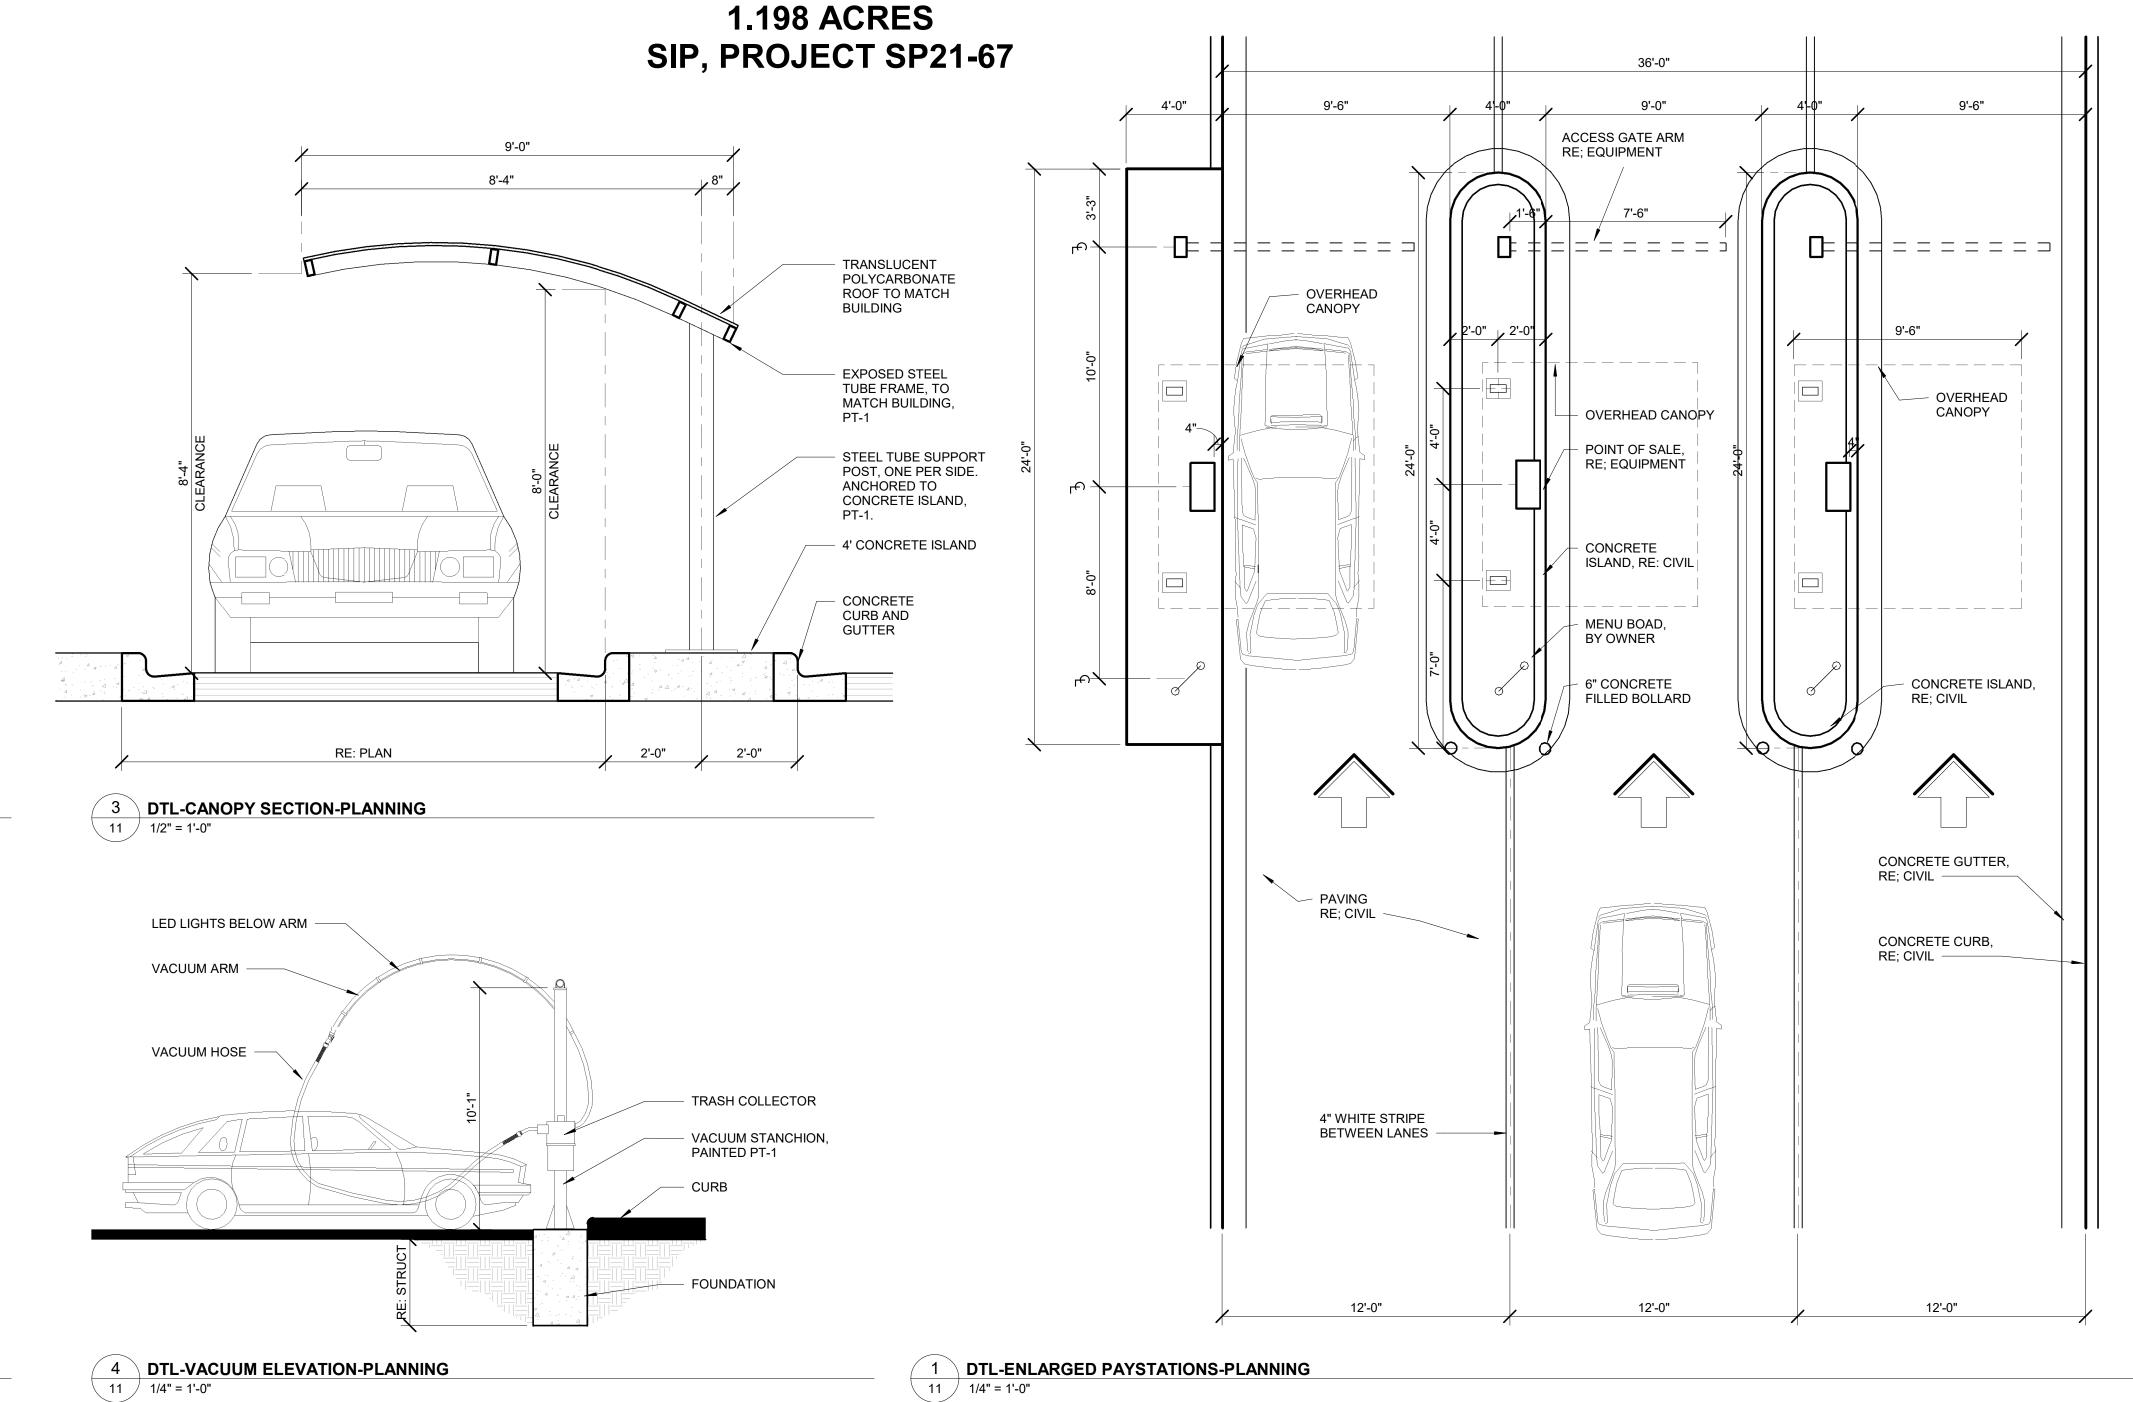
10 OF 17

SITE DETAILS

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8/2021 9:26:27 AM

WESTBROOK ENTERTAINMENT & SPORTS DISTRICT PD PLANNING AREA PA2/PA3/PA4



2 DTL-PAYSTATION ELEVATION-PLANNING

7 DTL-SITE LIGHT POLE-PLANNING 11 1/2" = 1'-0"

BLUE FIELD COLOR

STANDARD 599B

NO. 15090 IN FEDERAL

REFLECTORIZED SIGN

PORCELAIN STEEL WITH

CONSTRUCTED OF

BEADED TEXT OR

BLUE FIELD COLOR


NO. 15090 IN FEDERAL STANDARD 599B

2" DIA GALVANIZED PIPE

SET IN CONCRETE 18"

BELOW GRADE

6 DTL-HC PARKING SIGN-PLANNING
11 1/2" = 1'-0"

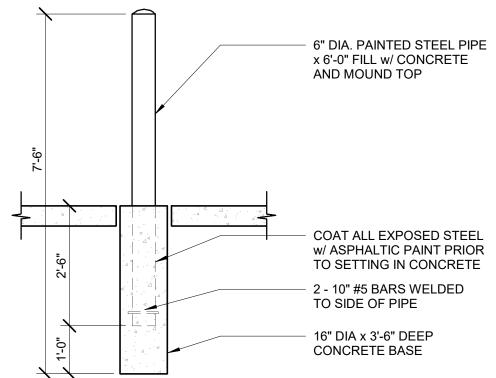

WHITE BORDER,

SYMBOL AND

WHITE LETTERING

CONCRETE FOOTING

FULL CUT-OFF LIGHT

BASE PLATE SET IN NON-

ANCHOR BARS. TIE TO VERTICAL REBAR

CONDUIT LOCATED 24"

RECEPTACLE

BASE COVER

SHRINK GROUT

FINISH GRADE

BELOW GRADE

VERTICAL REBAR HORIZONTAL TIES

CONCRETE BASE

LETTERING

80" MIN. TO TOP

OF WALKING


SURFACE

FINISH GRADE


RESERVÉD

PARKING

8 DTL-PIPE BOLLARD-PLANNING

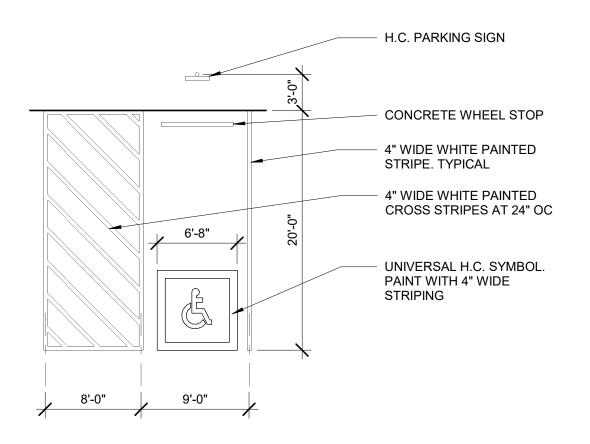

5 DTL-HC PARKING STALL-PLANNING

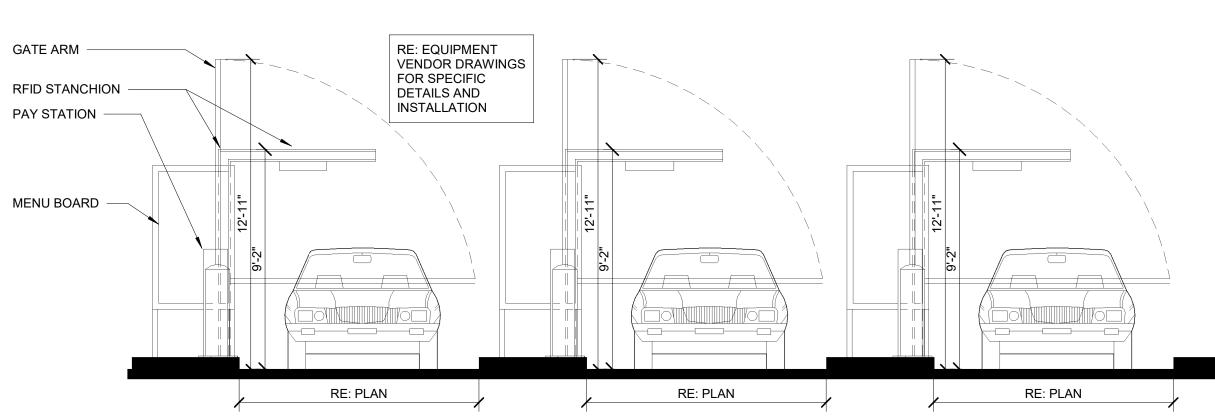

REVISIONS 08/19/21 1ST SIP SUBMITTAL

09/22/21 2ND SIP SUBMITTAL 11/18/21 3RD SIP SUBMITTAL

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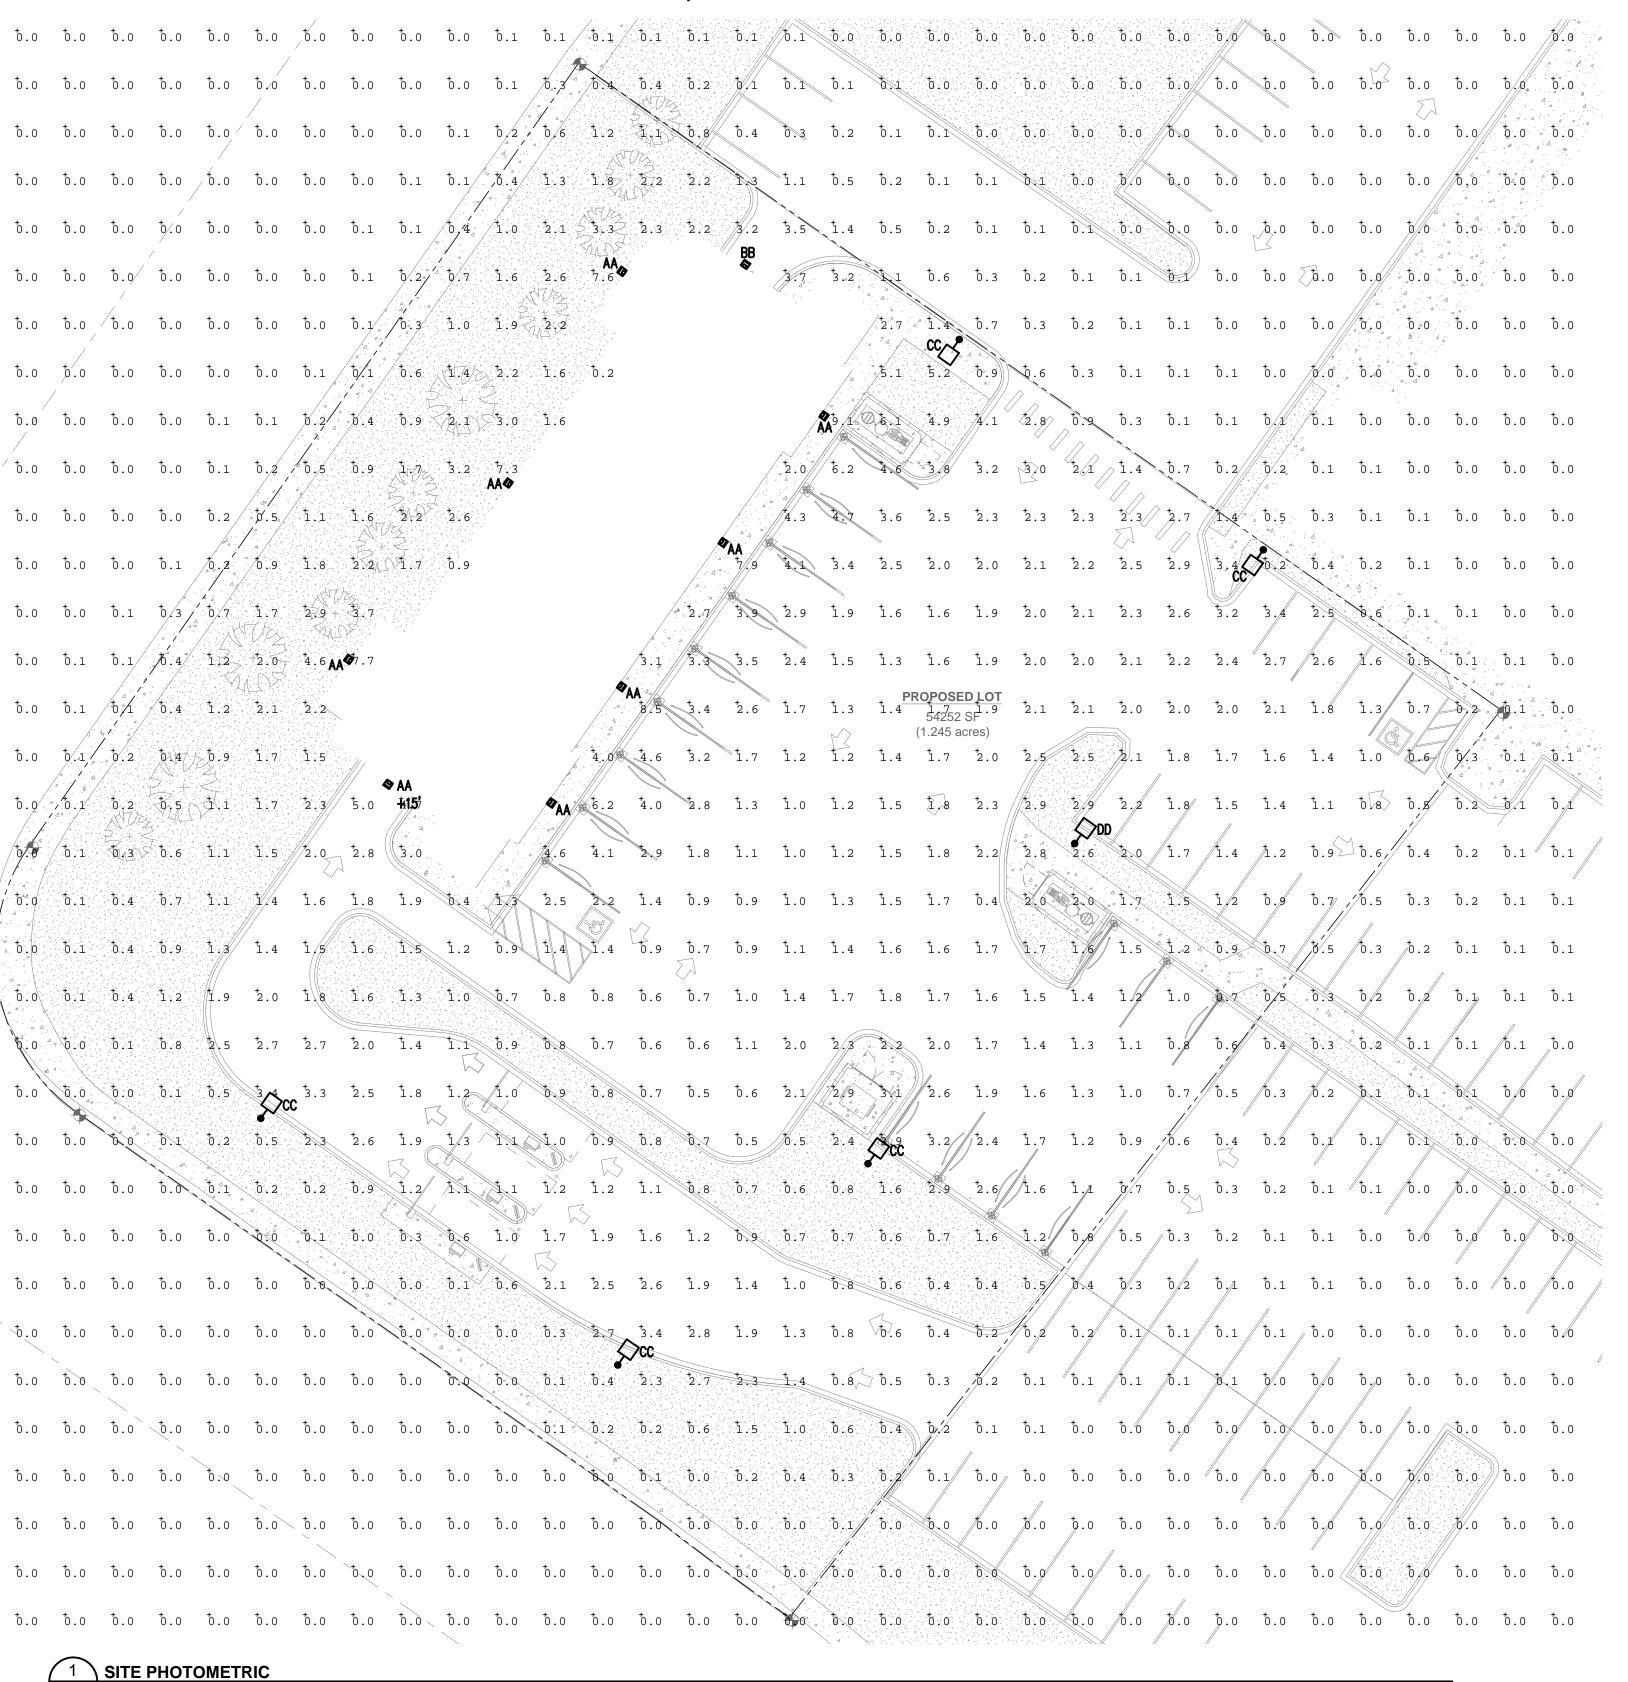
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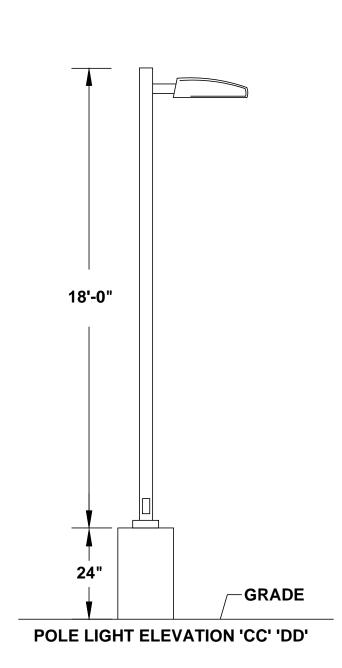
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12 O

 Luminaire Schedule

 Symbol
 Qty
 Label
 Lum. Watts
 Lum. Lumens
 LLF
 M.H.
 COLOR
 Catalog

 □
 8
 AA
 40.21
 4279
 1.000
 12', 15'
 BLACK
 RAYON - T630LED-40-UNV-40-T4


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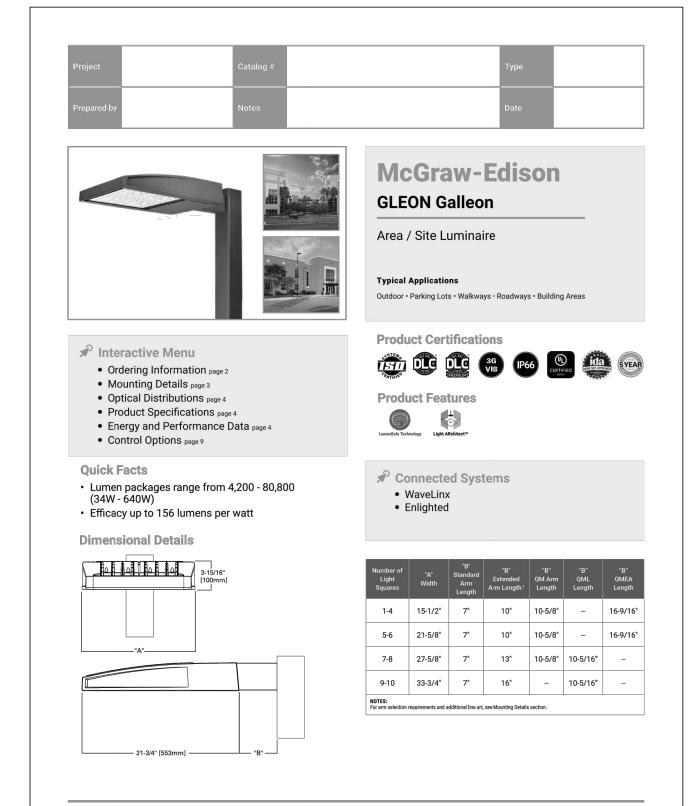
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 GLEON - GLEON-SA2A-740-U-SL4-HSS

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 20'-0"
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 GLEON - GLEON-SA2A-740-U-5

Calculation Summary						
Label	Units	Avg	Max	Min	Avg/Min	Max/Min
Site	Fc	0.76	9.5	0.0	N.A.	N.A.


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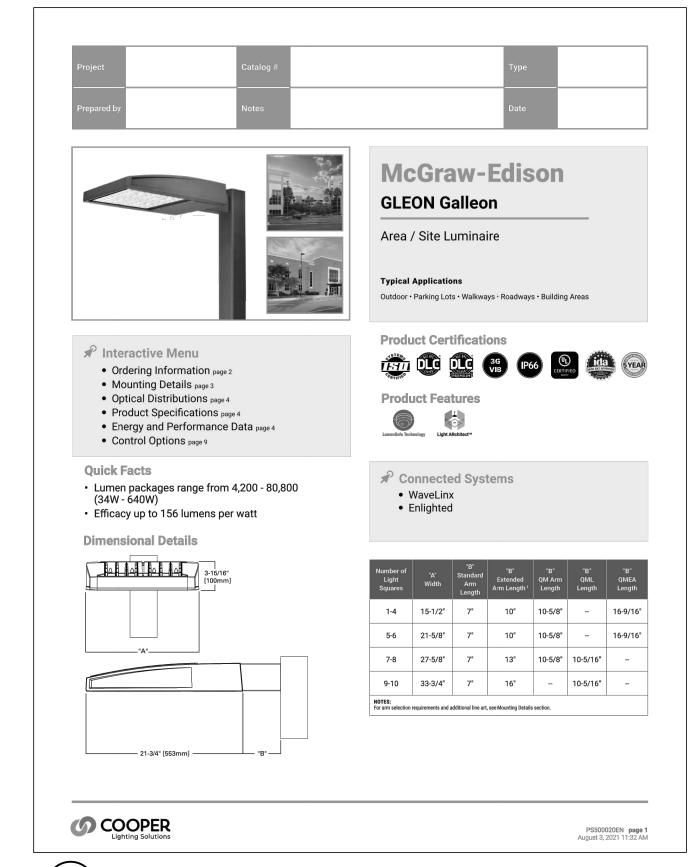




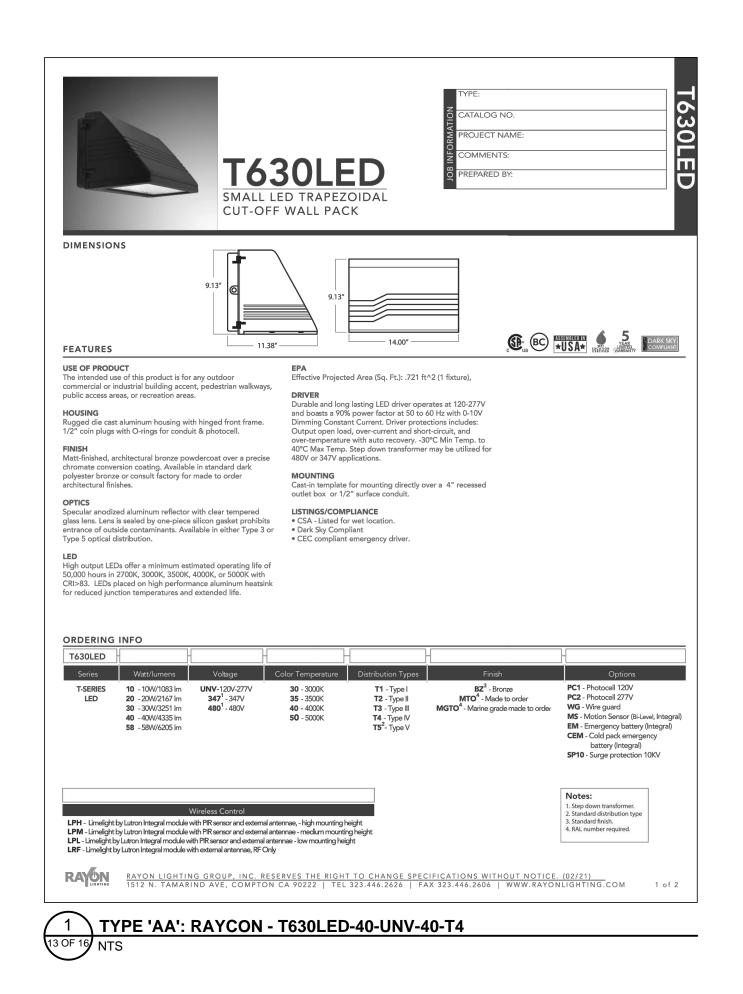

COOPER



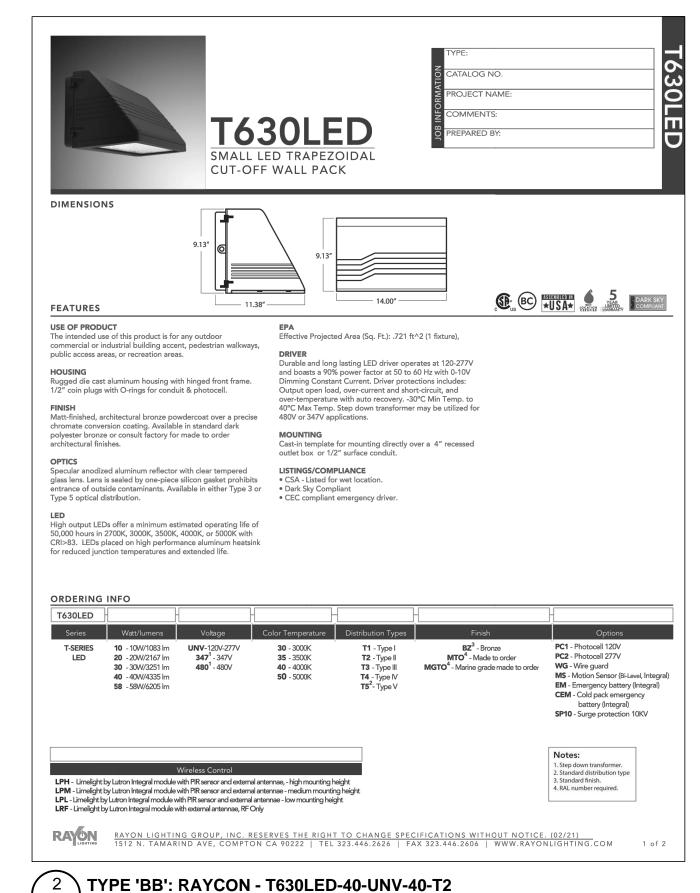

3 TYPE 'CC': COOPER GLEON - GLEON-SA2A-740-U-SL4-HSS

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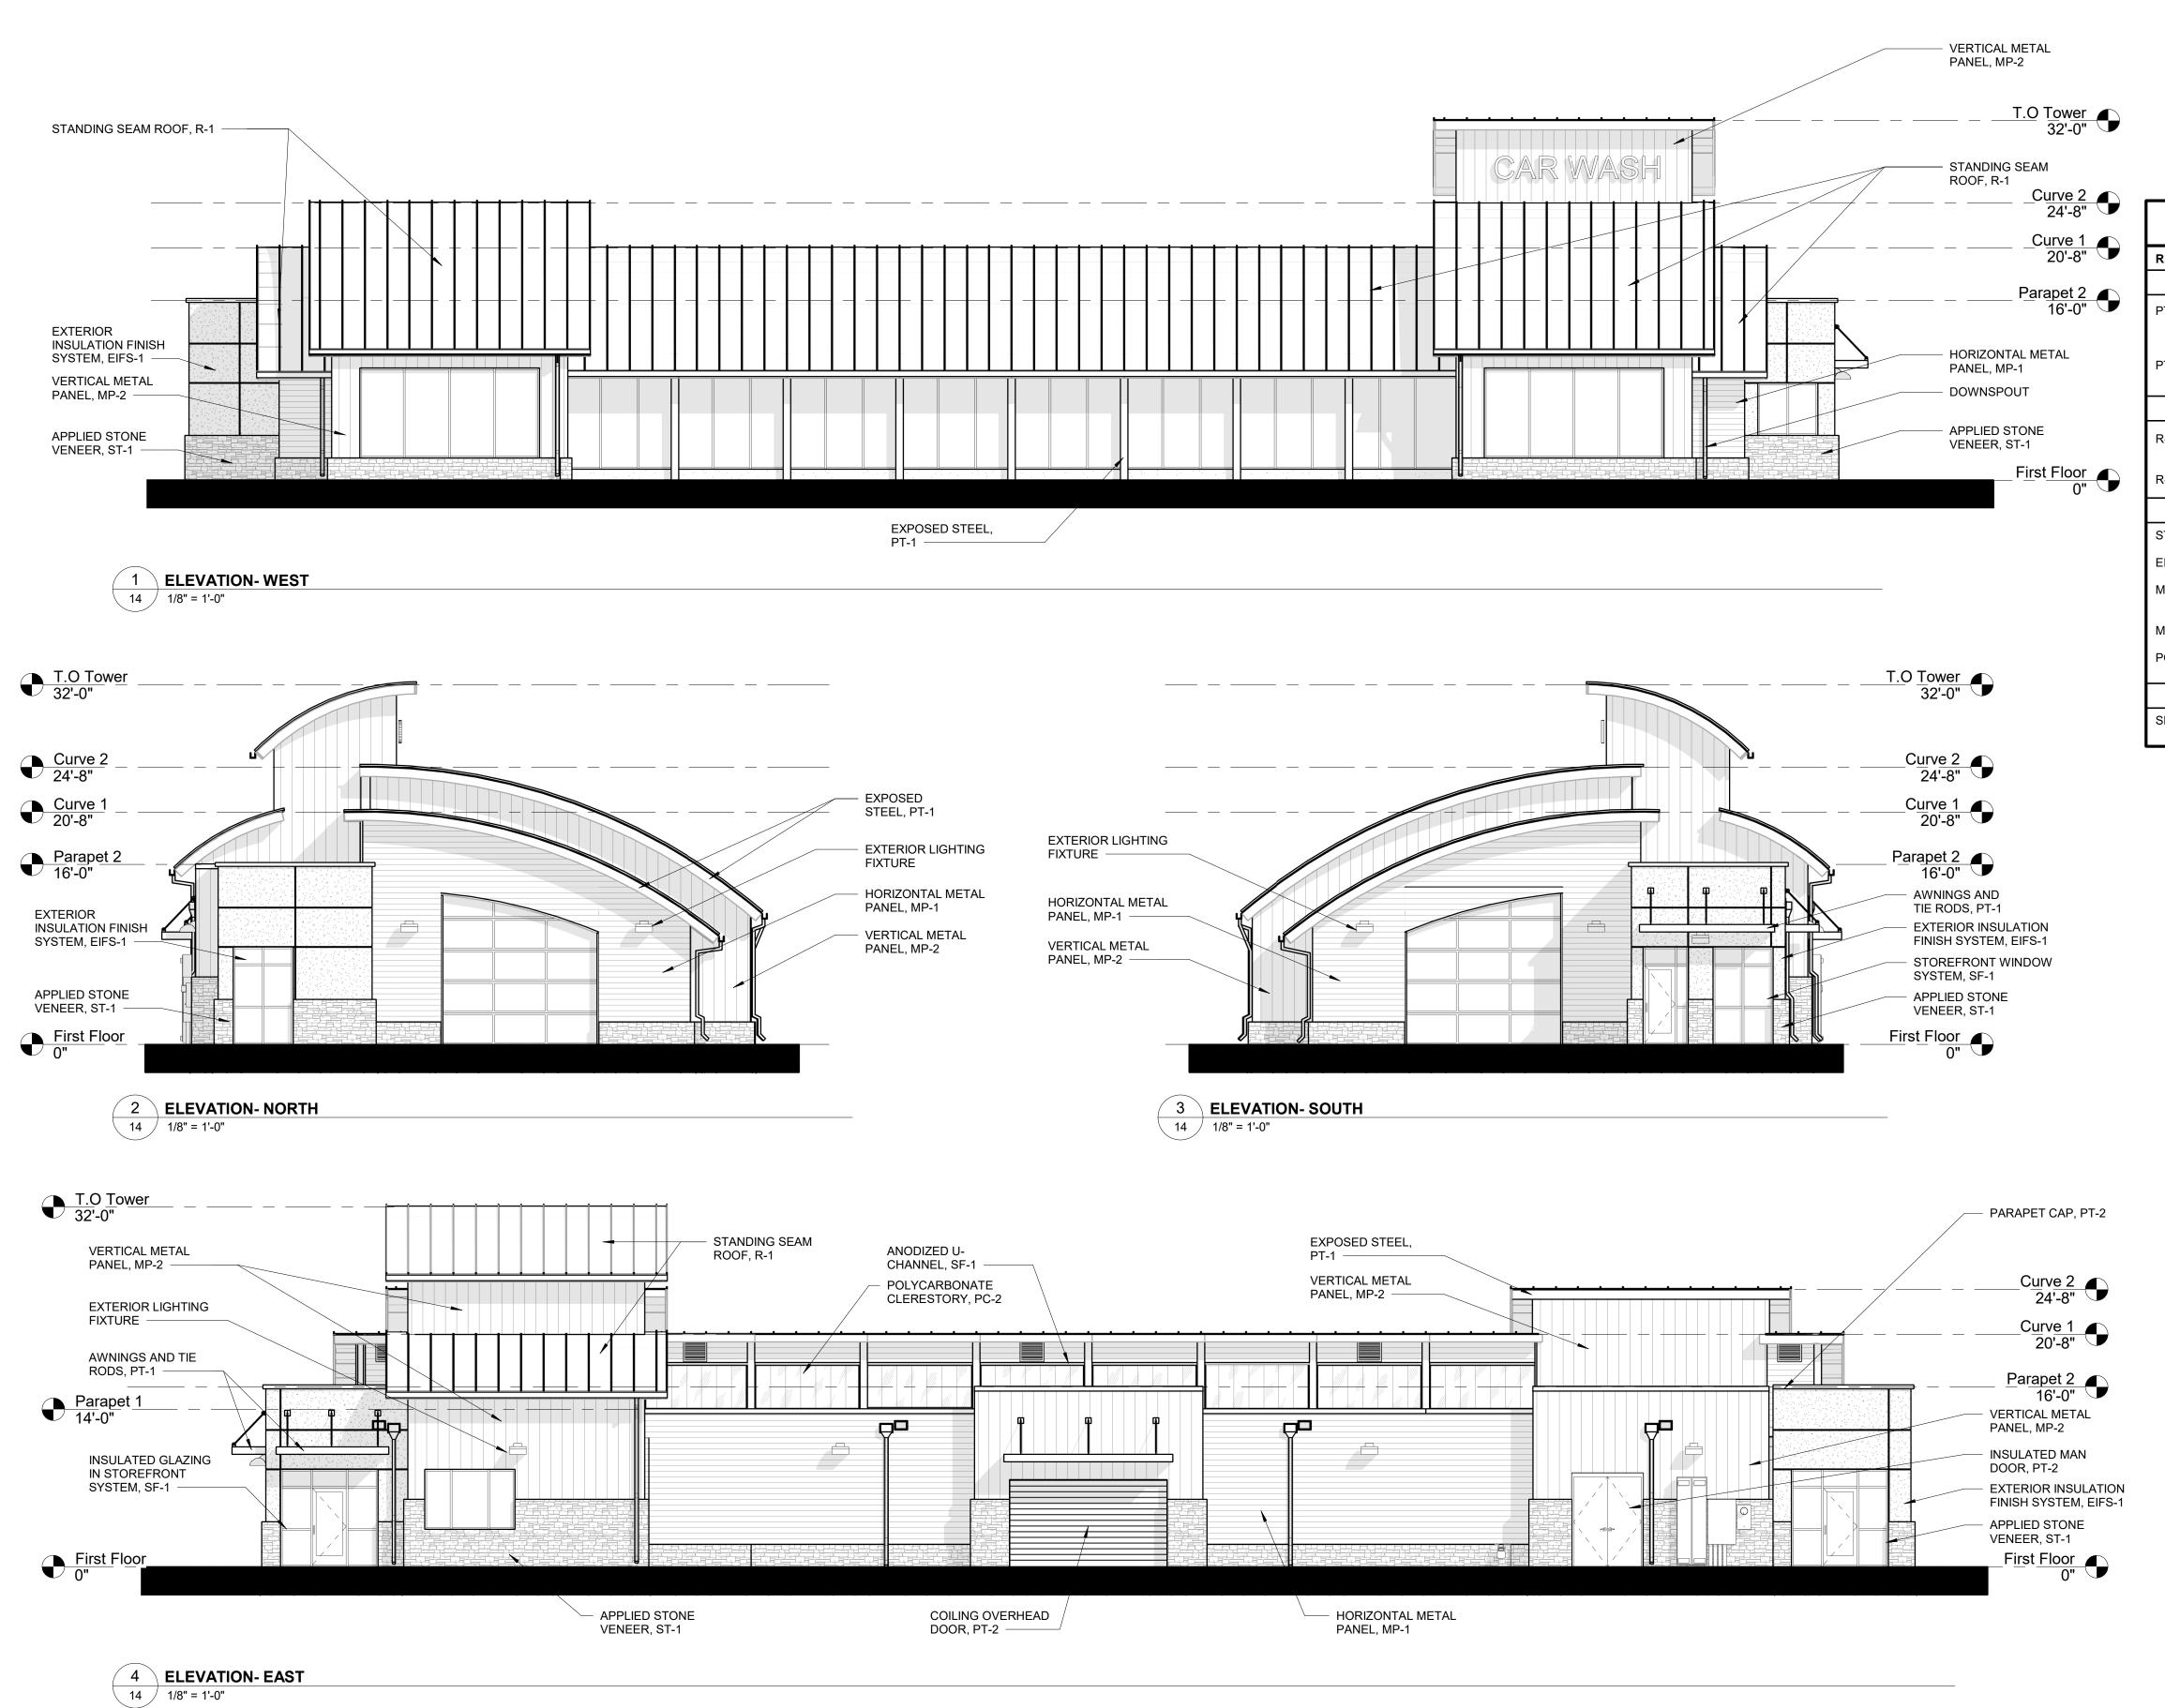
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p 303.357.1998 3consultingengineers.com 13 OF 17

LIGHTING DETAILS

WESTBROOK ENTERTAINMENT & SPORTS DISTRICT PD PLANNING AREA PA2/PA3/PA4 **1.198 ACRES** SIP, PROJECT SP21-67



EXTERIOR FINISH SCHEDULE									
REF.	DESCRIPTION	MANUFACTURER	MODEL / COLOR	REMARKS					
PAI	PAINT								
PT-1	PAINT	SHERWIN WILLIAMS	BLACK MAGIC	EXPOSED STEEL STRUCTURE, TRIM, GUTTERS, BOLLARDS & AWNINGS					
PT-2	PAINT	SHERWIN WILLIAMS	SW-7075, WEB GREY GLOSS	EXTERIOR DOORS, FRAMES, AND DOWNSPOUTS					
RO	OFING	_							
R-1	STANDING SEAM METAL ROOF	METAL SALES	COPPER PENNY, MAGNA-	CURVED ROOF					
R-2	TPO ROOF	FIRESTONE	LOC 90 60 MIL, MECH ATTACHED	FLAT ROOF AND CRICKETS					
WA	LL	•							
ST-1	APPLIED STONE VENEER	SUNSET STONE	MOUNTAIN STACKED STONE	WAINSCOT AND SITE ENCLOSURES					
EIFS-1	EXTERIOR INSULATION FINISH	DRYVIT	SMOKE SIGNAL #614						
MP-1	METAL PANEL	CMG	ULTRA RIB, WEATHERED ZINC	HORIZONTAL PANEL					
MP-2	METAL PANEL	METAL SALES	TLC-2, METALLIC SILVER	VERTICAL PANEL					
PC-2	POLYCARBONATE	GALLINA	547, CLEAR	CLERESTORY WINDOWS AND INTERIOR LIGHT WALL					
MIS	SC .								
SF-1	STOREFRONT ASSEMBLY	KAWNEER	451T - ANODIZED CLEAR ALUM.	W/ CLEAR INSULATED GLASS					

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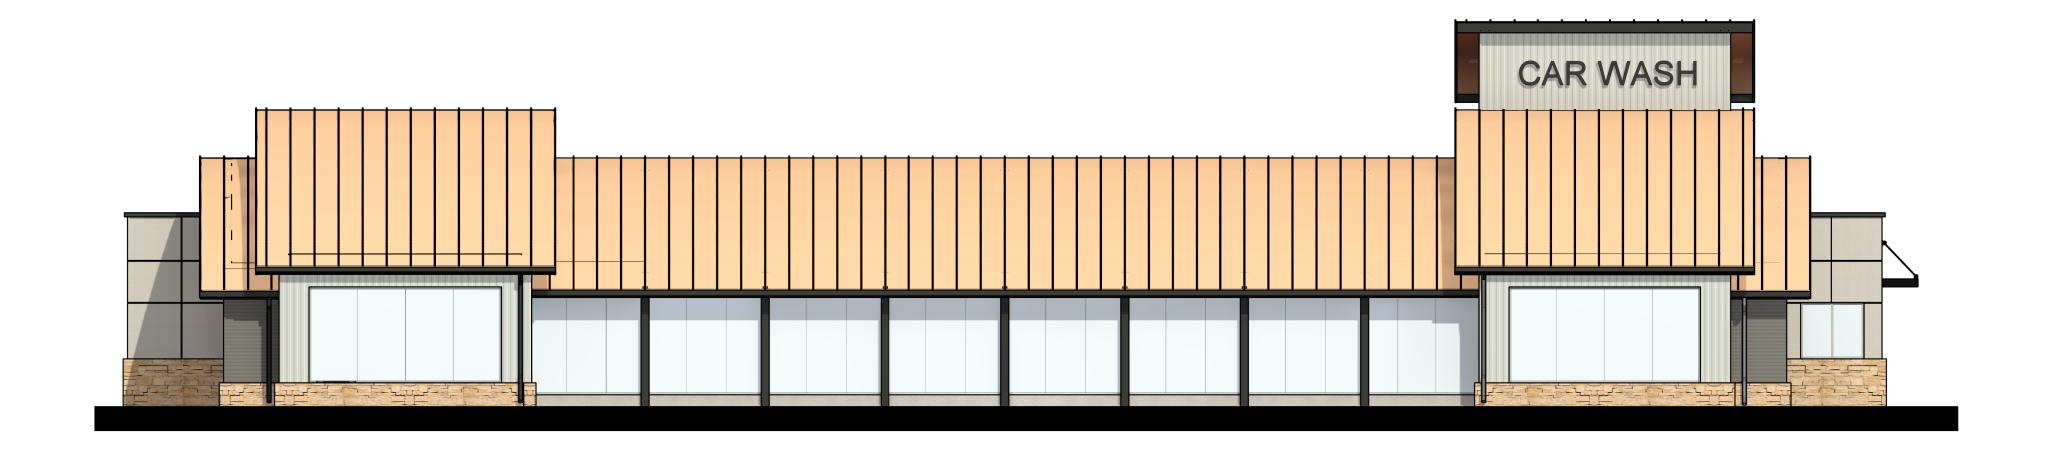
14 OF 17


B&W ELEVATIONS

WESTBROOK ENTERTAINMENT & SPORTS DISTRICT PD PLANNING AREA PA2/PA3/PA4

1.198 ACRES

SIP, PROJECT SP21-67



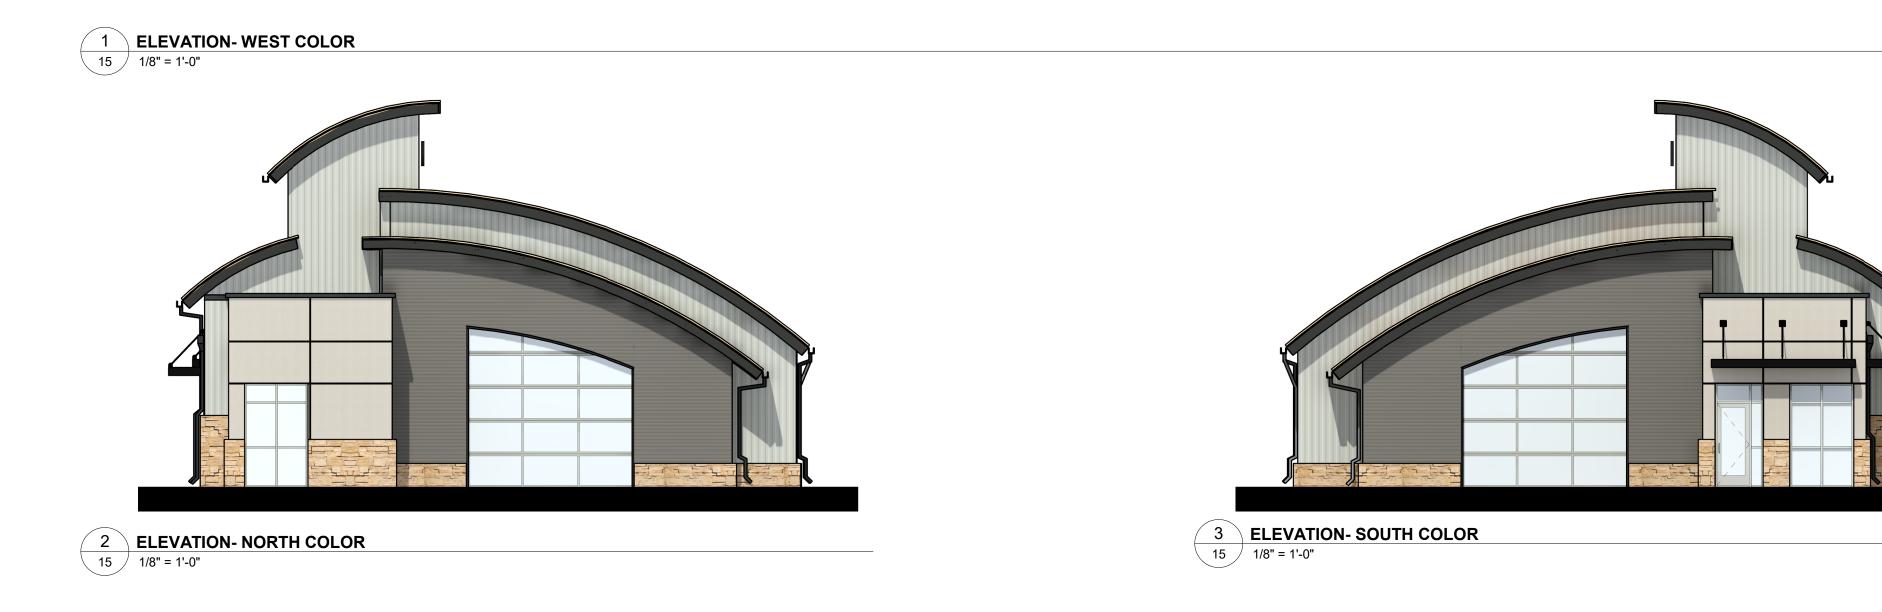



REVISIONS

08/19/21 1ST SIP SUBMITTAL 09/22/21 2ND SIP SUBMITTAL 11/18/21 3RD SIP SUBMITTAL

 DATE:
 11.18.2021

 SCALE:
 1/8" = 1'-0"

 DRAWN BY:
 ALW

 CHECKED BY:
 MBB



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PROJECT NUMBER

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15 OF 17

COLOR ELEVATIONS

C:\Users\cltidwell\Documents\1202.28 Living Water Lone Tree_Central_cltid\

WESTBROOK ENTERTAINMENT & SPORTS DISTRICT PD PLANNING AREA PA2/PA3/PA4

1.198 ACRES

SIP, PROJECT SP21-67



CONTEXT - NORTH



PERSPECTIVE - NORTH



CONTEXT - WEST



PERSPECTIVE - WEST



CONTEXT - SOUTH



PERSPECTIVE - SOUTH

11/18/21 3RD SIP SU

 DATE:
 11.18.202

 SCALE:
 N.T.S

 DRAWN BY:
 CL

 CHECKED BY:
 MB



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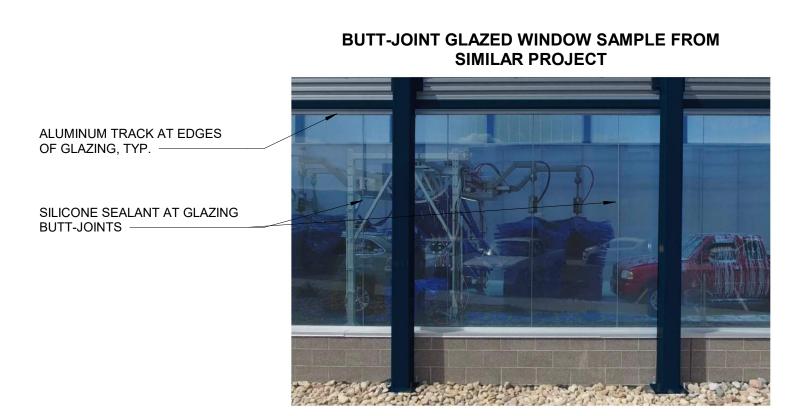
16 OF 17

HOTO RENDERINGS

WESTBROOK ENTERTAINMENT & SPORTS DISTRICT PD PLANNING AREA PA2/PA3/PA4 **1.198 ACRES** SIP, PROJECT SP21-67



PERSPECTIVE 2



EIFS-1

SF-1



DRYVIT LYMESTONE #614 SMOKE SIGNAL

REVISIONS

SCALE:

DRAWN BY:

CHECKED BY:

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11.18.2021



451T - CLEAR ANODIZED ALUM. STOREFRONT W/ CLEAR GLAZING

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PROJECT NUMBER 1202.28

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MATERIALS

APPLIED STONE

VENEER, ST-1