Development Application

Planning Division 9220 Kimmer Drive, Lone Tree, CO 80124 303.708.1818 | www.cityoflonetree.com



Instructions: All sections must be completed and typed or legibly printed. All required attachments must be included. This application does not cover Building Division and Public Works submittal requirements and fees. **Application Type** For Planning Division Use Presubmittal **Final Plat** Project Name: Tall Tales Ranch SIP SIP Re-Plat Job # SP20-02 **SIP** Amendment Rezoning Application Fee: \$3,200 **Preliminary Plan** Variance Check/Transaction #: 118247674PT Date: 01/10/10 Other Staff Initials: JD

Project Information		
Project Name: Tall Tales Ranch	Project Address: 10800 S. Havana Street, Lone Tree, CO 80124	
State Parcel ID: 2231-232-00-005	Subdivision: RidgeGate	
Acreage: 4.01	Lot #: N/A	
Existing Zoning: PD	^{Block #:} N/A	
Proposed Rezoning: PD	Filing #: N/A	
Dustant Departmentany (submits additional shares if a second		

Project Description (submit additional sheets if necessary):

Mixed-Use Residential and Commercial community with two sets of paired houses (28 total apartments), a common residential building (intended for shared use among tenants), a community garden and garden shed, Event Center Barn with coffee shop, and shared parking for residents and guests. Reference the SIP Narrative for more detailed information on design and intent.

Owner and Representative Information		
Property Owner Information	Applicant Information if Different than Owner	
Name (Individual or Organization):	Name (Individual or Organization):	
Schweiger Ranch Foundation	Susan Mooney	
Mailing Address: 10270 Commonwealth St. Ste B, Lone Tree, CO 80124	Mailing Address: 6311 S. Grant Drive, Centennial, CO 80121	
Phone: 720-390-5211	Phone: 303-806-9141	
Email: ematthews@coventrydevelopment.com	Email: susan@talltalesranch.org	



Project Name	Tall Tales Ranch	Projec	ct #
Project Location	RidgeGate PDD Parcel #7	Date	<u>April 16, 2020</u>

Project Narrative

<u>ARTICLE XXVII - Site Improvement Plan (SIP) Project Narrative</u>. The SIP process is intended to provide for development that enhances the quality of life in the City by promoting high-quality design and a strong economy, and by fostering a sustainable and healthy community. The SIP process is required to ensure the development will be in conformance with the <u>Comprehensive Plan</u>, the <u>Design Guidelines</u>, applicable chapters of this <u>Code</u> and applicable Planned Developments and Sub-Area Plans.

Using this form or a separate page(s), the applicant shall provide a written narrative describing their project. Use the following outline (Sec. 16-27-60) as a guide when formulating your narrative – please disregard sections that do not apply to your project:

1. General information.

a. Provide the subdivision name, filing number, planning area number when located in a Planned Development, lot and block number or street address and section, township and range if not in a subdivision, and name of project.

The proposed SIP is within the RidgeGate, 6th Amendment Planned Development District, Planning Area SR32.

b. Indicate zoning of the site and the zoning and current uses of adjacent land.

The site is in the Historic Schweiger Ranch planning area within the PDD. The site is located south of land zoned as City Center and open space; west of land zoned as open space; east of unzoned land (I-25) and the RidgeGate Station; and north of land zoned as open space in the RidgeGate PDD 6th Amendment.

2. Development impacts. Describe overall impacts of the proposed development on adjacent lands and methods for mitigating those impacts.

The site has been designed to transition uses from the City Center toward the north, to the Historic Schweiger Ranch subarea and regional park to the south. The northern-most portion of the site, adjacent to South Havana Street, includes the Barn Event Center and coffee shop, brining commercial and public facing uses to the most visible part of the site. The coffee shop includes outdoor seating, contributing to life on the street and creating a visual connection for people using the RTD Park 'n Ride.

Land uses are less intense in the remainder of the site. In the far-western portion of the site, a small orchard and raisedplanter garden are situated south of South Havana Street, providing a gentle transition from the road and City Center area into the adjacent open space. The paired cottages that are sited southeast of the of the garden area are the buildings closest to the Schweiger Ranch Historic preservation area. Impacts to adjacent lands have generally been mitigated by limiting grading impacts to within the site boundaries. The Applicant has been working directly with Schweiger Ranch on limiting visual impacts by installing a landscape screen consisting of evergreen plant materials between the two sites. Other coordination between the two parties included a preliminary review process of the site plan, architecture, and materials by the Schweiger Ranch for aesthetic continuity, building separation and building height.

3. Compliance with Intent and Approval Standards. Describe how the development complies with the Intent (Section 16-27-10) and Approval Standards (Subsection 16-27-90(a)) of this Article.

In keeping with the City of Lone Tree Comprehensive Plan policies, and the Schweiger Ranch Sub Area Plan, Tall Tales Ranch is being developed in order to provide adults with intellectual and developmental disabilities with a place to live and work in supportive community that helps them to reach their full potential. The facility will provide a great quality of life for residents, support and contribute to the local economy, and add to area development in an architectural style that respects and builds upon the agrarian aesthetic of the Schweiger Ranch Area. Sited within a stones-throw of the RidgeGate RTD station, Tall Tales Ranch will benefit from sustainable transportation options for visitors, as well as residents, who are likely to depend on public transportation.

As a development in the Schweiger Ranch Sub-Area, Tall Tales Ranch provides an ideal transition from City Center to the adjacent Happy Canyon Creek open space. In addition to residences, the site includes an event center and coffee shop—all of which are designed in an agriculturally inspired style— that will provide work opportunities to residents, and connection to the community at-large. The garden, various buildings are all connected via sidewalks, which are lit with theme appropriate fixtures and lined with shrubs and shade trees. Moving outward, naturalistic landscaping along the perimeter of Tall Tales Ranch creates a gentle transition from developed land to open space, in addition to following the sub area guidelines for screening and buffering adjacent land uses.

4. Development phasing. Describe the proposed development schedule and phases of development for all proposed construction.

TTR's Construction Phasing Plan is reflected in the plan below. We believe a phased construction approach is financially prudent. Tall Tales Ranch will complete the following site improvement activities prior to building construction (Phase 1): site over-lot and grading, installation of detention ponds, fire hydrants, and installation of site utilities. Phase 1 work will also include landscaping along Havana Street and to the northeast of the Barn Event Center.

Tall Tales Ranch preference for Phase 1 is to construct one of the paired cottage buildings, the Barn Event Center, and the associated parking lot. The reasons for including a paired cottage building in Phase 1 are:


- (1) It will provide a residential component—essential to the intent of the Schweiger Ranch Sub Area Plan— from the beginning of the site's development; and,
- (2) It will enable participants to live onsite, fulfilling the vision of Tall Tales Ranch.

As a non-profit 501 ©(3) organization, Tall Tales Ranch is bound to proceed cautiously, thoughtfully and within our means. Constructing a paired cottage inclusive of site improvements and the parking lot is a significant capital expenditure, so financial support from the Barn Event Center will be critical to the financial health of the organization.

The reasons for the Barn Event Center in Phase 1 are:

- (1) It will offer a focal point for Tall Tales Ranch that has been in the planning stage for five years;
- (2) It will establish a communal center for our current participants, future participants and guests;
- (3) It will generate revenue from the coffee shop and social events;
- (4) It will provide vocational training for participants;
- (5) It will provide for a permanent meeting location to conduct meetings, organize fund raising activities, capital campaign events and other non-profit organizations; and,

Tall Tales Ranch preference for Phase 2 is to construct the second of the paired cottage buildings, the main cottage, and remaining site improvements (walking paths, fire pits, garden area, irrigation, landscape, etc.). As site utilities will already be installed, we will not disturb the Barn Event Center activities or parking lot. We will access the site from the southwest corner working in a clockwise fashion. The last improvement to be constructed will be the garden area.

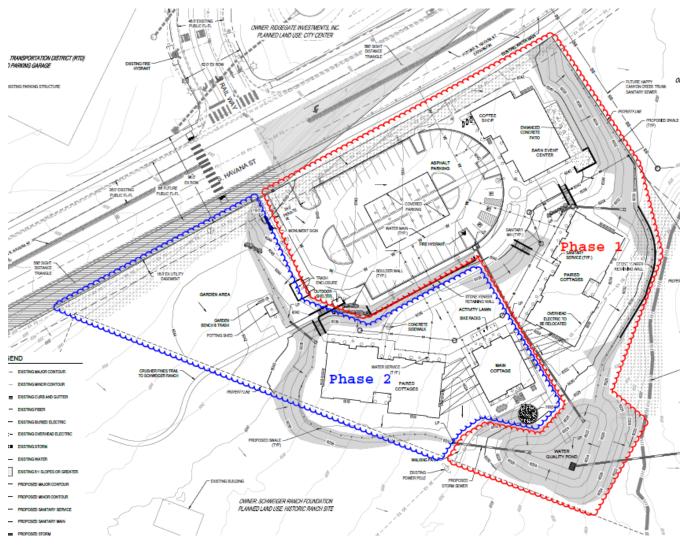

5. Other project data.

- a. Total number of employees on maximum shift when known (for parking purposes). Total number of employees is to be determined based on market demands.
- b. Square footage of building.

Total square footage of all buildings included on site is approximately 19,753 square feet.

c. Lot area.

Total lot area is 174,537 square feet (4.0 acres)

d. Anticipated opening date.

Opening of the facilities is dependent on future public infrastructure improvements as well as fundraising and market demands.

6. Sustainability. Highlight ways in which the project furthers the City's environmental goals regarding sustainability. This may include a general description of the project location relative to other uses, public transit and trails; ease of travel to key destinations on foot or bicycle; water conservation and water quality measures; site layout; green building practices; or operational aspects of the use such as waste reduction, recycling or commuter trip reduction programs.

The site's location will allow residents, employees and visitors multiple options for sustainable transportation to and from Tall Tales Ranch. The nearby RTD Rail Station will offer rail connection to the site, while proposed trails within the open space and bike trails along RidgeGate Parkway will offer active transportation opportunities. Further, the site is adjacent to the Lone Tree City Center planning area, and upon City-Center build-out, will offer residents the benefits of a vibrant central district within walking distance of the Ranch.

Water conservation onsite will be achieved through the strategic use of native plants including grasses, shrubs, perennials, and canopy and evergreen trees; much of the on-site landscaping will accordingly, require little or no irrigation. Irrigation plans for landscaping and raised planters has been included with SIP-02. The landscape will use drip irrigation wherever possible, except for turf areas to help reduce overall water use.

7. **Variances if applicable.** For those SIPs for which a variance from the standards in this Chapter, the Design Guidelines or Sub-Area Plans is requested, the narrative shall also explain the need for the variance. (Public notice may be required, see Section 16-26-60).

No variances are requested for this SIP.

Statement of Design Intent

Please describe how the project meets the intent of the <u>City of Lone Tree Design Guidelines</u>, including the city's Core Design Principles (p. 11). If the project is located within a Planned Development that is governed by additional design standards or guidelines, please address how the project satisfies the intent of those standards and guidelines as well.

Please use the outline below as a guide in formulating your response. You may also use this opportunity describe particular strengths, unique features, sustainable practices, or innovations that distinguish the design of the project, as well as any particular opportunities or challenges that should be considered. This Statement of Design Intent is intended to encourage thoughtful consideration of design guidelines and to give project reviewers and decision makers a more thorough understanding of the project.

1. Overall Design Concept. Briefly describe the use and overall concept for the project as a whole.

Tall Tales Ranch is intended to provide supportive housing and work opportunities for adults with intellectual and developmental disabilities, along with other adults of different abilities, and staff. The site includes 28 apartments in paired cottages, along with a community living space for residents, and an event building with a coffee shop. Residents may choose to work in the event building or coffee shop, working alongside people of different abilities, thus expanding their community. Residents will also have the opportunity to tend the small orchard and raised-bed garden on the western end of the site. The event venue and coffee shop will serve as micro-businesses on-site that will provide revenue and employment opportunities, while extending the reach and mission of Tall Tales Ranch into the community.

2. Context and Site. Describe how the project relates functionally and visually to the context of the surrounding area. Consider issues of form and character, the natural environment, vehicular and pedestrian access and circulation, etc.

Tall Tales Ranch is within the RidgeGate Planned Development District and meets many of the goals of the district. The Ranch will provide a mix of commercial and residential uses on-site, within close proximity of public and active transportation options, as well as the future City Center district. Additionally, the site provides a transition from the more intensive uses of the City Center district into the Open Space area along Happy Canyon Creek with its two-story buildings, agrarian aesthetic, and native planting palette and design.

Residents, employees, and visitors to the site may access it through the future pedestrian and bicycle trails proposed within the comprehensive plan, from the adjacent RTD station, or by personal vehicle. The Site Improvement Plan proposes a crosswalk with pavement markings, warning signs, yield pavement marking, and Rectangular Rapid Flashing Beacons to provide users with a safe way to cross Havana Street, particularly when it is expanded in the future. Please reference the Traffic Impact Study for additional information related to the pedestrian crossing between The Ranch and the RTD station. The Ranch is internally connected by a series of walks that connect the orchard, residential buildings, and event building, as well as by a walking path on the south side of the site. The portion of the Ranch facing the Open Space includes native planting and aesthetically designed water infiltration and detention areas that maximize the advantages of grade on-site.

3. Public Realm. Describe how the project contributes to an inviting, safe and functional public realm. Consider public spaces, street/sidewalk – level experience, lighting, landscaping, and signage.

Tall Tales Ranch will contribute to the public realm through improvements along the southern side of South Havana Street, as well as through the indoor and outdoors spaces at the Coffee Shop and Event Barn. Right of way improvements will include a detached sidewalk lined with deciduous trees in the tree lawn. The sidewalk will be lined with planting beds and no-mow sod adjacent to the developed portions of the site. Outdoor seating at the coffee shop will provide additional eyes on the street as well as a clear visual destination for users of the RidgeGate RTD station.

All the residential buildings will feature front porches that look toward South Havana Street and the activity lawn, promoting an active public realm. Lighting on-site will be kept close to buildings, enabling safety during dark hours, while minimizing light pollution on the surrounding area.

4. Architectural Design. Describe how the architectural design contributes to the unique qualities of the area and how design concepts result in a unified, functional and high-quality design. Consider building form and composition, façade composition and articulation, and materials, colors, and lighting.

The architecture of Tall Tales Ranch pays homage to the adjoining Schweiger Ranch property. It reflects both the historic homestead and supporting ranch structures.

The Barn is a Community Building. It will serve as a source of revenue, an event space, a coffee house, and provide office space for Tall Tales Ranch. A unique component to this building is the addition of office/flex spaces that can be utilized by entrepreneurial residents at Tall Tales Ranch. The architecture reflects that of a traditional monitor barn with a portion of raised roof and high glass along the ridge axis. The deep mauve lap siding and weathered wood tones of the vertical siding were selected to reflect a seasoned barn building, without having an overbearing presence on the site.

The Main Cottage is the heart of Tall Tales Ranch and for its residents. Referred to as "The Big, Blue House," it will house the kitchen, dining room, living room, lounge and library; encouraging community connections. The simple, gable-end farmhouse style form, wrap-around porch with wooden posts and angled brackets, and residential layout are all designed to encourage a sense of home and belonging for its residents. The rich, blue color of the lap siding identifies the house as a focal point, both visually and programmatically.

The paired 7-plexes are designed to look and feel like ranch bunkhouses. While each resident is offered a fully equipped apartment; community gathering spaces, laundry rooms, and deep front porches, with wooden posts and angled brackets, are all designed to bring the community together. The grey-tones of the lap and board & batten siding used on the paired 7-plexes were selected to provide a quieter, softer palette.

The parking structure and accessory buildings were all designed to reflect the support structures found on a ranch property. The outdoor shelter is reflective of an old hitching post, the potting shed emulates a tiny one-room schoolhouse. All accessory buildings share a color palette with the barn building – typing the campus together.

Applicant/Preparer Contact Information

Name: Diana Rael Business: Norris Design Address: 1101 Bannock Street, Denver, Colorado 80204 Phone: 303-892-1166 Email: drael@norris-design.com


Owner Contact Information if Different from Applicant

Name: Susan & Pat Mooney Business: Tall Tales Ranch Address: 6311 S. Grant Drive, Centennial, CO 80121 Phone: 303-806-9141 ext. 1 Email: <u>susan@talltalesranch.org</u> and <u>pat@talltalesranch.org</u>

SHEET	Γ INDEX
01	COVER SHEET
02	SITE PLAN
03	GRADING PLAN
04	UTILITY PLAN
05	LANDSCAPE SCHEDULE
06	HARDSCAPE PLAN
07	LANDSCAPE PLAN
08	LANDSCAPE DETAILS
09	LANDSCAPE DETAILS
10	LANDSCAPE DETAILS
11	LANDSCAPE DETAILS
12	LANDSCAPE MATERIALS
13	SITE LIGHTING PLAN
14	SITE LIGHTING DETAILS
15	BARN ELEVATIONS
16	BARN ELEVATIONS
17	PAIRED 7-PLEX ELEVATIONS
18	PAIRED 7-PLEX ELEVATIONS
19	MAIN COTTAGE ELEVATIONS
20	PARKING STRUCTURE
21	ACCESSORY BUILDINGS
22	SITE MATERIALS SCHEDULE
23	IRRIGATION NOTES
24	IRRIGATION PLAN
25	IRRIGATION DETAILS
26	IRRIGATION DETAILS
27	IRRIGATION CHARTS / DETAILS

NOTES:


- THE PROPERTY HEREIN IS SUBJECT TO ALL APPLICABLE REQUIREMENTS OF THE LONE TREE ZONING CODE, INCLUDING BUT NOT LIMITED TO MAINTENANCE, LIGHTING, PARKING, SIGNAGE, AND OUTDOOR STORAGE, EXCEPT AS MAY OTHERWISE BE ADDRESSED IN AN APPROVED DEVELOPMENT PLAN OR SUB-AREA PLAN.
- 2. ANY EXTERIOR MODIFICATIONS TO BUILDINGS OR THE SITE MAY TRIGGER A SITE IMPROVEMENT PLAN AMENDMENT. CONTACT THE PLANNING DIVISION PRIOR TO MAKING ANY EXTERIOR MODIFICATIONS.

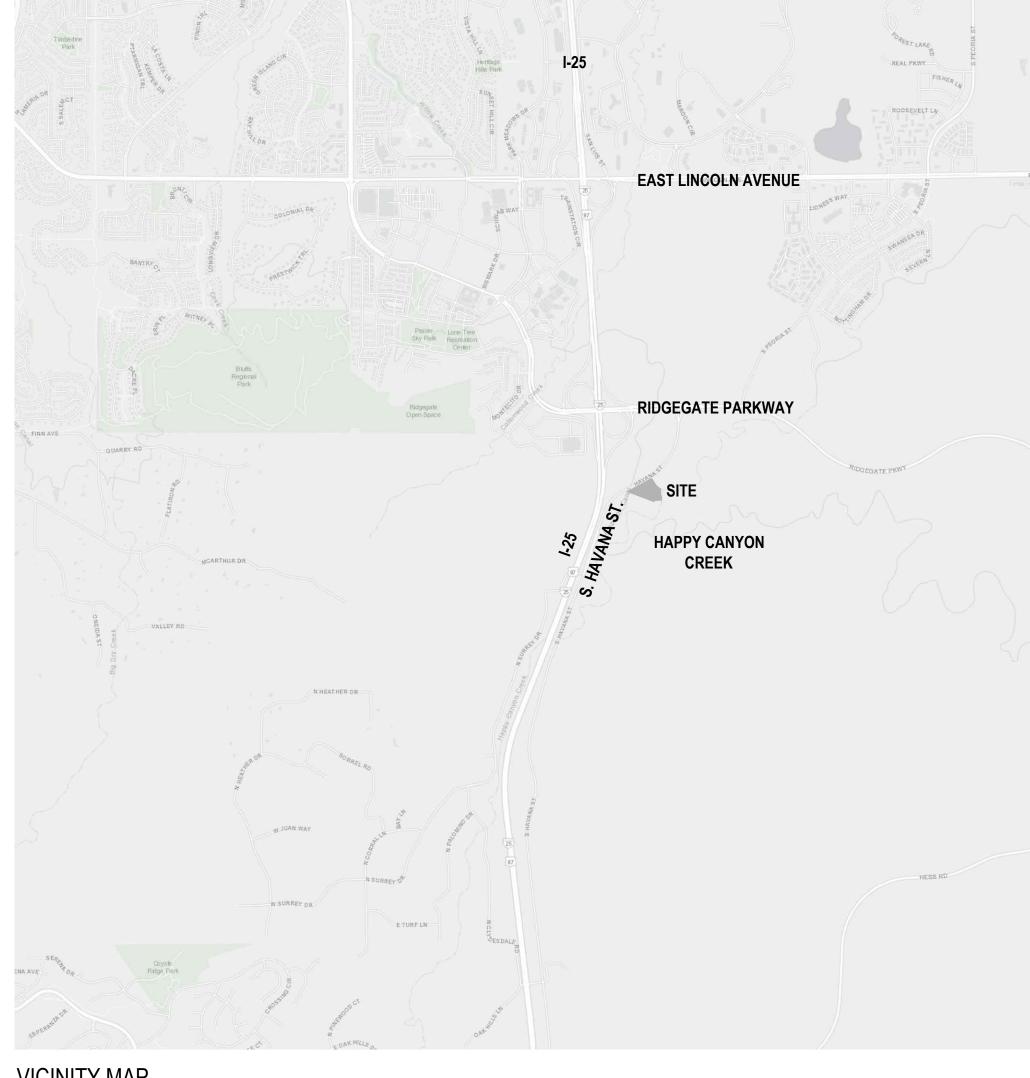


VICINITY MAP

TALL TALES RANCH


4.01 ACRES SP20-02

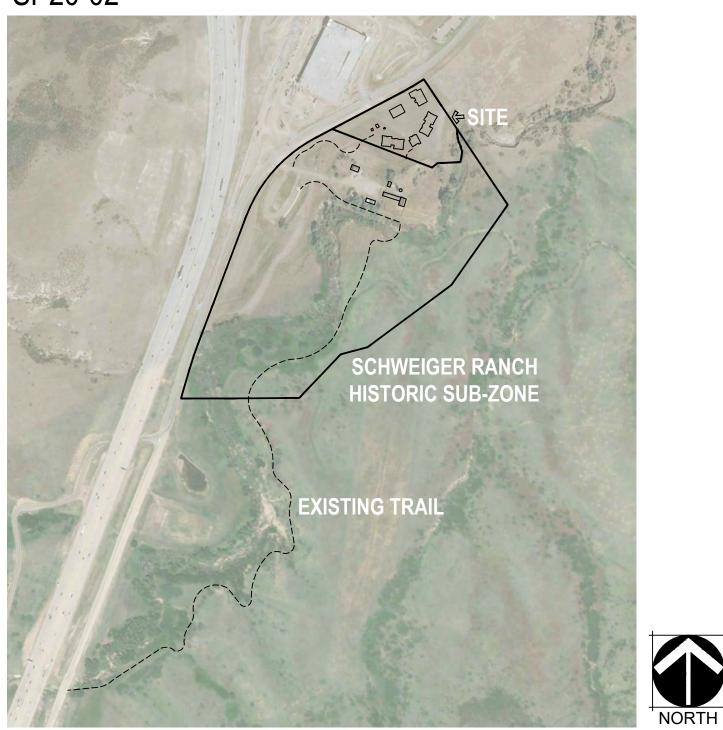


RIDGEWAY PDD

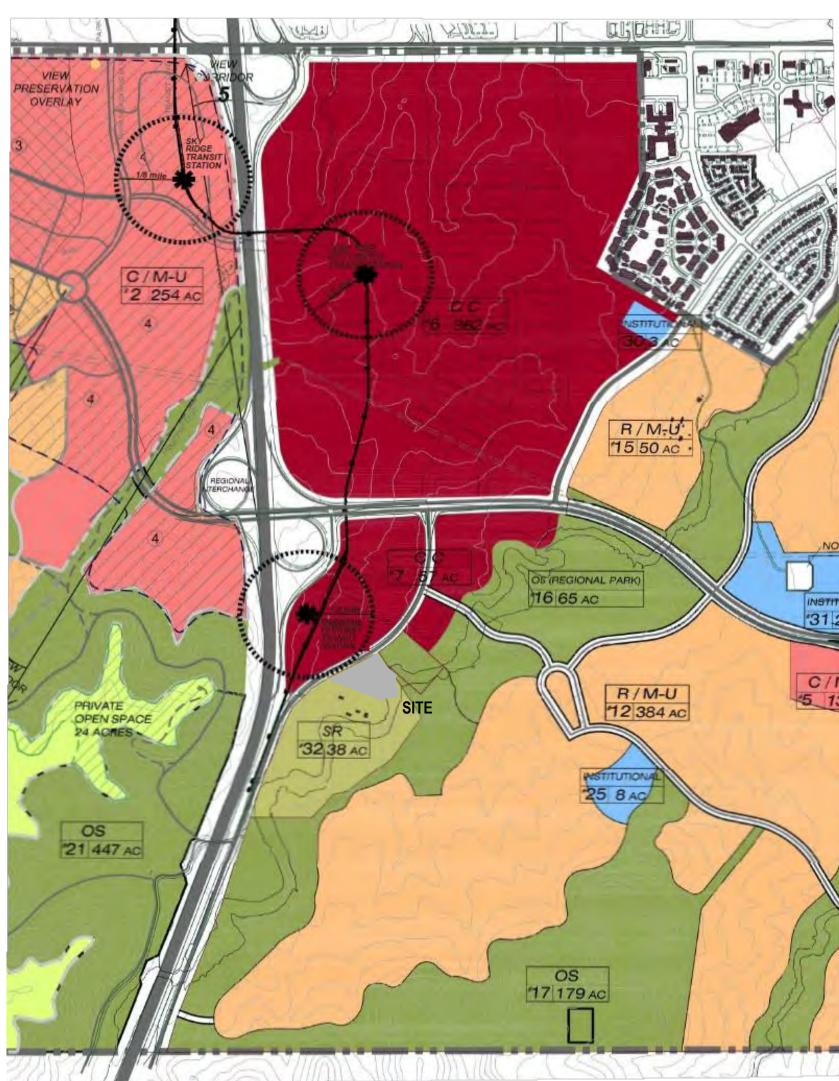

RIDGEGATE PDD

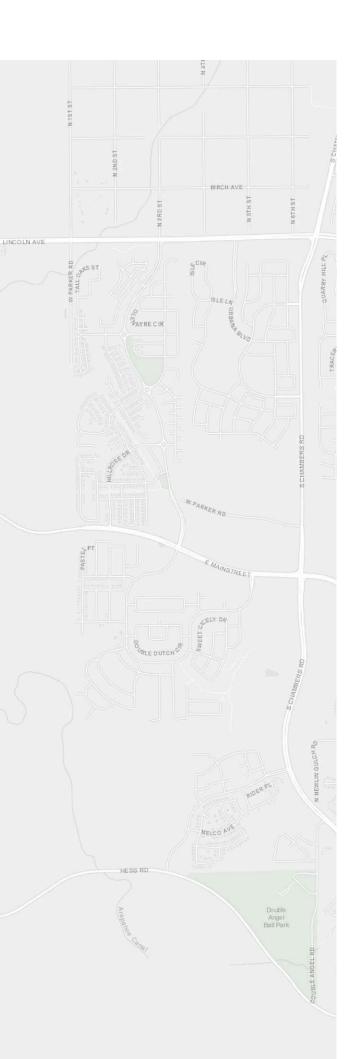

Esri, HERE, Garmin, (c) (

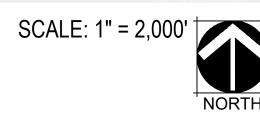


SCALE: 1" = 1,000'


SCALE: NTS






1101 Bannock Street Denver, Colorado 80204 P 303.892.1166 www.norris-design.com

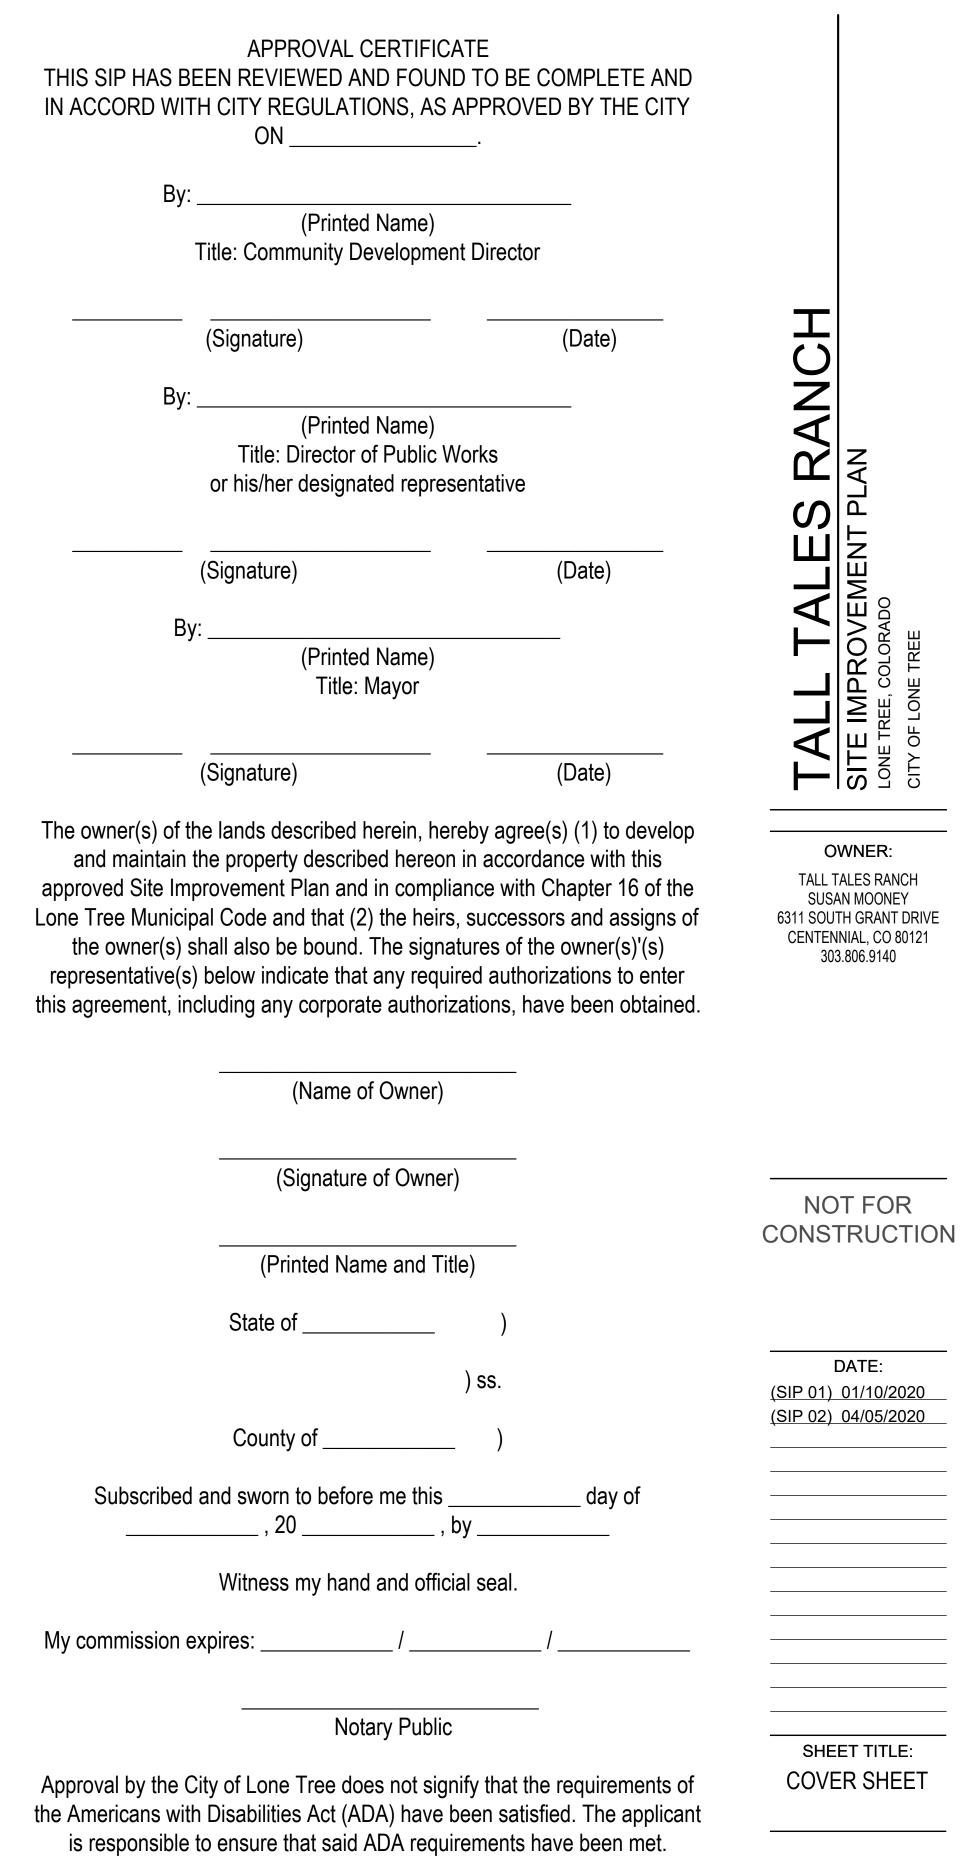

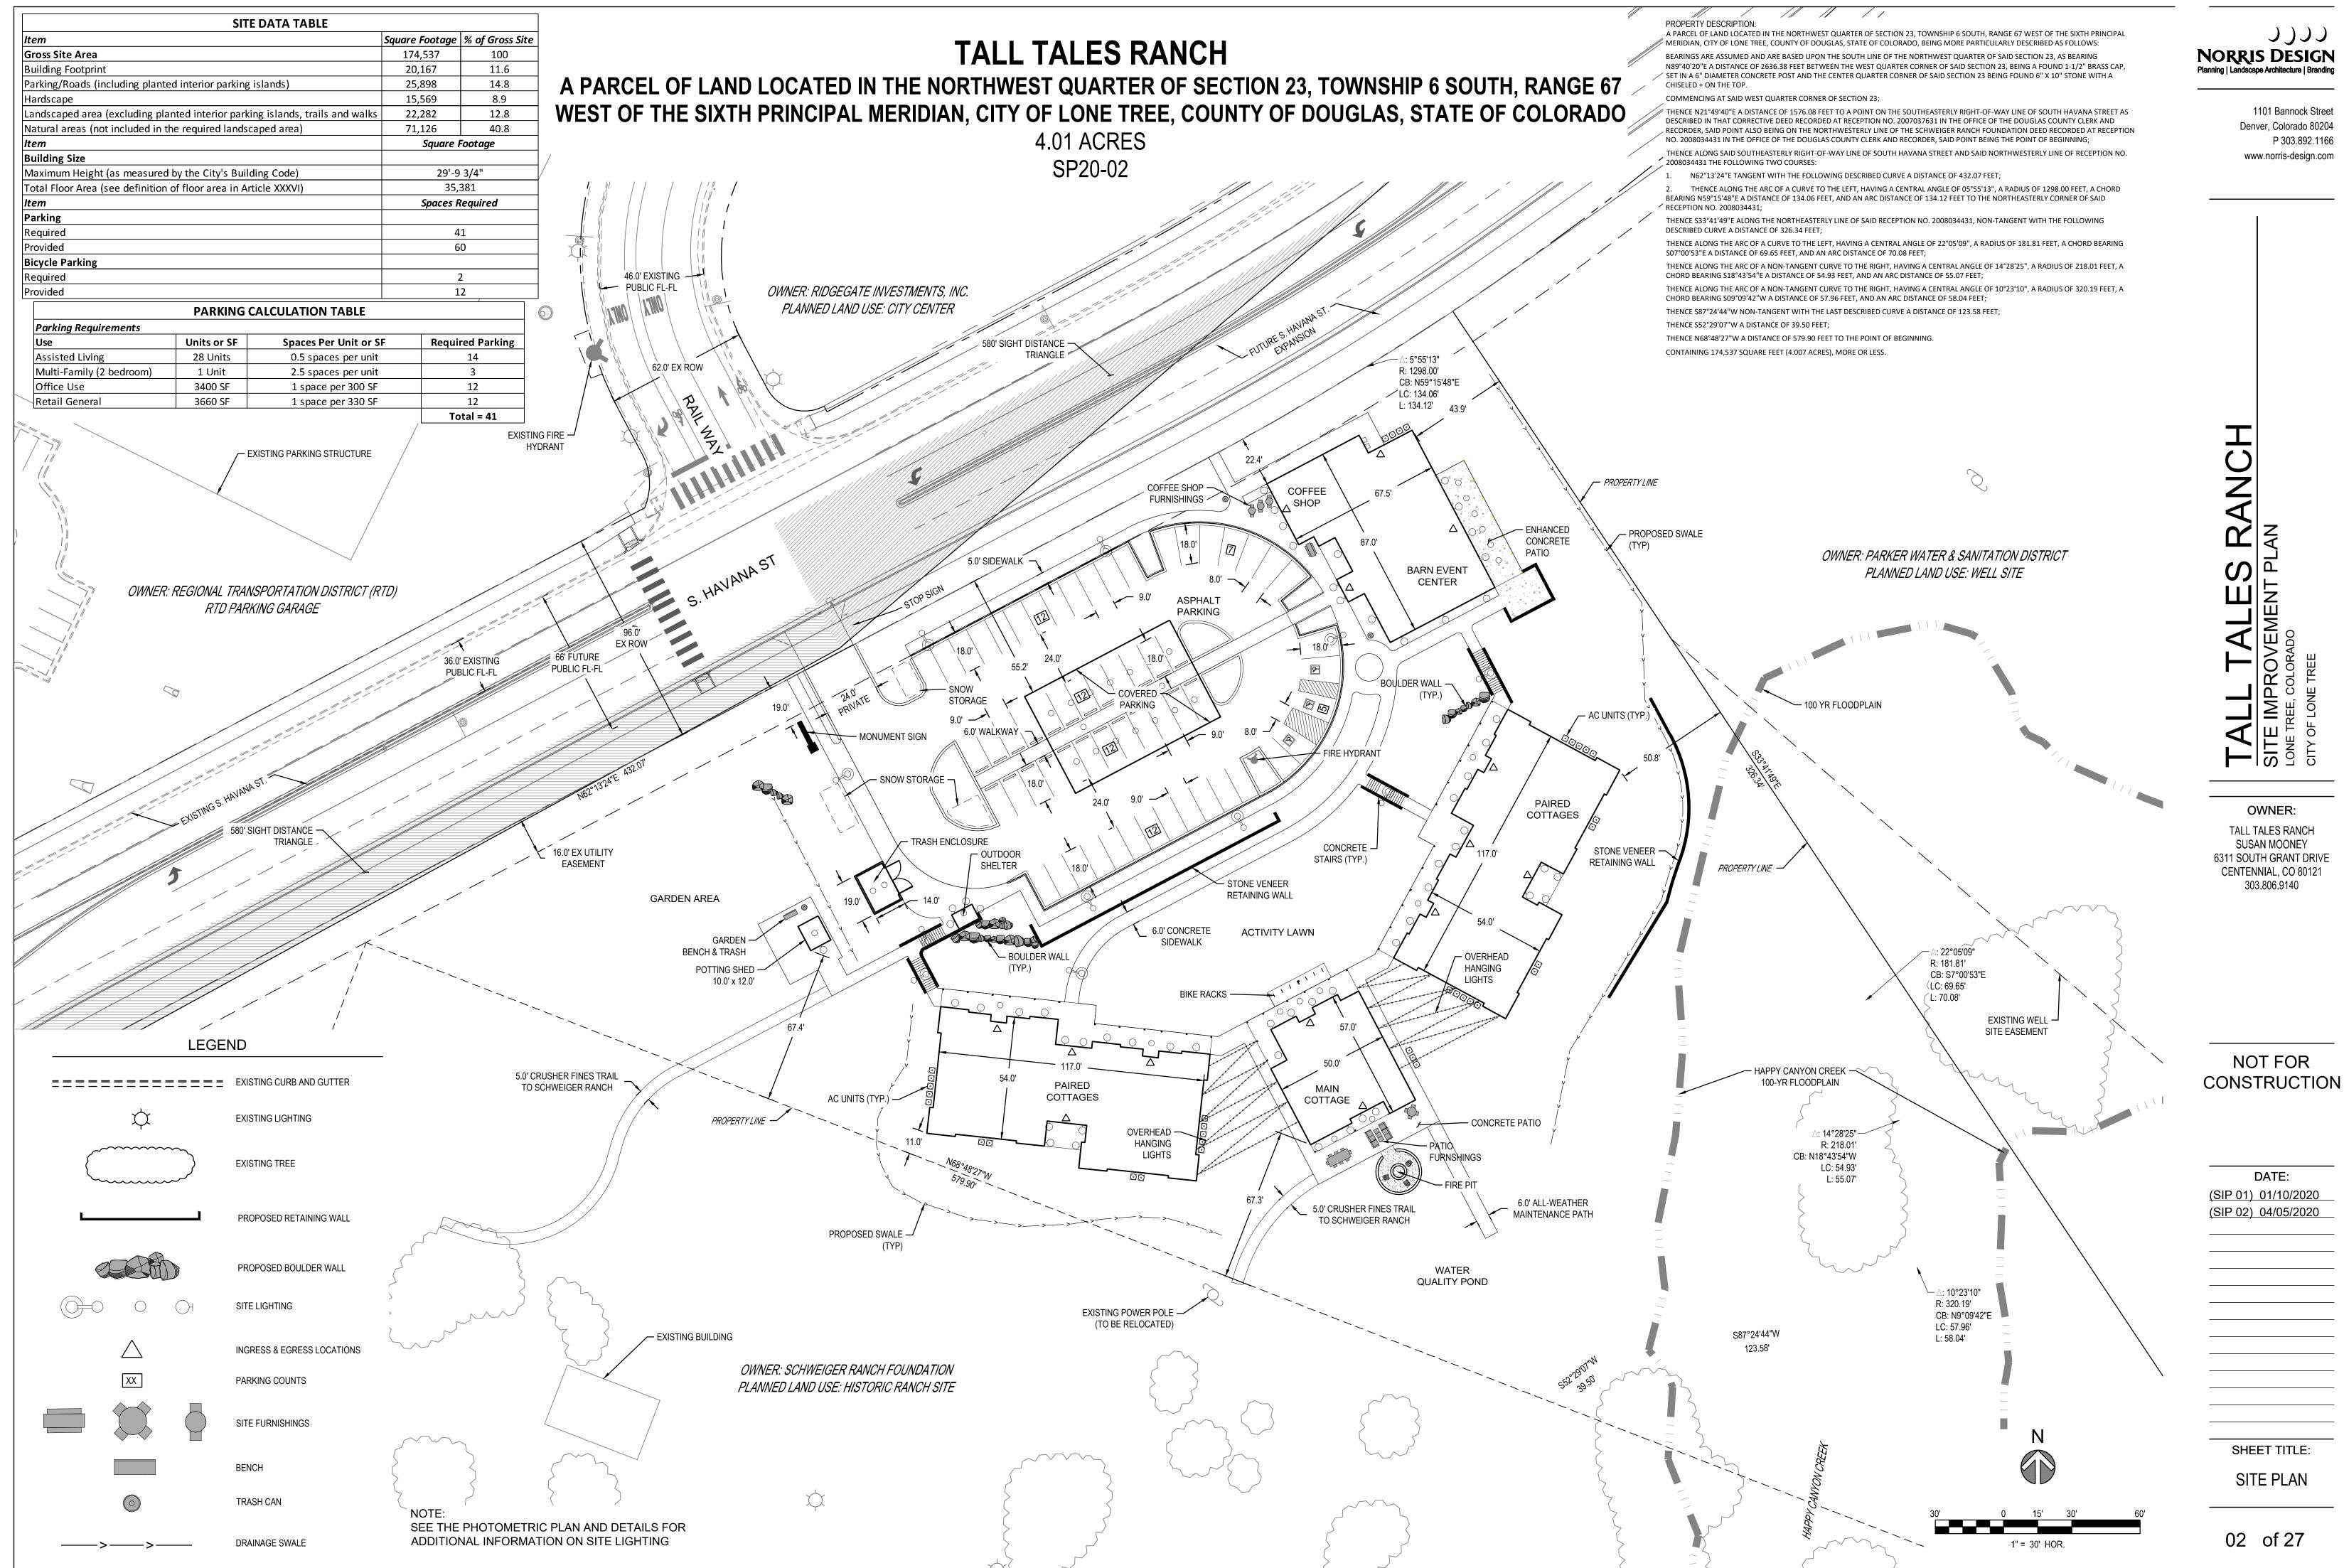



SM ЫŚ CHE

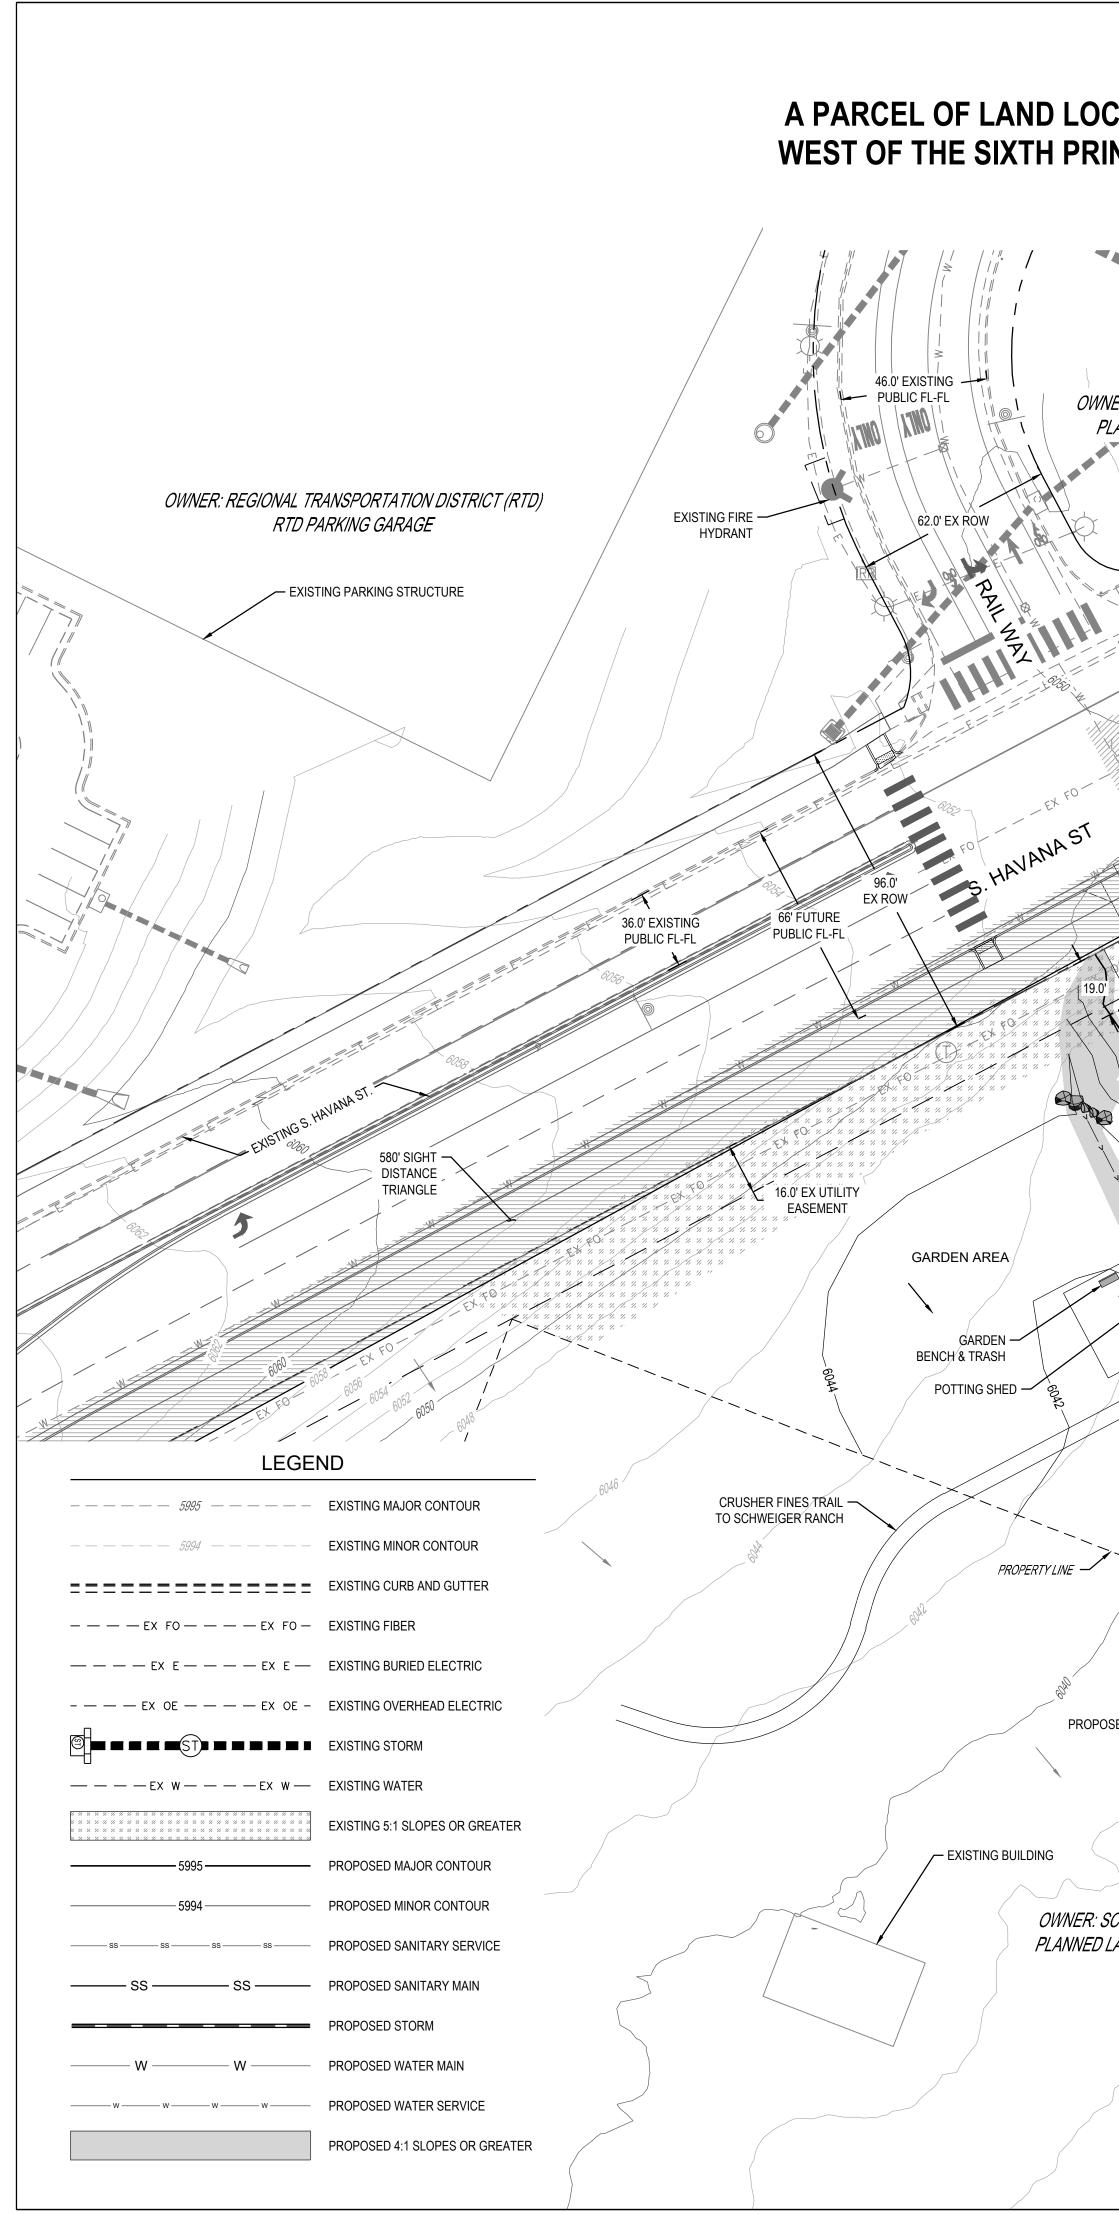

CHECKED BY: SM DRAWN BY: WW

TALL TALES RANCH A PARCEL OF LAND LOCATED IN THE NORTHWEST QUARTER OF SECTION 23, TOWNSHIP 6 SOUTH, RANGE 67 WEST OF THE SIXTH PRINCIPAL MERIDIAN, CITY OF LONE TREE, COUNTY OF DOUGLAS, STATE OF COLORADO 4.01 ACRES SP20-02 OWNER: RIDGEGATE INVESTMENTS, INC PLANNED LAND USE: CITY CENTER 580' SIGHT DISTANCE TRIANGLE COFFEE SHOP ENHANCED -CONCRETE PATIO BARN EVENT CENTER ASPHALT PARKING COVERED -WATER MAIN SANITARY MONUMENT SIGN (TYP.) - SANITARY SERVICE (TYP.) - BOULDER WALL PAIRED (TYP.) COTTAGES ENCLOSURE - STONE VENEER RETAINING WALL ACTIVITY LAWN 18 Doxoran OVERHEAD ----ELECTRIC TO BIKE RACKS BE RELOCATED - CONCRETE SIDEWALK MAIN WATER SERVICE ----COTTAGE (TYP.) PAIRED COTTAGES _>_>_> ->__>__> PROPOSED SWALE --6034 6036 (TYP) WATER QUALITY POND/ WALKING PATH — EXISTING ----POWER POLE PROPOSED – STORM SEWER OWNER: SCHWEIGER RANCH FOUNDATION PLANNED LAND USE: HISTORIC RANCH SITE

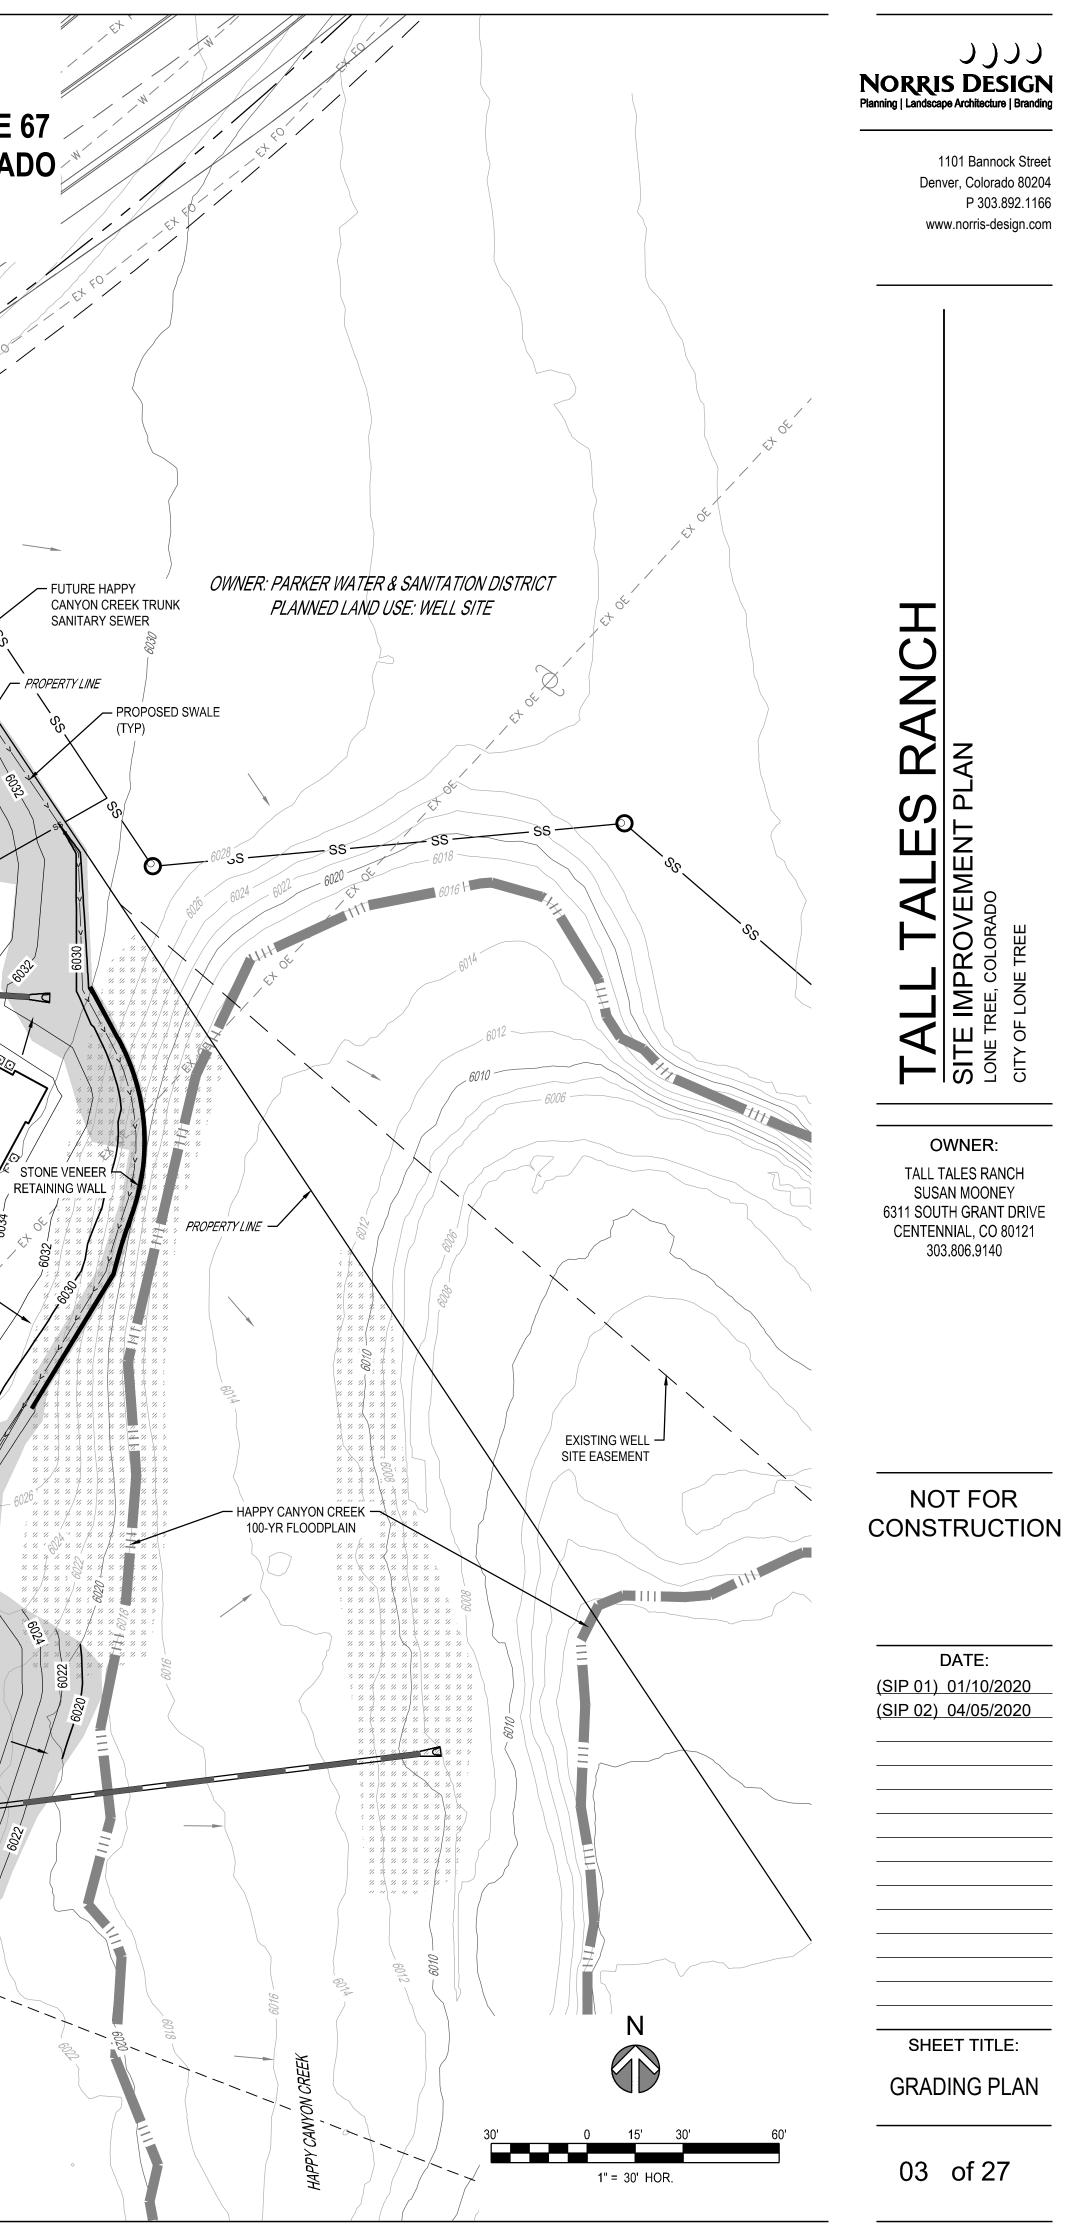

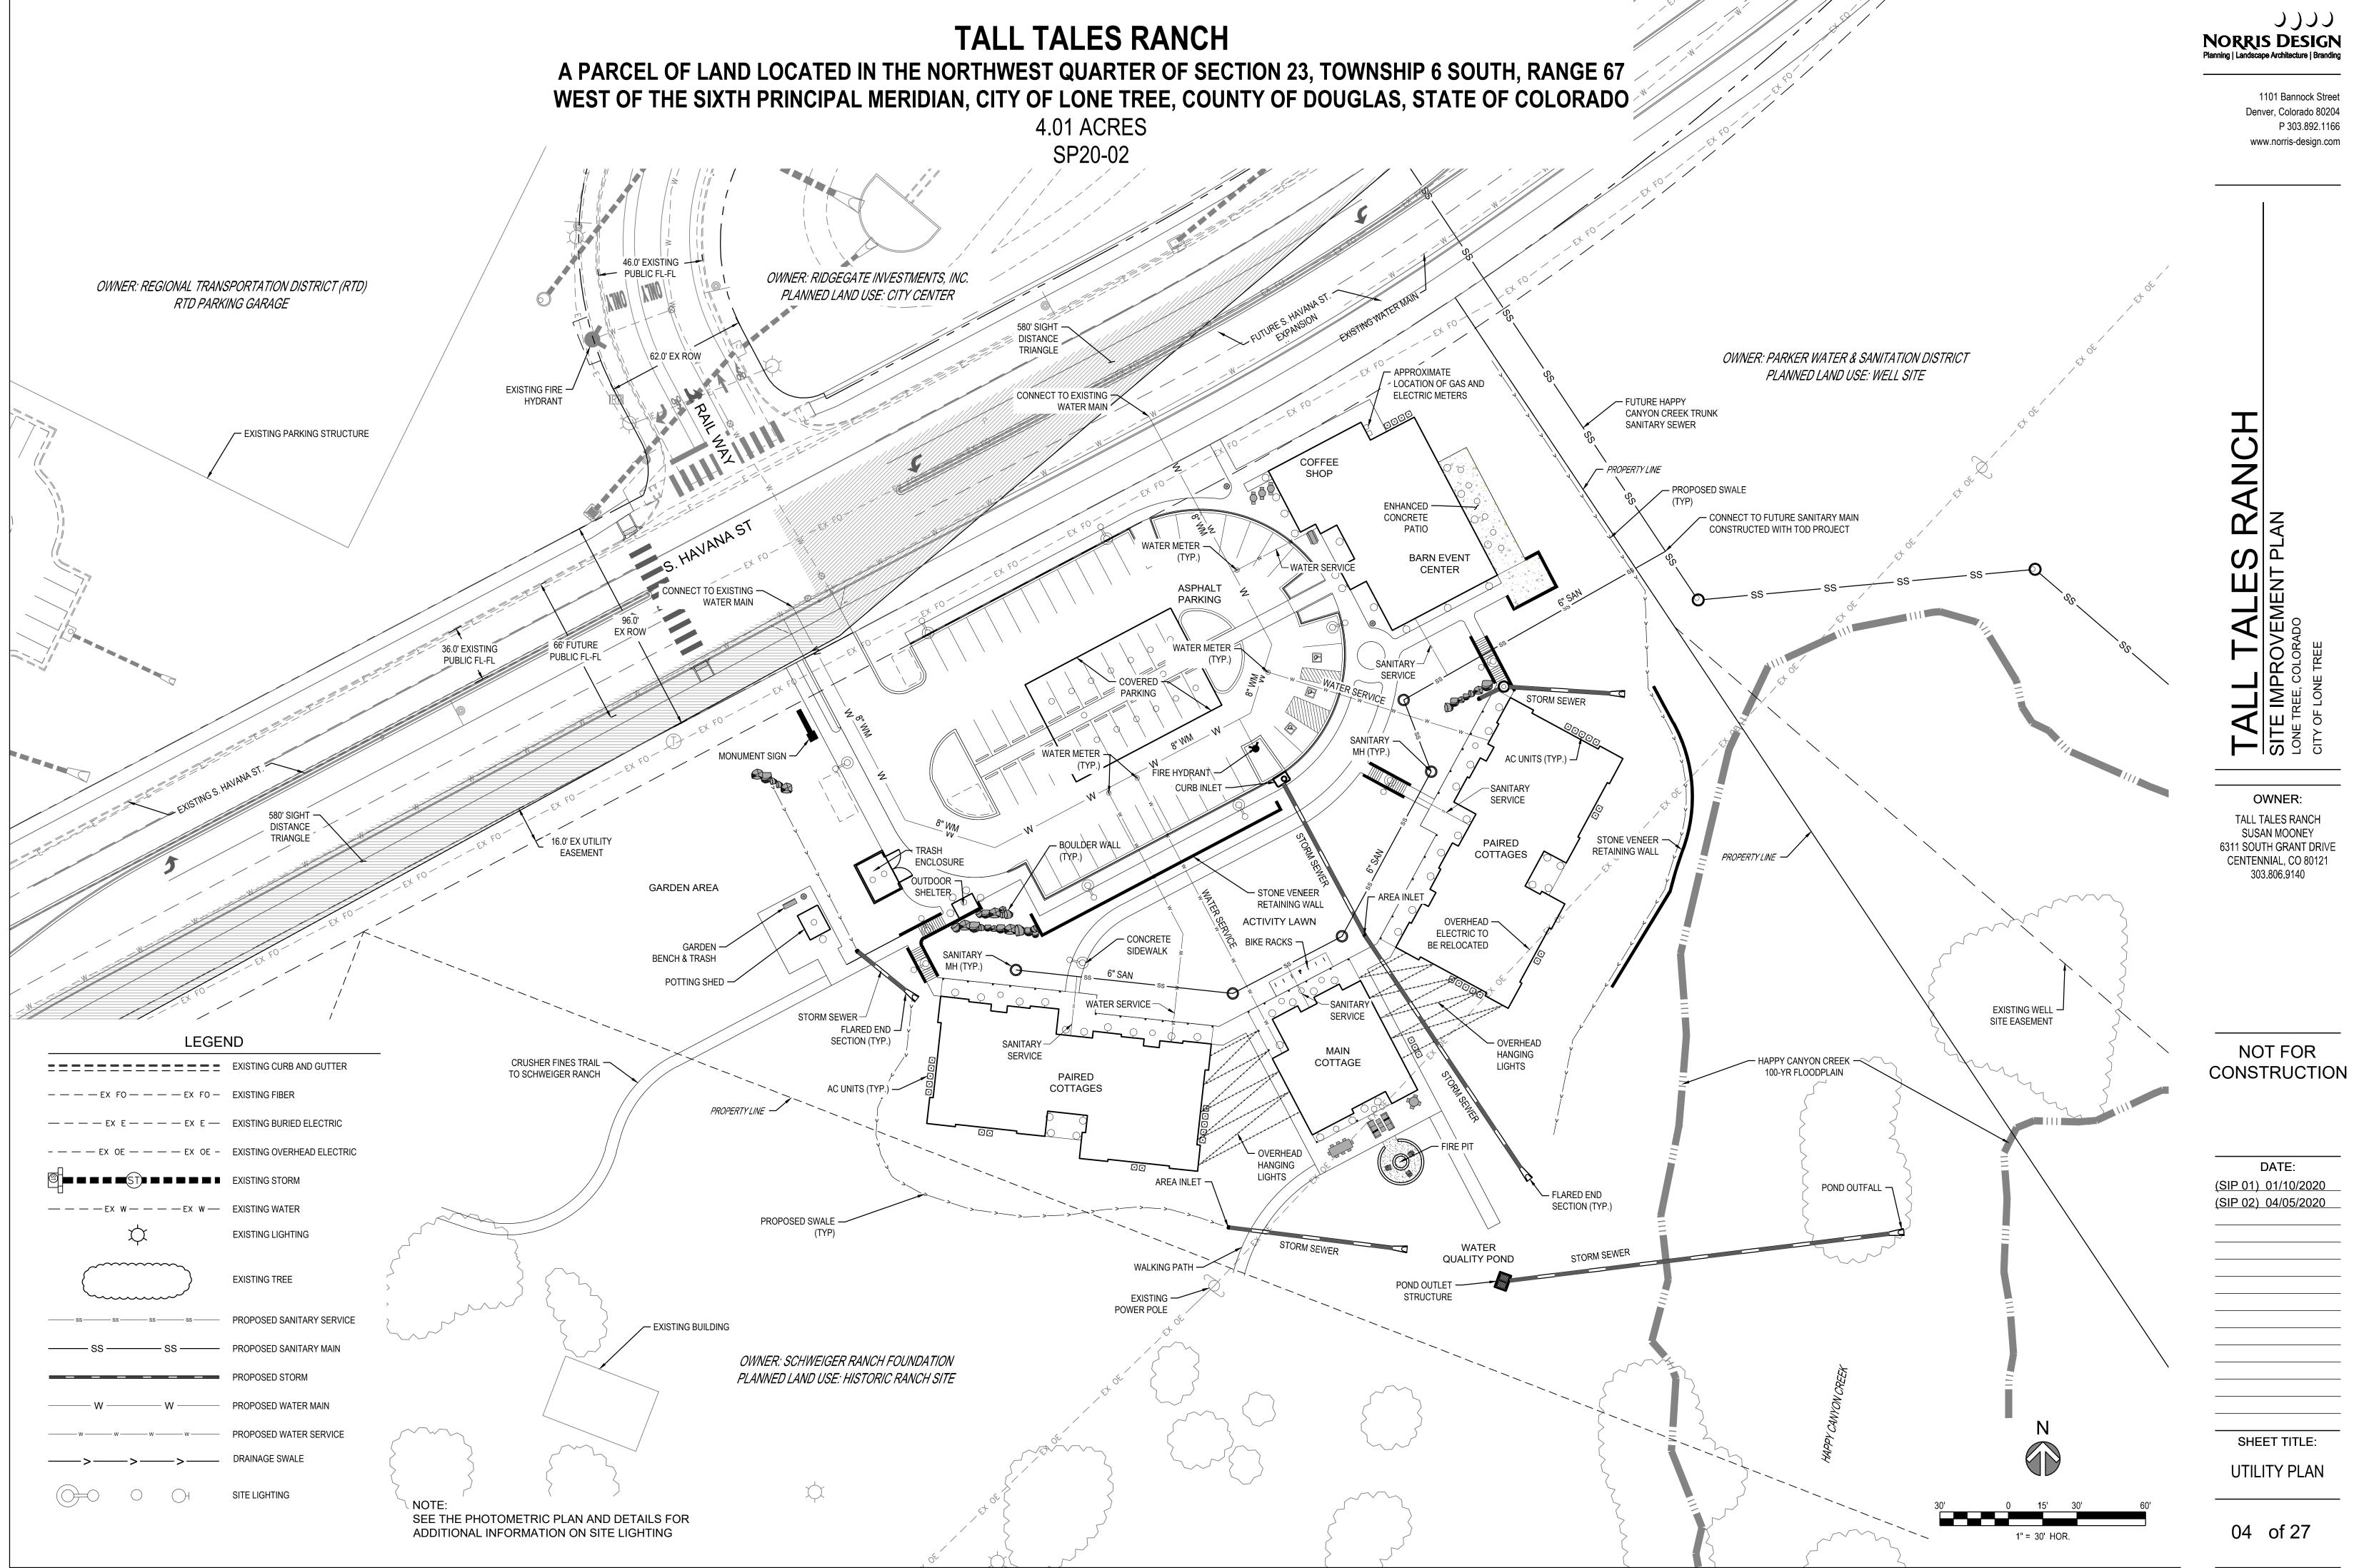

SM WW B N: B N: CHE

PLANT PALETTE				
SYM	. QTY	BOTANICAL NAME	COMMON NAME	SIZE & COND.
	DECIE	DUOUS CANOPY TREES		
CAH	2	CATALPA SPECIOSA 'HIAWATHAZ 2'	HEARTLAND CATALPA	2.5" CAL. B&B
LAN	1	POPULUS X ACUMINATA	LANCELEAF COTTONWOOD	2.5" CAL. B&B
BUR	3	QUERCUS MACROCARPA	BUR OAK	2.5" CAL. B&B
OAK	7	QUERCUS MUEHLENBERGI	CHINKAPIN OAK	2.5" CAL. B&B
SPH	, 4	STYPHNOLOBIUM JAPONICUM 'HALKA'	HALKA SCHOLAR TREE	2.5" CAL. B&B
TIL	1	TILIA AMERICANA 'REDMOND'	BASSWOOD	2.5" CAL. B&B
ELM	6	ULMUS WILSONIANA 'PROSPECTOR'	PROSPECTOR ELM	2.5" CAL. B&B
	-	<u>GREEN TREES</u>		2.0 0/12. Dab
PIN	11	PINUS EDULIS	PINION PINE	6' HT.
AUS	12	PINUS NIGRA	AUSTRIAN PINE	6' HT.
PON	16	PINUS PONDEROSA	PONDEROSA PINE	6' HT.
CBS	11	PICEA PUNGENS 'GLAUCA'	COLORADO BLUE SPRUCE	6' HT.
FIR	10	PSUEDOTSUGA MENZIESII	DOUGLAS FIR	6' HT.
	ORNA	MENTAL TREES		
SER	20	AMELANCHIER LAEVIS 'SPRING FLURRY'	SPRING FLURRY SERVICEBERRY	6' CLUMP, B&B
HAW	4	CRATAEGUS DOUGLASSII	DOUGLAS HAWTHORN	2" CAL. B&B
MAL	4	MALUS 'SPRING SNOW'	SPRING SNOW CRABAPPLE	2" CAL. B&B
CAP	6	PRUNUS AMERICANA 'CHINESE'	CHINESE APRICOT	2" CAL. B&B
BCP	6	PRUNUS AVIUM 'BING'	BING CHERRY	2" CAL. B&B
PIP	6	PRUNUS SALICINA 'PIPESTONE'	PIPESTONE PLUM	2" CAL. B&B
GAM	3	QUERCUS GAMBELII	GAMBLE OAK	6' CLUMP
TOTAL	. 133			
	EVER	GREEN SHRUBS		
PAN	4	ARCTOSTAPHYLOS X COLORADENSIS	PANCHITO MANZANITA	#5 CONT.
INK	4	ILEX GLABRA 'NORDIC'	NORDIC INKBERRY	#5 CONT.
GMJ	8	JUNIPERUS PROCUMBENS 'GREEN MOUND'	GREENMOUND JUNIPER	#5 CONT.
GOJ	13	JUNIPERUS VIRGINIANA 'GREY OWL'	GREY OWL JUNIPER	#5 CONT.
MUG	5	PINUS MUGO PUMILIO	DWARF MUGO PINE	#5 CONT.
SSP	10	PINUS SYLVESTRIS 'ALBYN PROSTRATA'	SPREADING SCOTS PINE	#5 CONT.
	DECIE	DUOUS SHRUBS 9'+ SPREAD		
NAN	2	PRUNUS TOMENTOSA	NANKING CHERRY	#5 CONT.
WIL	7	SALIX DISCOLOR	PUSSY WILLOW	#5 CONT.
DFV	10	VIBURNUM PLICATUM TOMENTOSUM 'MARIESII'	DOUBLEFILE VIBURNUM	#5 CONT.
	DECID	DUOUS SHRUBS 7-9' SPREAD		
REG	17	AMELANCHIER ALNIFOLIA 'REGENT'	REGENT SERVICEBERRY	#5 CONT.
FOR	41	FORSYTHIA 'SHOW OFF'	SHOW OFF FORSYTHIA	#5 CONT.
МОС	15	PHILADELPHUS LEWISII 'CHEYENNE'	CHEYENNE MOCKORANGE	#5 CONT.
TLS	16	RHUS TRILOBA	THREE LEAF SUMAC	#5 CONT.
AAS	8	RHUS TRILOBA 'AUTUMN AMBER'	AUTUMN AMBER SUMAC	#5 CONT.
	DECID	DUOUS SHRUBS 5-7' SPREAD		
AMO	16	AMORPHA CANESCENS	LEADPLANT	#5 CONT.
BAR	16	BERBERIS X EMERALD CAROUSEL	EMERALD CAROUSEL BARBERRY	#5 CONT.
RBA	12	ERICAMERIA NAUSEOSA SSP. NAUSEOSA VAR. SPECIOSA	TALL BLUE RABBITBRUSH	#5 CONT.
ERI	31	ERICAMERIA NAUSEOSA SSP. NAUSEOSA VAR. NAUSEOSA	DWARF BLUE RABBITBRUSH	#5 CONT.
FGT	32	FORSYTHIA 'GOLD TIDE'	GOLD TIDE FORSYTHIA	#5 CONT.
HON	16	LONICERA INVOLUCRATA	TWINBERRY HONEYSUCKLE	#5 CONT.
PBS	11	PRUNUS BESSEYI 'PAWNEE BUTTES'	PAWNEE BUTTES SANDCHERRY	#5 CONT.
CUR	7	RIBES AUREUM 'GWENS BUFFALO'	GWEN'S BUFFALO CURRANT	#5 CONT.
WAX	32	RIBES CEREUM	WAX CURRANT	#5 CONT.
ROS	35	ROSA WOODSII	WOODS ROSE	#5 CONT.
RAS	5	RUBUS DELICIOSUS	BOULDER RASPBERY	#5 CONT.
	-	DUOUS SHRUBS 2-5' SPREAD		
СНО	15	ARONIA MELANOCARPA 'LOW SCAPE MOUND'	LOW SCAPE CHOKEBERRY	#5 CONT.
BMS	34	CARYOPTERIS X CLANDONENSIS 'FIRST CHOICE'	FIRST CHOICE BLUE MIST SPIREA	#5 CONT.
AFD	34	CORNUS SERICIA 'ARCTIC FIRE'	ARCTIC FIRE DOGWOOD	#5 CONT.
VSS	3	ITEA VIRGINICA 'LITTLE HENRY'	LITTLE HENRY ITEA	#5 CONT.
RSA	49	PEROVSKIA ATRIPLICIFOLIA 'LITTLE SPIRE'	LITTLE SPIRE RUSSIAN SAGE	#5 CONT.
TOTAL				

MS W CHECKED BY DRAWN BY:

TALL TALES RANCH

4.01 ACRES

SP20-02

SYM	. QTY	. BOTANICAL NAME	COMMON NAME	SIZE & COND.
	ORNA	AMENTAL GRASSES		
BAG	431	BOUTELOUA GRACILIS 'BLONDE AMBITION'	BLONDE AMBITION GRASS	#1 CONT.
KFR	177	CALAMAGROSTIS BRACHYTRICHA	KOREAN FEATHER REED	#1 CONT.
RSG	609	PANICUM VIRGATUM 'CHEYENNE SKY'	CHEYENNE SKY SWITCHGRASS	#1 CONT.
HFG	61	PENNISETUM ALOPECUROIDES 'HAMELN'	HAMELN FOUNTAIN GRASS	#1 CONT.
LBS	148	SCHIZACHYRIUM SCOPARIUM 'BLUE HEAVEN'	BLUE HEAVEN LITTLE BLUESTEM	#1 CONT.
PDS	466	SPOROBOLUS HETEROLEPIS	PRAIRIE DROPSEED	#1 CONT.
	PERE	INNIALS		
AGA	9	AGASTACHE AURANTIACA 'P012S'	CORONADO HYSSOP	#1 CONT.
ANE	5	ANEMONE X HYBRIDA 'HONORINE JOBERT'	HONORINE JOBERT ANEMONE	#1 CONT.
AST	42	ASTER NOVI-BELGII 'PROFESSOR KIPPENBURG'	DWARF BLUE FALL ASTER	#1 CONT.
BAP	12	BAPTISIA AUSTRALIS	FALSE INDIGO	#1 CONT.
VAL	33	CENTRANTHUS RUBER	RED VALERIAN	#1 CONT.
COR	30	COREOPSIS LANCEOLATA 'STERNTALER'	STERNTALER COREOPSIS	#1 CONT.
ECH	64	ECHINACEA PURPUREA	PURPLE CONEFLOWER	#1 CONT.
JPW	13	EUTROCHIUM PURPUREUM	JOE PYE WEED	#1 CONT.
GAL	26	GALIUM ODORATUM	SWEET WOODRUFF	#1 CONT.
BGH	47	HOSTA SIEBOLDIANA 'ELEGANS'	BLUE GIANT HOSTA	#1 CONT.
HOS	56	HOSTA 'HONEYBELLS'	HONEYBELLS HOSTA	#1 CONT.
LAV	15	LAVENDULA ANGUSTIFOLIA 'MUNSTEAD'	ENGLISH LAVENDER	#1 CONT.
NGF	24	LIATRIS PUNCTATA	NATIVE GAYFEATHER	#1 CONT.
LUP	9	LUPINUS 'GALLERY BLUE'	DWARF BLUE LUPINE	#1 CONT.
BEE	32	MONARDA 'BLUE STOCKING'	BLUE BEE BALM	#1 CONT.
CAT	18	NEPETA X LITTLE TRUDY	LITTLE TRUDY CATNIP	#1 CONT.
PEN	41	PENSTEMON ANGUSTIFOLIUS	ROCKY MOUNTAIN PENSTEMON	#1 CONT.
FCP	26	PENSTEMON EATONII	FIRECRACKER PENSTEMON	#1 CONT.
GAR	12	SALVIA OFFICINALIS	GARDEN SAGE	#1 CONT.
RUD	43	RUDBECKIA GOLDSTRUM	RUDBECKIA FULGIDA 'GOLDSTURM'	#1 CONT.
VER	6 . 2455	VERBENA BIPINNATIFIDA	VERBENA	#1 CONT.

IRRIGATED NATIVE GRASS MIX

ARKANSAS VALLEY SEED FOOTHILLS MIX OR APPROVED EQUAL

COMMON NAME ANNUAL RYEGRASS SLENDER WHEATGRA CRESTED WHEATGRA MOUNTAIN BROME HARD FESCUE CANADA BLUEGRASS SIDEOATS GRAMA	20% ASS 15% ASS 12% 10% 10%	AL PLS / ACRE 4.0 3.0 2.4 2.0 2.0 2.0 1.2
BIG BLUESTEM BLUE GRAMA SWITCHGRASS SAND DROPSEED	6% 5% 5% 1%	1.2 1.0 1.0 0.2
	TOTAL 100%	20

TOTAL 100%

NO MOW TURFGRASS

SELF-REPAIRING TALL FESCUE SOD, TURF MASTER OR APPROVED EQUAL

LANDSCAPE AREAS

GRAND TOTAL	84,942
LANDSCAPE BED TURF NO-MOW TURF NATIVE GRASS COBBLE TOTAL	207 3,692 0 2,530 1,247 7,676
LANDSCAPE BED TURF NO-MOW TURF NATIVE GRASS COBBLE TOTAL OFF SITE AND R.O.W.	26,400 5,110 11,846 29,827 4,083 77,266
ON SITE	SQ. FT

	S A
2.	C T
3.	P T
0.	S
	P S
4.	A T
4.	S P
	Ρ
_	A N
5.	T A
6.	P R
	S S
	B T
7.	L/ L(
8.	P T
	L/ F(
	R U
	0 2'
9.	O P
	C S
10.	A T
11.	T O
12.	T T
	A C
13.	A A
14.	A R
15.	B
15.	A IF T
16.	А
17.	R S
	T C
18.	R A
19.	C A
20.	F D
21.	M C
22.	S A
	IN C
23.	W

)))))**NORRIS DESIGN** lanning | Landscape Architecture | Branding

1101 Bannock Street Denver, Colorado 80204 P 303.892.1166 www.norris-design.com

GENERAL LANDSCAPE NOTES

 THE CONTRACTOR SHALL FOLLOW THE LANDSCAPE PLANS AND SPECIFICATIONS AS CLOSELY AS POSSIBLE. ANY SUBSTITUTION OR ALTERATION SHALL NOT BE ALLOWED WITHOUT APPROVAL OF THE OWNER'S REPRESENTATIVE AND THE CITY COMMUNITY DEVELOPMENT DEPARTMENT. OVERALL PLANT QUANTITY AND QUALITY SHALL BE CONSISTENT WITH THE PLANS.

THE CONTRACTOR IS RESPONSIBLE FOR VERIFYING ALL PLANT QUANTITIES. GRAPHIC QUANTITIES TAKES RECEDENCE OVER WRITTEN QUANTITIES.

THE OWNER'S REPRESENTATIVE RESERVES THE RIGHT TO INSPECT AND TAG ALL PLANT MATERIAL PRIOR TO SHIPPING TO THE SITE. IN ALL CASES. THE OWNER'S REPRESENTATIVE MAY REJECT PLANT MATERIAL AT THE SITE $^{
m F}$ MATERIAL IS DAMAGED, DISEASED, OR DECLINING IN HEALTH AT THE TIME OF ONSITE INSPECTIONS OR IF THE PLANT MATERIAL DOES NOT MEET THE MINIMUM SPECIFIED STANDARD IDENTIFIED ON THE PLANS AND IN THE SPECIFICATIONS. THE CONTRACTOR SHALL COORDINATE WITH THE OWNER'S REPRESENTATIVE FOR INSPECTION AND APPROVAL OF ALL MATERIALS AND PRODUCTS PRIOR TO INSTALLATION

THE OWNER'S REPRESENTATIVE MAY ELECT TO UPSIZE PLANT MATERIAL AT THEIR DISCRETION BASED ON SELECTION, AVAILABILITY, OR TO ENHANCE SPECIFIC AREAS OF THE PROJECT. THE CONTRACTOR SHALL VERIFI PLANT MATERIAL SIZES WITH OWNER'S REPRESENTATIVE PRIOR TO PURCHASING. SHIPPING OR STOCKING OF PLANT MATERIALS. SUBMIT CHANGE ORDER REQUEST TO OWNER'S REPRESENTATIVE FOR APPROVAL IF ADDITIONAL COST IS REQUESTED BY THE CONTRACTOR PRIOR TO INSTALLATION. RE-STOCKING CHARGES WILI

NOT BE APPROVED IF THE CONTRACTOR FAILS TO SUBMIT A REQUEST FOR MATERIAL CHANGES. THE CONTRACTOR SHALL WARRANTY ALL CONTRACTED WORK AND MATERIALS FOR A PERIOD OF ONE YEAR AFTER SUBSTANTIAL COMPLETION HAS BEEN ISSUED BY THE OWNER'S REPRESENTATIVE FOR THE ENTIRE PROJECT UNLESS OTHERWISE SPECIFIED IN THE CONTRACT DOCUMENTS OR SPECIFICATIONS.

REFER TO IRRIGATION PLANS FOR LIMITS AND TYPES OF IRRIGATION DESIGNED FOR THE LANDSCAPE. IN NO CASE SHALL IRRIGATION BE EMITTED WITHIN THE MINIMUM DISTANCE FROM BUILDING OR WALL FOUNDATIONS AS STIPULATED IN THE GEOTECHNICAL REPORT. ALL IRRIGATION DISTRIBUTION LINES, HEADS AND EMITTERS SHALL BE KEPT OUTSIDE THE MINIMUM DISTANCE AWAY FROM ALL BUILDING AND WALL FOUNDATIONS AS STIPULATED IN THE GEOTECHNICAL REPORT.

LANDSCAPE MATERIAL LOCATIONS SHALL HAVE PRECEDENCE OVER IRRIGATION MAINLINE AND LATERAL OCATIONS. COORDINATE INSTALLATION OF IRRIGATION EQUIPMENT SO THAT IT DOES NOT INTERFERE WITH THE PLANTING OF TREES OR OTHER LANDSCAPE MATERIAL

THE LANDSCAPE CONTRACTOR SHALL BE RESPONSIBLE FOR ENSURING POSITIVE DRAINAGE EXISTS IN ALL ANDSCAPE AREAS. SURFACE DRAINAGE ON LANDSCAPE AREAS SHALL NOT FLOW TOWARD STRUCTURES AND OUNDATIONS. MAINTAIN SLOPE AWAY FROM FOUNDATIONS PER THE GEOTECHNICAL REPORT

RECOMMENDATIONS. ALL LANDSCAPE AREAS BETWEEN WALKS AND CURBS SHALL DRAIN FREELY TO THE CURB JNLESS OTHERWISE IDENTIFIED ON THE GRADING PLAN. IN NO CASE SHALL THE GRADE, TURF THATCH, OR OTHER LANDSCAPE MATERIALS DAM WATER AGAINST WALKS. MINIMUM SLOPES ON LANDSCAPE AREAS SHALL BE 2%; MAXIMUM SLOPE SHALL BE 25% UNLESS SPECIFICALLY IDENTIFIED ON THE PLANS OR APPROVED BY THE OWNER'S REPRESENTATIVE.

PRIOR TO INSTALLATION OF PLANT MATERIALS, AREAS THAT HAVE BEEN COMPACTED OR DISTURBED BY CONSTRUCTION ACTIVITY SHALL BE THOROUGHLY LOOSENED TO A DEPTH OF 8" - 12" AND AMENDED PER SPECIFICATIONS.

10. ALL LANDSCAPED AREAS ARE TO RECEIVE ORGANIC SOIL PREPARATION AT 4 CU.YRDS/1,000SF OR AS NOTED IN THE TECHNICAL SPECIFICATIONS.

TREES SHALL NOT BE LOCATED IN DRAINAGE SWALES, DRAINAGE AREAS, OR UTILITY EASEMENTS. CONTACT DWNER'S REPRESENTATIVE FOR RELOCATION OF PLANTS IN QUESTIONABLE AREAS PRIOR TO INSTALLATION. 12. THE CENTER OF EVERGREEN TREES SHALL NOT BE PLACED CLOSER THAN 8' AND THE CENTER OF ORNAMENTAL REES CLOSER THAN 6' FROM A SIDEWALK, STREET OR DRIVE LANE. EVERGREEN TREES SHALL NOT BE LOCATED ANY CLOSER THAN 15' FROM IRRIGATION ROTOR HEADS. NOTIFY OWNER'S REPRESENTATIVE IF TREE LOCATIONS CONFLICT WITH THESE STANDARDS FOR FURTHER DIRECTION.

13. ALL EVERGREEN TREES SHALL BE FULLY BRANCHED TO THE GROUND AND SHALL NOT EXHIBIT SIGNS OF ACCELERATED GROWTH AS DETERMINED BY THE OWNER'S REPRESENTATIVE.

ALL TREES ARE TO BE STAKED AND GUYED PER DETAILS FOR A PERIOD OF 1 YEAR. THE CONTRACTOR SHALL BE RESPONSIBLE FOR REMOVING STAKES AT THE END OF 1 YEAR FROM ACCEPTANCE OF LANDSCAPE INSTALLATION 3Y THE OWNER'S REPRESENTATIVE. OBTAIN APPROVAL BY OWNER'S REPRESENTATIVE PRIOR TO REMOVAL. ALL TREES INSTALLED ABOVE RETAINING WALLS UTILIZING GEO-GRID MUST BE HAND DUG TO PROTECT GEO-GRID. F GEO-GRID MUST BE CUT TO INSTALL TREES, APPROVAL MUST BE GIVEN BY OWNER'S REPRESENTATIVE PRIOR TO DOING WORK.

ALL TREES IN SEED OR TURF AREAS SHALL RECEIVE MULCH RINGS. OBTAIN APPROVAL FROM OWNER'S REPRESENTATIVE FOR ANY TREES THAT WILL NOT BE MULCHED FOR EXCESSIVE MOISTURE REASONS. SHRUB, GROUNDCOVER AND PERENNIAL BEDS ARE TO BE CONTAINED BY 4" x 14 GAUGE GREEN, ROLL TOP, INTERLOCKING TYPE EDGER, RYERSON OR EQUAL. EDGER IS NOT REQUIRED WHEN ADJACENT TO CURBS, WALLS, WALKS OR SOLID FENCES WITHIN 3" OF PRE-MULCHED FINAL GRADE. EDGER SHALL NOT BE

REQUIRED TO SEPARATE MULCH TYPES UNLESS SPECIFIED ON THE PLANS. ALL SHRUB BEDS ARE TO BE MULCHED WITH MIN. 4" DEPTH, GORILLA HAIR WOOD MULCH. NO GEOTEXTILE WEED CONTROL FABRIC IS REQUIRED.

19. AT SEED AREA BOUNDARIES ADJACENT TO EXISTING NATIVE AREAS, OVERLAP ABUTTING NATIVE AREAS BY THE FULL WIDTH OF THE SEEDER.

DISTURBED NATIVE AREAS WHICH ARE TO REMAIN SHALL BE OVER SEEDED AND RESTORED WITH SPECIFIED SEED ЛIX

CONTRACTOR SHALL OVER SEED ALL MAINTENANCE OR SERVICE ACCESS BENCHES AND ROADS WITH SPECIFIED SEED MIX UNLESS OTHERWISE NOTED ON THE PLANS.

ALL SEEDED SLOPES EXCEEDING 25% IN GRADE (4:1) SHALL RECEIVE EROSION CONTROL BLANKETS. PRIOR TO NSTALLATION, NOTIFY OWNER'S REPRESENTATIVE FOR APPROVAL OF LOCATION AND ANY ADDITIONAL COST IF A CHANGE ORDER IS NECESSARY.

23. WHEN COMPLETE, ALL GRADES SHALL BE WITHIN +/- 1/8" OF FINISHED GRADES AS SHOWN ON THE PLANS. 24. SOFT SURFACE TRAILS NEXT TO MANICURED TURF OR SHRUB BEDS SHALL BE CONTAINED WITH 6" x 14 GAUGE GREEN ROLL TOP EDGER, RYERSON OR EQUAL.

25. PRIOR TO THE PLACEMENT OF MULCH, A GRANULAR, PRE-EMERGENT, WEED CONTROL AGENT SHALL BE ADDED TO ALL PLANTING BEDS IN ACCORDANCE WITH THE MANUFACTURER'S INSTRUCTION, EXCEPT AROUND ORNAMENTAL GRASSES.



OWNER:


TALL TALES RANCH SUSAN MOONEY 6311 SOUTH GRANT DRIVE CENTENNIAL, CO 80121 303.806.9140

NOT FOR CONSTRUCTION

DATE: (SIP 01) 01/10/2020 <u>(SIP 02) 04/05/2020</u>


> SHEET TITLE: LANDSCAPE SCHEDULE

TALL TALES RANCH A PARCEL OF LAND LOCATED IN THE NORTHWEST QUARTER OF SECTION 23, TOWNSHIP 6 SOUTH, RANGE 67 WEST OF THE SIXTH PRINCIPAL MERIDIAN, CITY OF LONE TREE, COUNTY OF DOUGLAS, STATE OF COLORADO 4.01 ACRES SP20-02 16.0' UTILITY EÁSÉMENT PROPERTY LINE WELL SITE EASEMENT EVENT CENTER PATIO COFFEE SHOP WITH ENHANCED CONCRETE FINISH -12 PLANTERS (2 BARN EVENT CENTER BISTRO TABLES (3) 2 LITTER RECEPTACLE PICNIC TABLE ASPHALT PARKING LOT SNOW STORAGE COVERED PARKING MONUMENT FLAGSTONE PATH CONCRETE STAIR - SNOW STORAGE - CONCRETE BUS PAD - TRASH ENCLOSURE, I OUTDOOR SHELTER, PAIRED RE: ARCH COTTAGES STONE VENEER RETAINING BLOCK RETAINING WALL, 3 BIKE RACK (6) **RE: CIVIL PLANS** – 100-YEAR FLOOD ACTIVITY PLAIN LIMIT LAWN POTTING SHED, RE: ARCH SPLIT-RAIL FENCE WITH MESH The second secon MAIN COTTAGE PAIRED COTTAGES 5 FOUR SEAT TABLE ČERAMIĆ GRILL PORCH SWING (2) 44X-GAS GRILL PLANTERS (6) 🗸 12 LŎUŇGĚ (Ž) OMMUNITY TABLE EXISTING NATIVE TO 10 COFFEE TABLÉ REMAIN FIRE PIT ČeŠ ADIŘOŇĎAČK ČHAIŘ (6) ØD BĂCK POŘCH TRĚLLIS WATER QUALIT CRUSHER FINES. POND, RE: CIVIL WALKING PATH SH 08

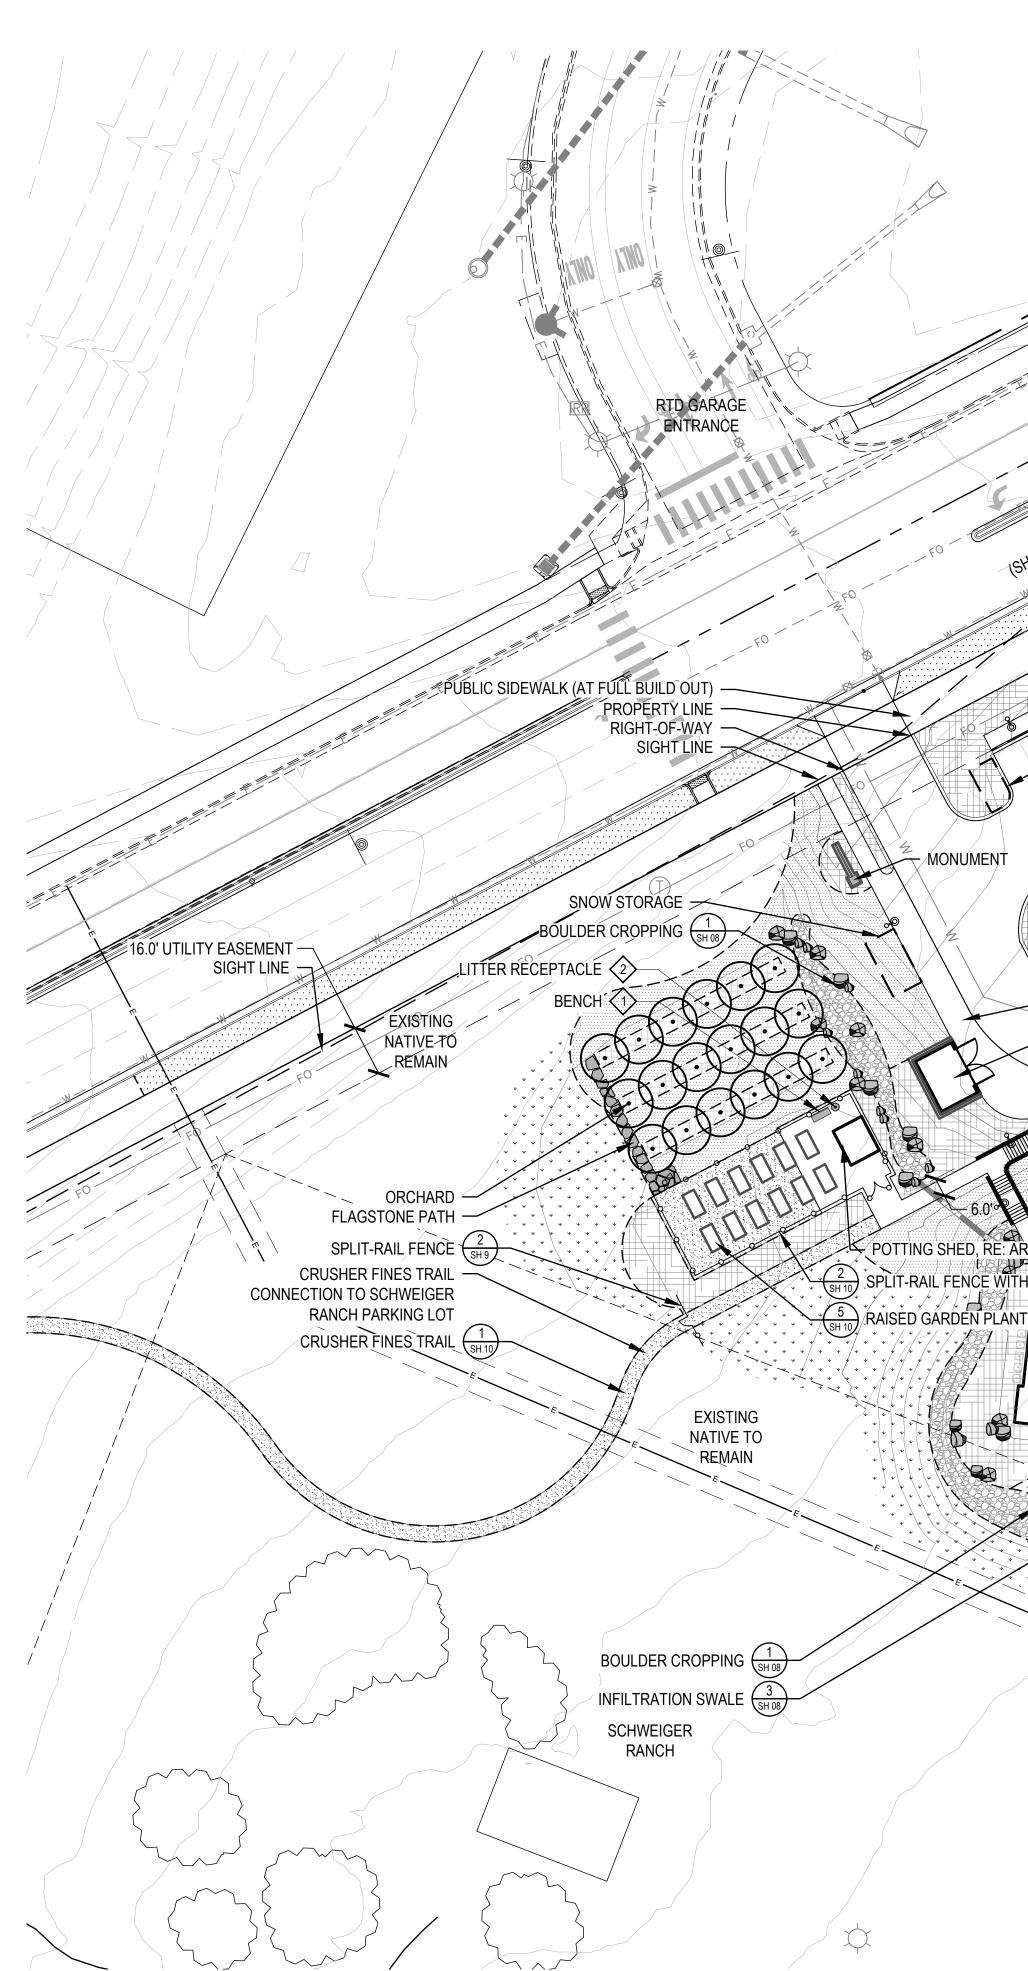



1101 Bannock Street Denver, Colorado 80204 P 303.892.1166 www.norris-design.com

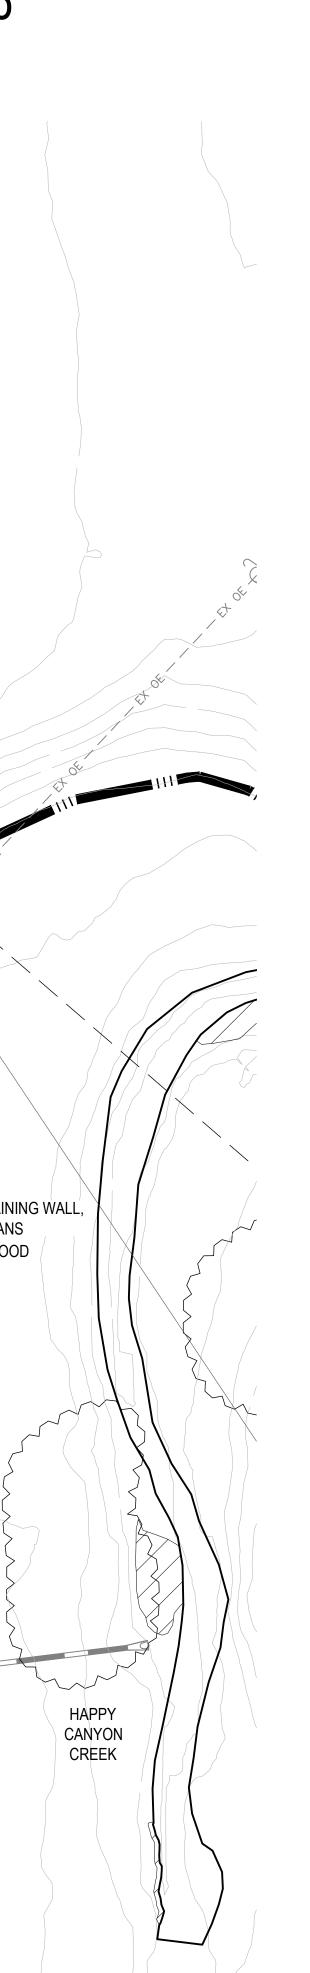

\frown
$\left(\begin{array}{c} \cdot \end{array} \right)$
\checkmark
+++++++++++++++++++++++++++++++++++++++
\bigcirc
(\cdot)
\odot
+++++++++++++++++++++++++++++++++++++++
*
© °
↓ ↓ ↓ ↓ ↓ ↓ ↓ ↓ ↓ ↓ ↓ ↓
· · · · · · · · · · · · · · · · · · ·

LEGEND

DECIDUOUS TREE

EVERGREEN TREE

ORNAMENTAL TREE

DECIDUOUS SHRUB

EVERGREEN SHRUB

PERENNIALS

NATIVE GRASS

NO MOW SOD

LANDSCAPE BED

CRUSHER FINES

SOD

ORNAMENTAL GRASSES

TREE-FORM LARGE SHRUB

-**o---o--**---

_ _ _ _ _



MULCH PROPERTY LINE SPLIT-RAIL FENCES STRING LIGHTS, RE: SHEET 09 SPADE CUT EDGER PROPOSED CONTOURS EXISTING CONTOURS SITE WALL, RE: CIVIL BIKE RACK, RE: SHEET 09 BIKE REPAIR STATION, SHEET 09 FLAGSTONE STEPPERS BOULDERS PLANTER POTS, RE: SHEET 09 LIGHT POLE, RE: LIGHTING

ENHANCED CONCRETE FINISH


FALL TALES RANCH	SITE IMPROVEMENT PLAN	ONE TREE, COLORADO	CITY OF LONE TREE
\vdash	l S	LON	CIT

OWNER:


TALL TALES RANCH SUSAN MOONEY 6311 SOUTH GRANT DRIVE CENTENNIAL, CO 80121 303.806.9140

NOT FOR CONSTRUCTION

DATE: (SIP 01) 01/10/2020 (SIP 02) 04/05/2020

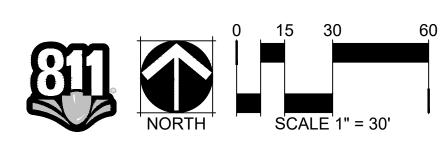

SHEET TITLE: HARDSCAPE PLAN

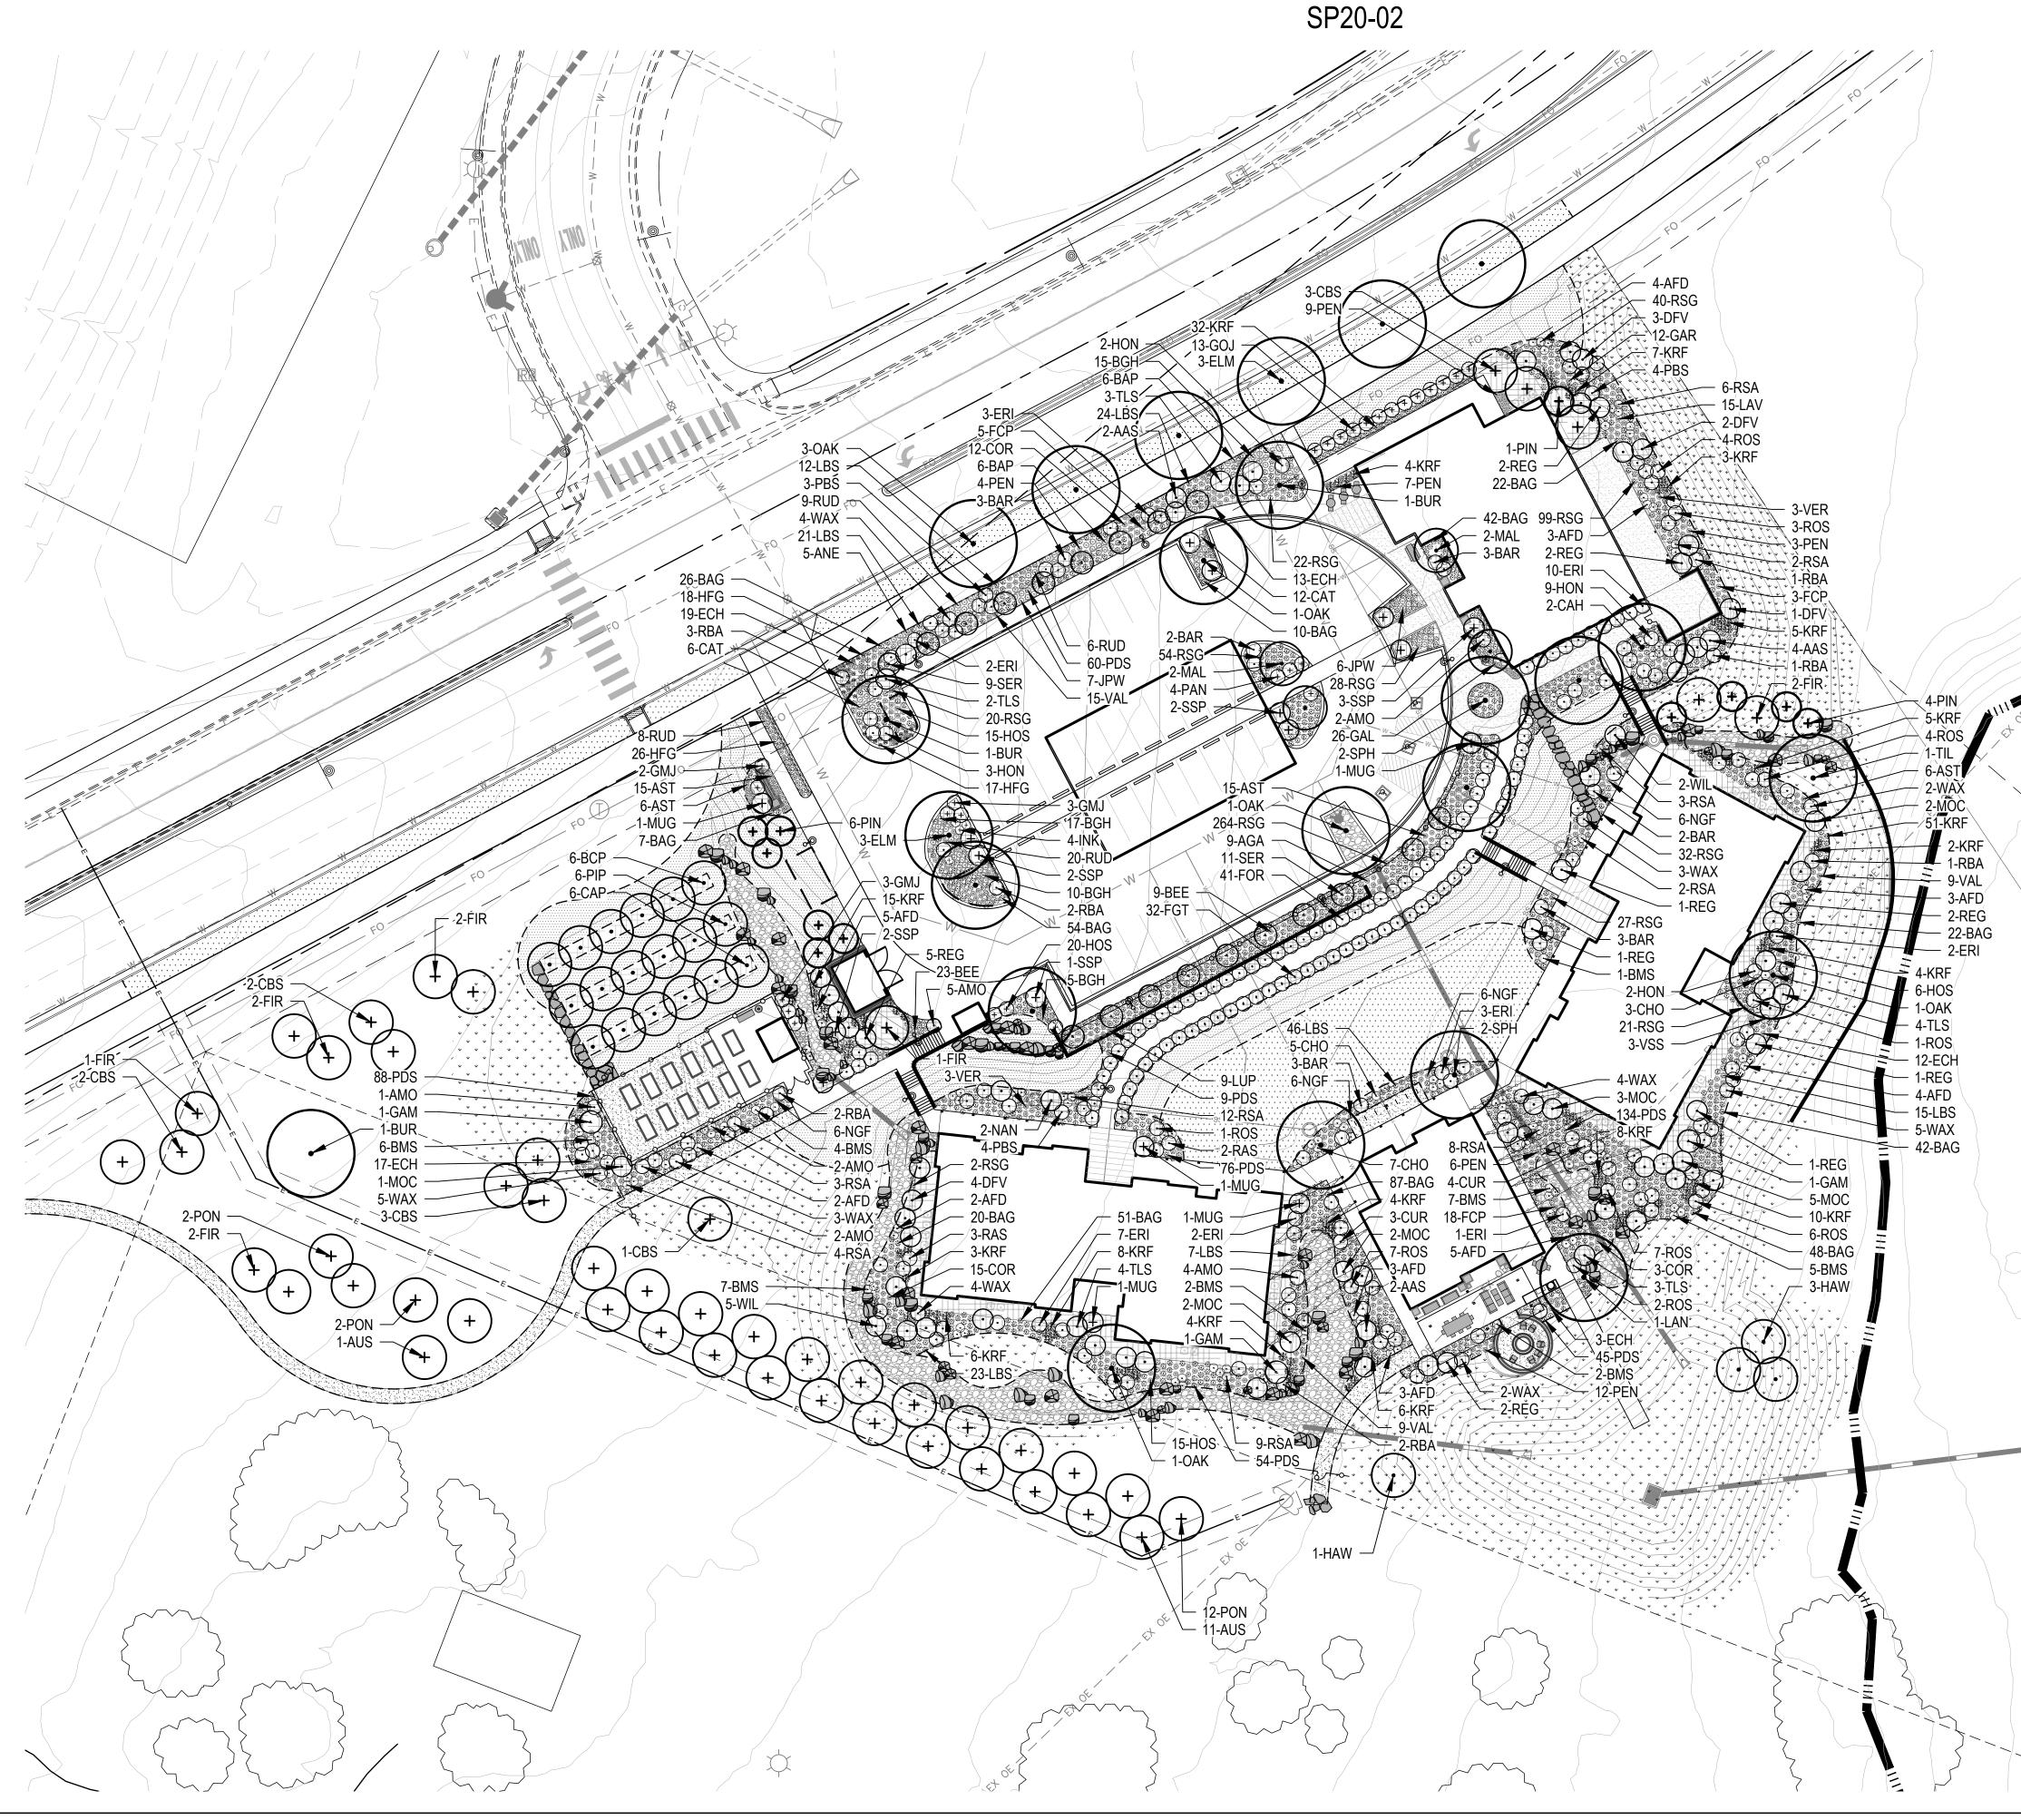

TALL TALES RANCH



1101 Bannock Street Denver, Colorado 80204 P 303.892.1166 www.norris-design.com



$\left(\cdot \right)$
+++++++++++++++++++++++++++++++++++++++
\bigcirc
\bigcirc
(\cdot)
\bigcirc
$\bigcirc \bigcirc$
(+)
(+) (+) (+)
**
© °
+ + + + + + + + + + + + +
· · · · · · · · · · · · · · · · · · ·

LEGEND

DECIDUOUS TREE

EVERGREEN TREE

ORNAMENTAL TREE

DECIDUOUS SHRUB

EVERGREEN SHRUB

PERENNIALS

NATIVE GRASS

NO MOW SOD

LANDSCAPE BED


CRUSHER FINES

SOD

ORNAMENTAL GRASSES

TREE-FORM LARGE SHRUB

_ _ _ _ _

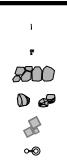

MULCH PROPERTY LINE SPLIT-RAIL FENCES STRING LIGHTS, RE: SHEET 09 SPADE CUT EDGER PROPOSED CONTOURS **EXISTING CONTOURS** SITE WALL, RE: CIVIL BIKE RACK, RE: SHEET 09 BIKE REPAIR STATION, SHEET 09 FLAGSTONE STEPPERS BOULDERS PLANTER POTS, RE: SHEET 09 LIGHT POLE, RE: LIGHTING

ENHANCED CONCRETE FINISH


U T O Ω

OWNER:

TALL TALES RANCH SUSAN MOONEY 6311 SOUTH GRANT DRIVE CENTENNIAL, CO 80121 303.806.9140

NOT FOR CONSTRUCTION

DATE: <u>(SIP 01) 01/10/2020</u> (SIP 02) 04/05/2020

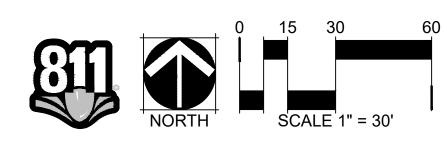

SHEET TITLE: LANDSCAPE PLAN

SITE AMENITY SCHEDULE



DESCRIPTION: BENCH MANUFACTURER: COUNTRY CASUAL MODEL: CLIFTON 5 FT. COLOR / FINISH: TEAK, NO FINISH

> NOTES: SURFACE MOUNT PER MANUFACTURER'S

> > SPECIFICATIONS



DESCRIPTION: LITTER RECEPTACLE MANUFACTURER: COUNTRY CASUAL MODEL: URBANA TRIPLE-STREAM RECYCLING LID RECEPTACLE COLOR / FINISH: TEAK, NO FINISH

> NOTES: SURFACE MOUNT PER MANUFACTURER'S SPECIFICATIONS



DESCRIPTION: BIKE RACK

MANUFACTURER: ANOVA

MODEL: METRO 3-BIKE / 1-LOOP RACK

COLOR / FINISH: TEXTURED **BRONZE POWDERCOAT**

NOTES: IN-GROUND MOUNT PER MANUFACTURER'S SPECIFICATIONS



DESCRIPTION: LOUNGE MANUFACTURER: COUNTRY CASUAL

MODEL: APEX SOFA 5070

COLOR / FINISH: TEAK, NO FINISH

NOTES: SURFACE MOUNT PER MANUFACTURER'S SPECIFICATIONS

BOULDER CROPPING



DESCRIPTION: COFFEE TABLE MANUFACTURER: COUNTRY CASUAL

> MODEL: BERWICK 48 IN. COFFEE TABLE

COLOR / FINISH: TEAK, NO FINISH

NOTES: SURFACE MOUNT PER MANUFACTURER'S SPECIFICATIONS



DESCRIPTION: BISTRO TABLE MANUFACTURER: COUNTRY CASUAL

> MODEL: FOXHALL ROUND TABLE 8628

COLOR / FINISH: TEAK, NO FINISH


NOTES: SURFACE MOUNT PER MANUFACTURER'S SPECIFICATIONS

1 MULCH TO BOULDERS, NO GAPS

(2) BUFF SANDSTONE BOULDER, NATURALLY SET BOULDER SO THAT A MINIMUM 1/4 OF BOULDER IS BELOW FINISH GRADE

(3) 3" MINIMUM ROAD BASE COMPACTED TO 95% OF STANDARD PROXY DENSITY

(4) UNDISTURBED GRADE

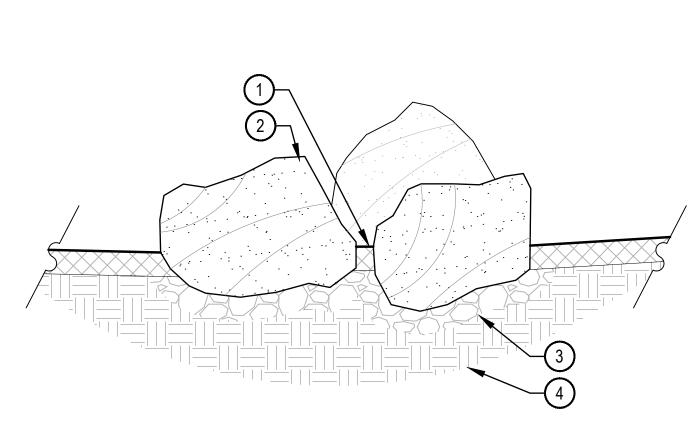

TALL TALES RANCH





DESCRIPTION: PICNIC TABLE

MANUFACTURER: COUNTRY CASUAL

MODEL: MELBOURNE 6 FT. 6 IN. PICNIC SET

COLOR / FINISH: TEAK, NO FINISH

NOTES: WITH TWO BENCHES, SURFACE MOUNT PER MANUFACTURER'S SPECIFICATIONS



- DESCRIPTION: PLANTER POTS MANUFACTURER: KORNEGAY DESIGN
 - MODEL: SQUARE SERIES: SS21, SS27, AND SS30

COLOR / FINISH: SANDBLAST FINISH

NOTES: SURFACE MOUNT PER MANUFACTURER'S SPECIFICATIONS



5 DESCRIPTION: FOUR SEAT TABLE

MANUFACTURER: COUNTRY CASUAL

MODEL: MELBOURNE 3 FT. 4 IN. SQUARE TABLE

COLOR / FINISH: TEAK, NO FINISH

NOTES: WITH FOUR CHAIRS, SURFACE MOUNT PER MANUFACTURER'S SPECIFICATIONS



DESCRIPTION: BIKE REPAIR MANUFACTURER: DERO

MODEL: FIXIT

COLOR / FINISH: GALVANIZED

NOTES: WITH PUMP AND WHEEL CHOCK, SURFACE MOUNT PER MANUFACTURER'S SPECIFICATIONS



C DESCRIPTION: ADIRONDACK CHAIR MANUFACTURER: COUNTRY CASUAL MODEL: ADIRONDACK CHAIR 7205 COLOR / FINISH: TEAK, NO FINISH NOTES: NO MOUNT





DESCRIPTION: GAS GRILL


MANUFACTURER: BLAZE


MODEL: BLZ-3 PRO-NG **PROFESSIONAL 34-INCH 3-BURNER BUILT-IN NATURAL** GAS GRILL WITH REAR INFRARED **BURNER BLZ-3 PRO-NG**

COLOR / FINISH: STAINLESS STEEL


NOTES: INSTALL PER MANUFACTURER'S SPECIFICATIONS

- (1) BUFF SANDSTONE BOULDERS RELOCATED FROM ON-SITE OR FROM NEARBY QUARRY. CONTRACTOR SHALL SUBMIT SMALL SAMPLE OR PHOTOS FOR APPROVAL. BOULDERS SHOULD BE NO SMALLER THAN 18"x18"x18"
- (2) CRUSHER FINES SETTING BED TO STABILIZE BOULDER
- (3) UNDISTURBED SOIL
- 4 BURY ENOUGH OF BASE COURSE FOR STABILITY
- 5 EXCAVATED AND BACKFILLED SOIL

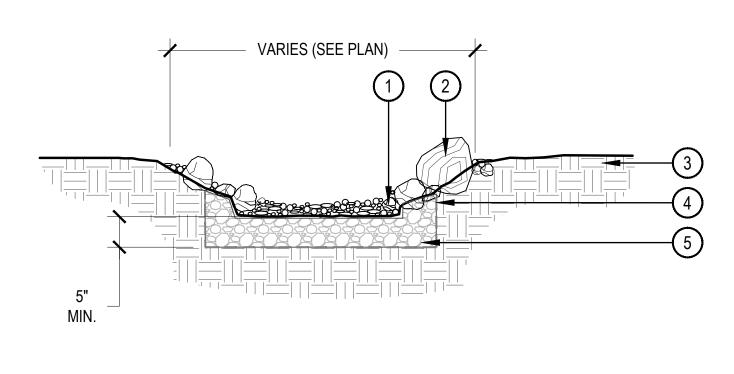

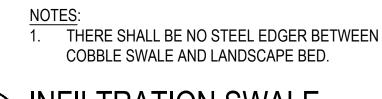



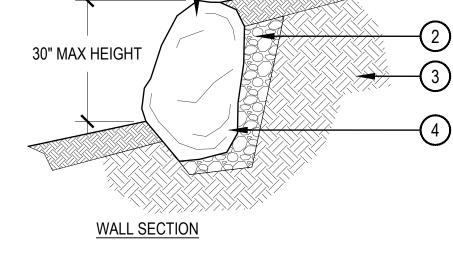

(1)

(5)

NOTE: 1. BOULDER WALL MUST NOT EXCEED 30" IN HEIGHT

BOULDER RETAINING WALL

)))))**NORRIS DESIGN** lanning | Landscape Architecture | Branding

1101 Bannock Street Denver, Colorado 80204 P 303.892.1166 www.norris-design.com

T DESCRIPTION: PORCH SWING MANUFACTURER: COUNTRY CASUAL

MODEL: CARLISLE 5 FT. SWING

COLOR / FINISH: TEAK, NO FINISH

NOTES: MOUNT PER MANUFACTURER'S SPECIFICATIONS

♦ DESCRIPTION: COMMUNITY TABLE

MANUFACTURER: COUNTRY CASUAL

MODEL: SUMMIT 10 FT. INFINITY TABLE

COLOR / FINISH: TEAK, NO FINISH

NOTES: MOUNT PER MANUFACTURER'S SPECIFICATIONS



(15) DESCRIPTION: CERAMIC GRILL

MANUFACTURER: COYOTE

MODEL: ASADO CERAMIC GRILL C1CHCS

COLOR / FINISH: BLACK CERAMIC

NOTES: INSTALL PER MANUFACTURER'S SPECIFICATIONS

Ζ 1 Ŷ

OWNER:

TALL TALES RANCH SUSAN MOONEY 6311 SOUTH GRANT DRIVE CENTENNIAL, CO 80121 303.806.9140

NOT FOR CONSTRUCTION

- (1) STREAM BOTTOM: CONSISTING OF 6" DEPTH OF (25%) 3/4" RIVER ROCK AND (75%) 4"-6" COBBLE.
- (2) LANDSCAPE BOULDER ALONG STREAM EDGE, REFER TO LANDSCAPE PLAN FOR LOCATIONS
- (3) UNCOMPACTED SUBGRADE
- (4) FILTER FABRIC
- 5 1-3" CLEAN CRUSHED GRAVEL UNIFORMLY GRADED


DATE: <u>(SIP 01) 01/10/2020</u> <u>(SIP 02) 04/05/2020</u>


> SHEET TITLE: LANDSCAPE DETAILS

COBBLE SWALE AND LANDSCAPE BED.

INFILTRATION SWALE

SCALE: 3/4" = 1'-0"

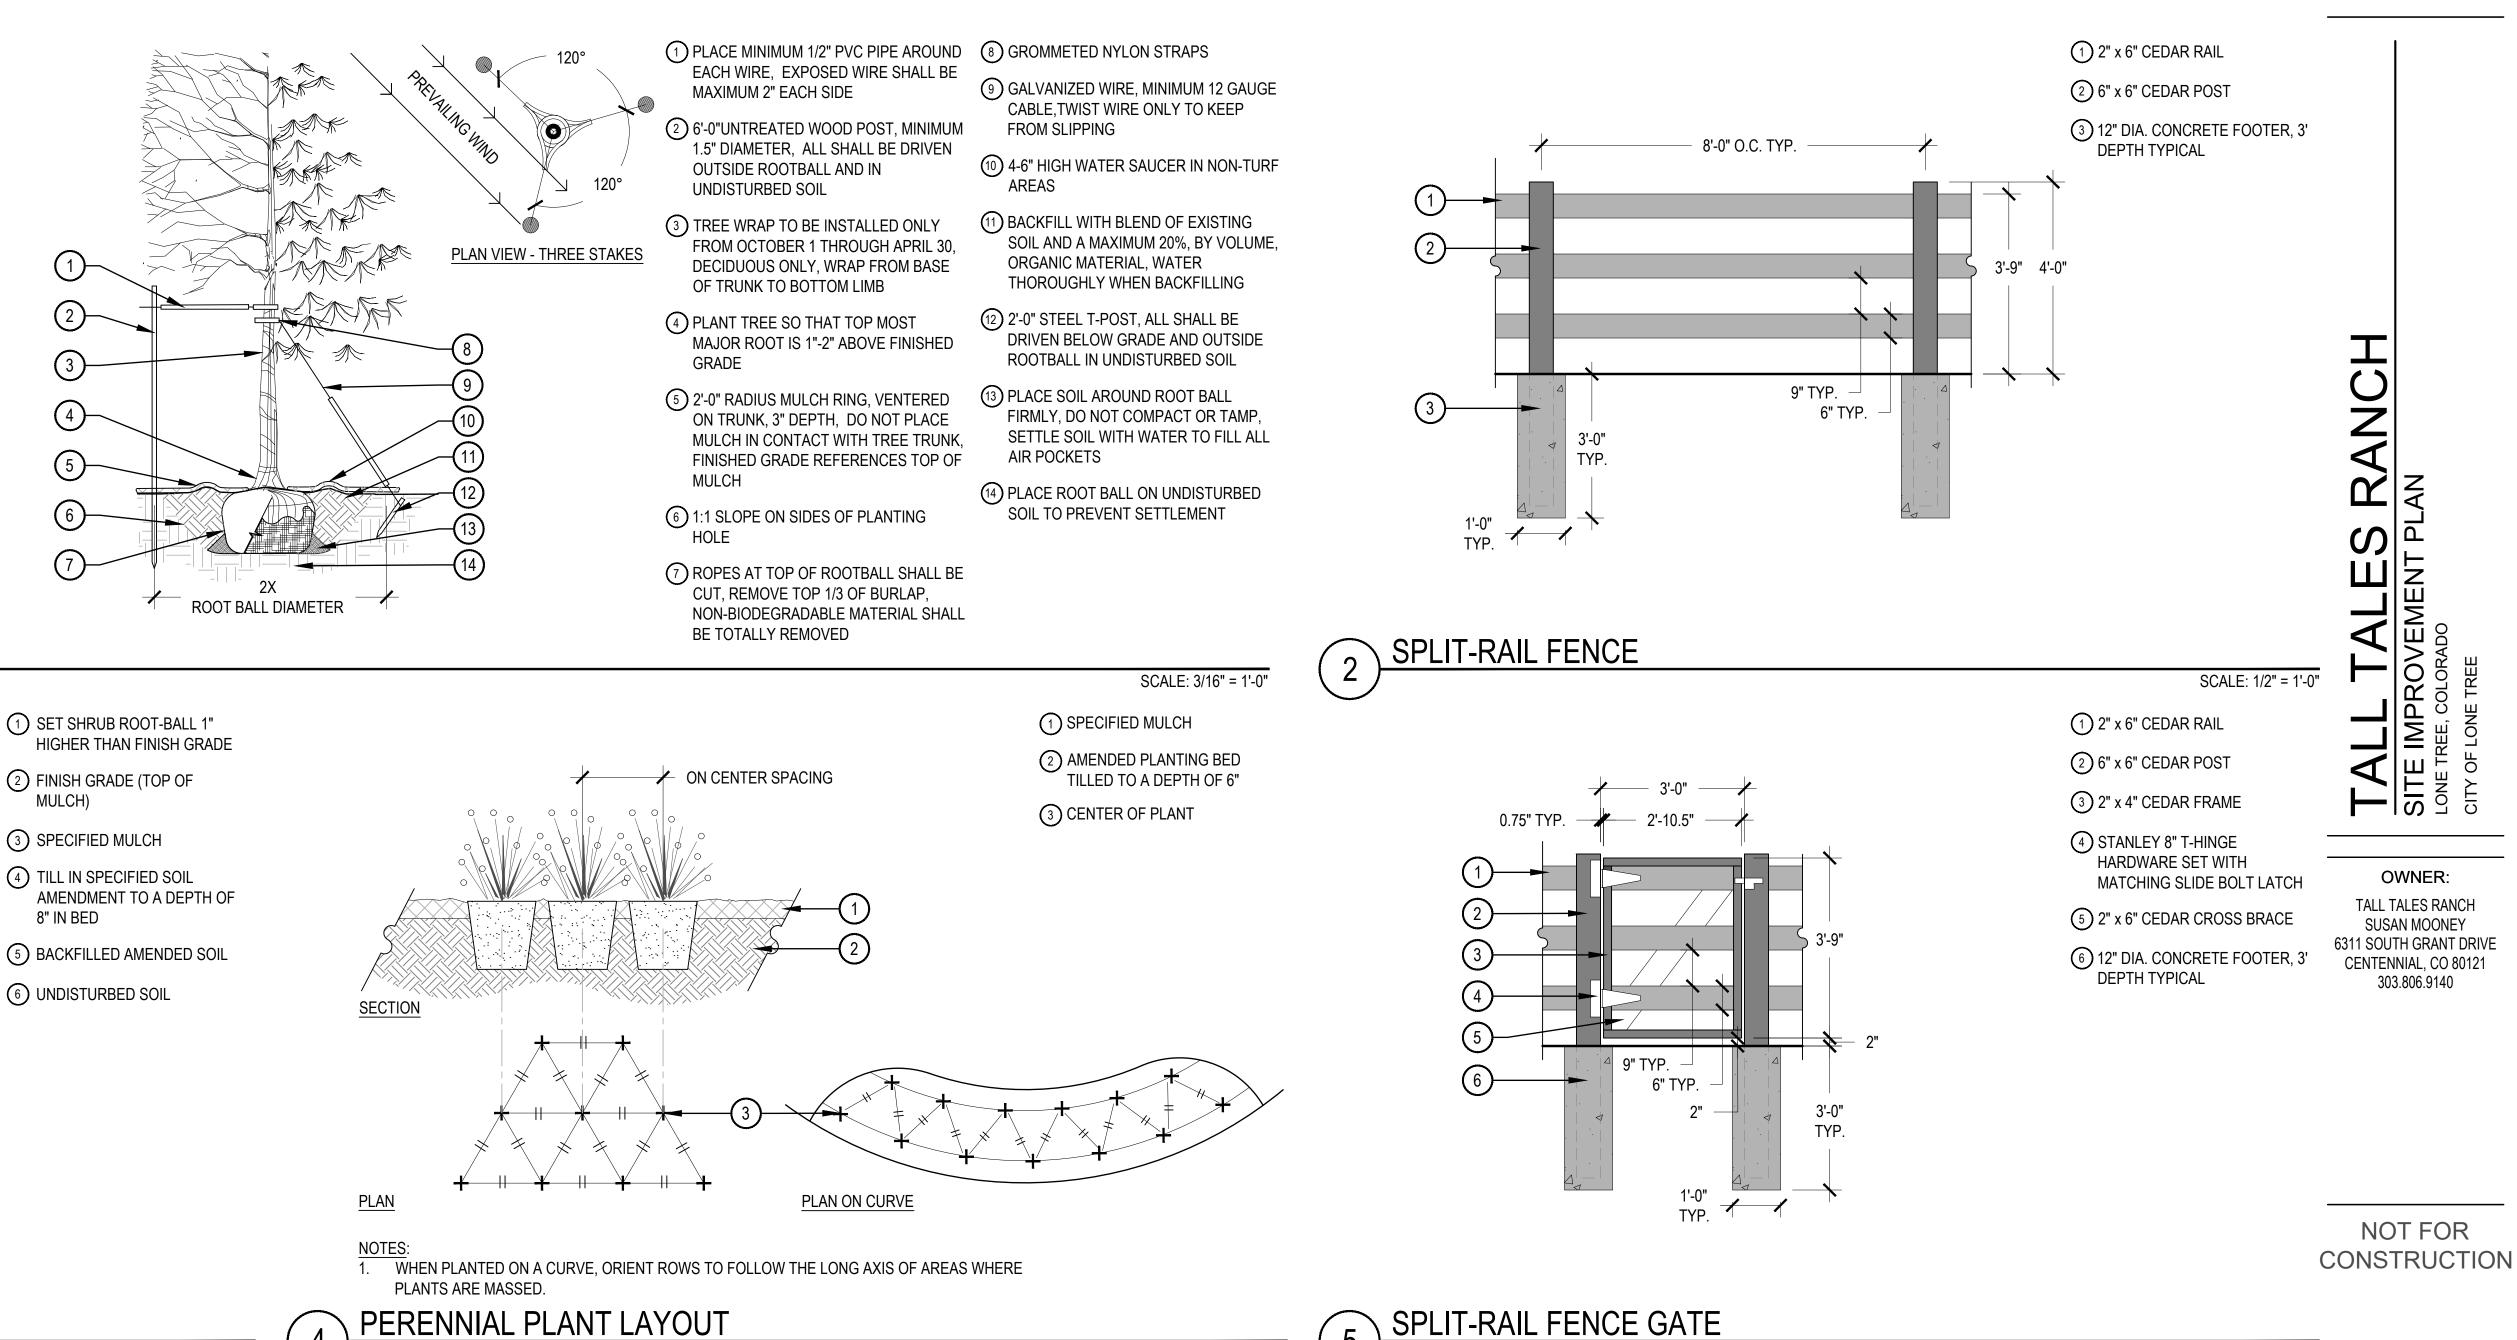

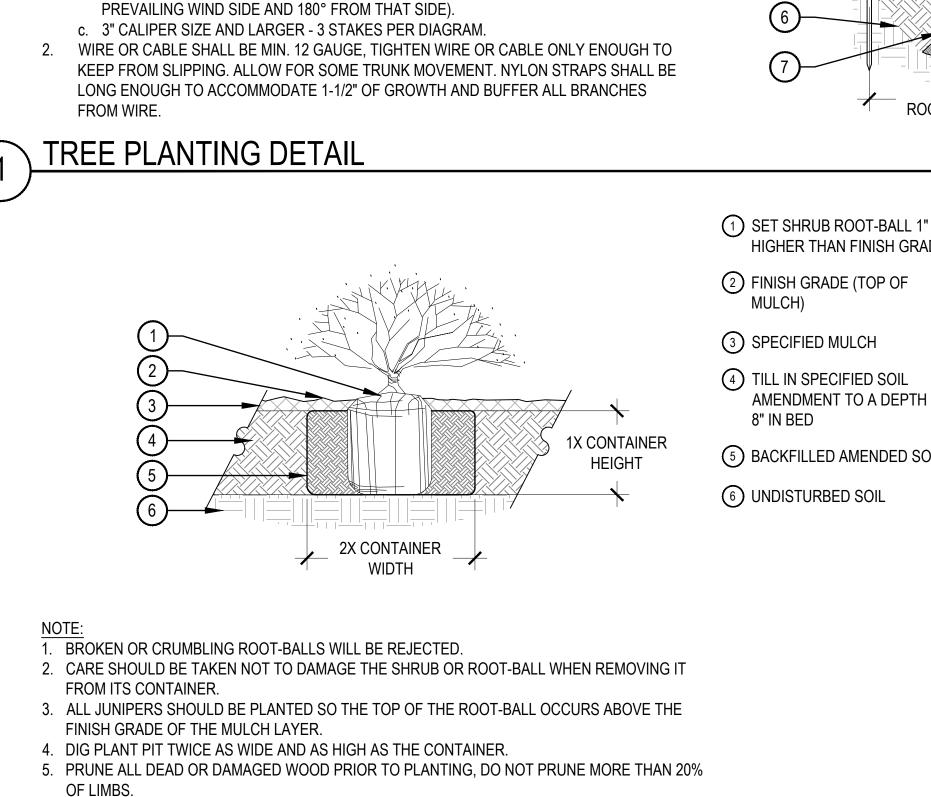



PRUNING NOTES:

STAKING NOTES:

SEASON

SIDE).

ALL PRUNING SHALL COMPLY WITH ANSI A300 STANDARDS.

BUDS OF BRANCHES THAT EXTEND TO THE EDGE OF THE CROWN.

DO NOT HEAVILY PRUNE THE TREE AT PLANTING. PRUNE ONLY CROSSOVER LIMBS,

LATERAL BRANCHES MAY BE PRUNED. HOWEVER, DO NOT REMOVE THE TERMINAL

STAKE TREES PER FOLLOWING SCHEDULE, THEN REMOVE AT END OF FIRST GROWING

a. 1-1/2" CALIPER SIZE - MIN. 1 STAKE ON SIDE OF PREVAILING WIND (GENERALLY N.W.

b. 1-1/2" - 3" CALIPER SIZE - MIN. 2 STAKES - ONE ON N.W. SIDE, ONE ON S.W. SIDE (OR

CO-DOMINANT LEADERS AND BROKEN BRANCHES. SOME INTERIOR TWIGS AND

SCALE: 1 1/2" = 1'-0"

MS CHECKED BY DRAWN BY:

4.01 ACRES SP20-02

PERENNIAL PLANT LAYOUT

SCALE: 1" = 1'-0"






1101 Bannock Street Denver, Colorado 80204 P 303.892.1166 www.norris-design.com

SCALE: 1/2" = 1'-0"

DATE: <u>(SIP 01) 01/10/2020</u> (SIP 02) 04/05/2020

> SHEET TITLE: LANDSCAPE DETAILS

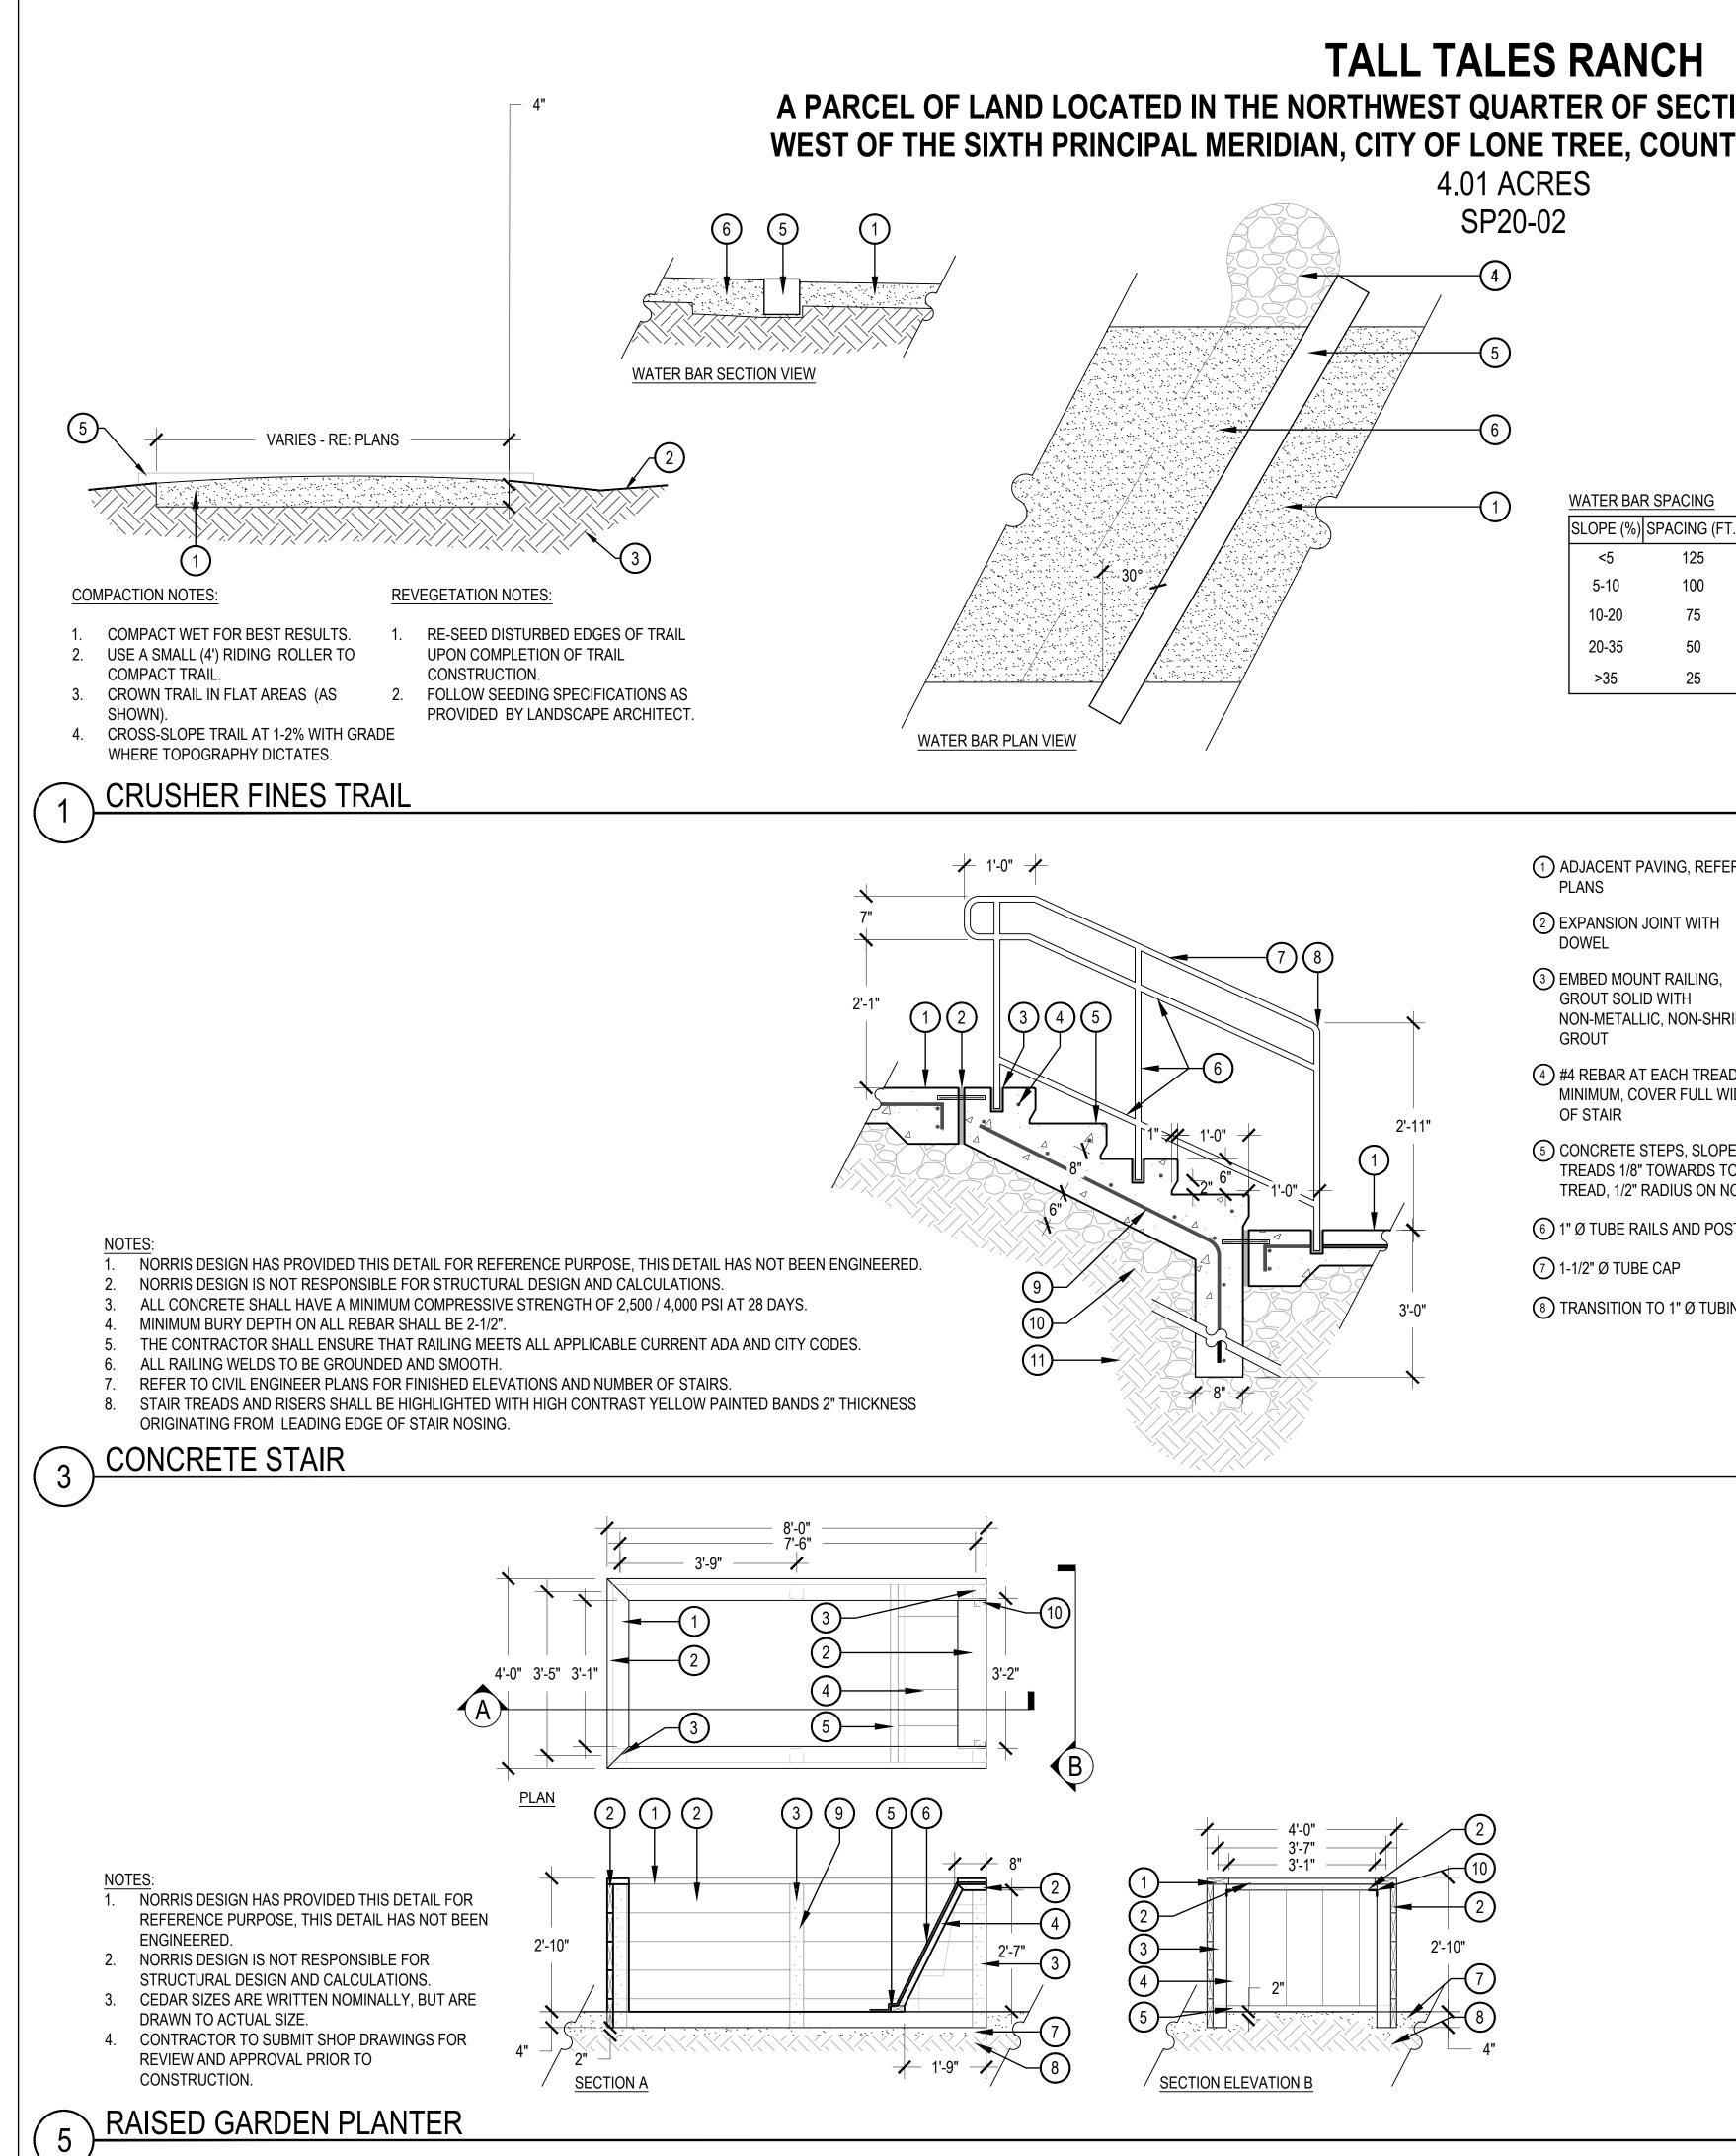

MS CHECKED BY DRAWN BY:

TALL TALES RANCH

A PARCEL OF LAND LOCATED IN THE NORTHWEST QUARTER OF SECTION 23, TOWNSHIP 6 SOUTH, RANGE 67 WEST OF THE SIXTH PRINCIPAL MERIDIAN, CITY OF LONE TREE, COUNTY OF DOUGLAS, STATE OF COLORADO

- ① COMPACTED CRUSHER FINES
- ② SLOPE ADJACENT GRADE AWAY FROM TRAIL, SWALE IF NECESSARY
- (3) COMPACTED SUBGRADE
- (4) COBBLE REINFORCED WATER BAR OUTLET
- 5 6" x 6" PRESSURE TREATED CEDAR WATER BAR, ORIENTED 30° FROM PERPENDICULAR, SEE TABLE FOR SPACING GUIDELINES
- (6) 12" x 6" TRENCH UP ALONG THE UP HILL SIDE OF WATER BAR, BACK FILL WITH CRUSHER FINES



SCALE: 3/4" = 1'-0"

(1) ADJACENT PAVING, REFER TO

125

100


75

50

25

- (3) EMBED MOUNT RAILING, GROUT SOLID WITH NON-METALLIC. NON-SHRINK
- (4) #4 REBAR AT EACH TREAD 2" MINIMUM, COVER FULL WIDTH
- 5 CONCRETE STEPS, SLOPE TREADS 1/8" TOWARDS TOE, 1' TREAD, 1/2" RADIUS ON NOSE
- 6 1" Ø TUBE RAILS AND POST
- (7) 1-1/2" Ø TUBE CAP
- (8) TRANSITION TO 1" Ø TUBING

- (9) #4 REBAR 12" ON CENTER BOTH WAYS
- (10) 6" AGGREGATE BASE
- (1) SUBGRADE COMPACTED TO 95% STANDARD PROXY DENSITY

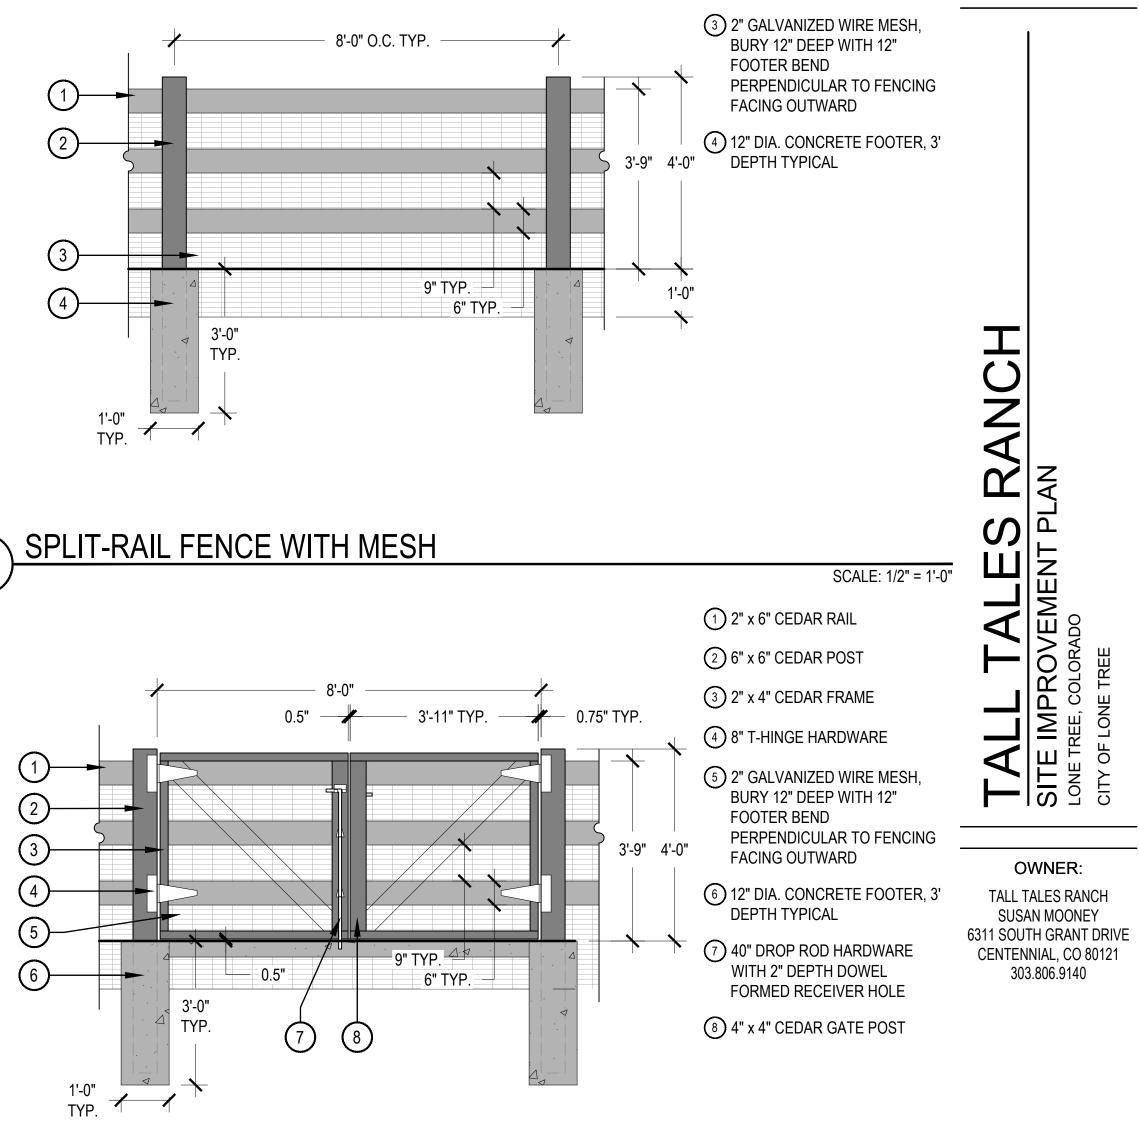

- 4 SCALE: 3/4" = 1'-0"
- 1 2" x 6" CEDAR BOARD
- 2 2" x 8" CEDAR BOARD
- 3 4" x 4" CEDAR POST
- 4 2" x 10" CEDAR BOARD
- 5 2" x 4" CEDAR BOARD
- (6) WATERPROOF MEMBRANE
- 7 CRUSHER FINES
- 8 SUBGRADE COMPACTED TO 95% STANDARD PROXY DENSITY
- (9) 4" GALVANIZED WOOD SCREWS
- (10) 1.5" x 2" x 2.75" GALVANIZED STEEL ANGLE

SPLIT-RAIL FENCE GATE WITH MESH

NOT FOR SCALE: 1/2" = 1'-0"CONSTRUCTION

> DATE: <u>(SIP 01) 01/10/2020</u> (SIP 02) 04/05/2020

)))))

1101 Bannock Street Denver, Colorado 80204

www.norris-design.com

P 303.892.1166


NORRIS DESIGN Planning | Landscape Architecture | Branding

(1) 2" x 6" CEDAR RAIL

(2) 6" x 6" CEDAR POST

SHEET TITLE: LANDSCAPE DETAILS



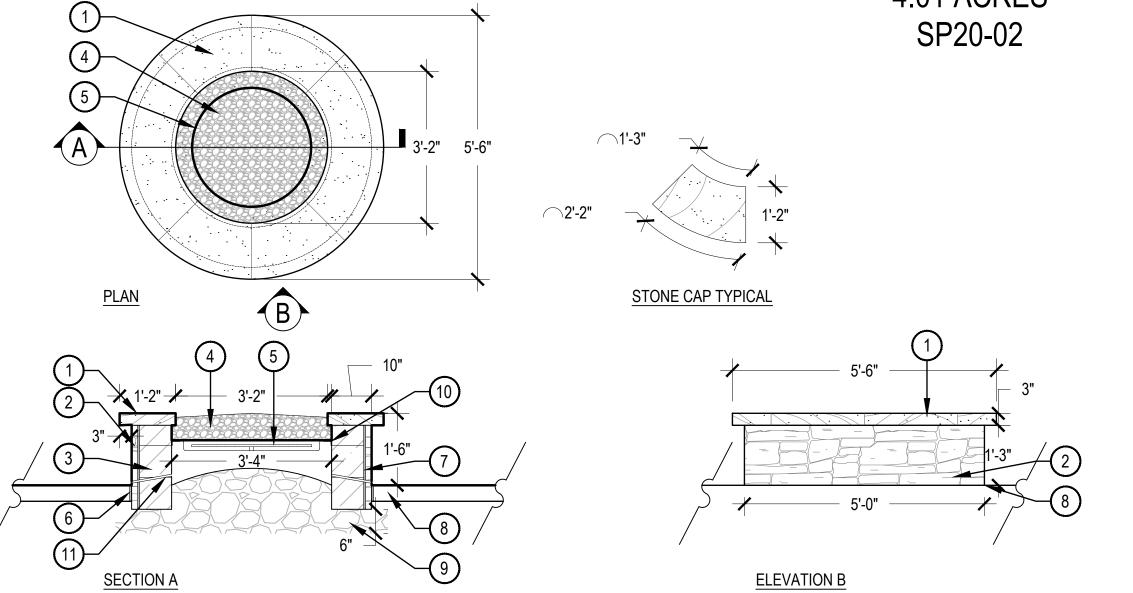

NOTES

FIRE PIT

- SHOP DRAWINGS ARE TO BE SUBMITTED TO AND APPROVED BY THE LANDSCAPE ARCHITECT
- 2. WALLS TO INCLUDE WEEPHOLES WHERE NECESSARY TO INSURE DRAINAGE AND ADEQUATE AIRFLOW FOR FIRE FEATURE.
- 3. PROVIDE EMERGENCY SHUT OFF SWITCH AND AUTOMATIC TIMER. SHUT OFF SWITCH AND TIMER TO BE ADA ACCESSIBLE AND LOCATED MIN. 15" ABOVE
- GRADE. 4. EMERGENCY SHUT OFF AND AUTOMATIC TIMER SHALL BE LOCATED ON ADJACENT POST, SEE PLAN.
- 5. CONTRACTOR TO SUBMIT SHOP DRAWINGS FOR REVIEW AND APPROVAL PRIOR TO CONSTRUCTION.

MS CHECKED BY DRAWN BY:



TALL TALES RANCH A PARCEL OF LAND LOCATED IN THE NORTHWEST QUARTER OF SECTION 23, TOWNSHIP 6 SOUTH, RANGE 67 WEST OF THE SIXTH PRINCIPAL MERIDIAN, CITY OF LONE TREE, COUNTY OF DOUGLAS, STATE OF COLORADO





1 BUFF SANDSTONE CAP


- 2 STONE VENEER, EXTEND 6" BELOW FINISHED GRADE
- 3 STANDARD GRAY 8" x 8" x 16" CMU BLOCK, EXTEND 6" BELOW FINISHED GRADE
- 4 DECORATIVE STONE
- 5 37" FIRE PAN AND 30" FIRE RING, STAINLESS STEEL
- 6 EXPANSION JOINT
- $\overline{(7)}$ STONE VENEER MORTAR
- 8 ADJACENT FLATWORK
- (9) COMPACTED AGGREGATE


SCALE: 1/2" = 1'-0"

- (10) MORTARED COLLAR
- (1) WEEP HOLES

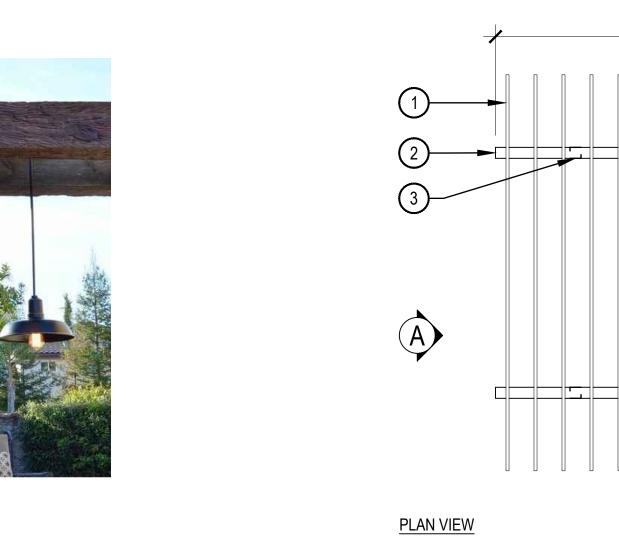

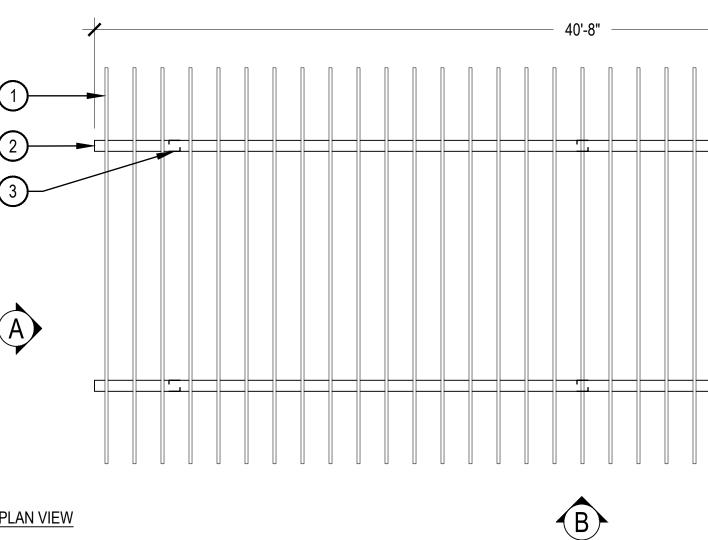

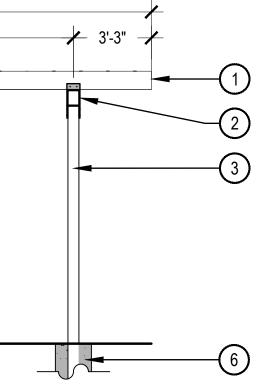

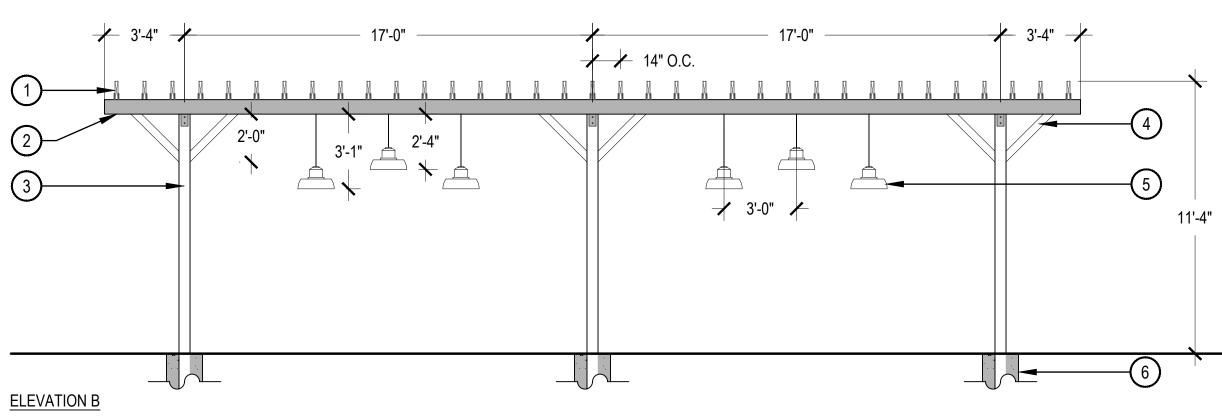



1101 Bannock Street Denver, Colorado 80204 P 303.892.1166 www.norris-design.com



OWNER:

CHARCOAL GRAY COLOR

HEARTWOOD CEDAR POSTS

(4) WOOD BRACKET, TO MATCH

5 BRUSHED ALUMINUM LIGHT FIXTURE, PLACEMENT DEPENDENT ON OUTDOOR

6 STRUCTURAL FOOTING, REFER

TO SHOP DRAWINGS

(3) 6" x 6" ROUGH SAWN

ARCHITECTURE

FURNITURE

TALL TALES RANCH SUSAN MOONEY 6311 SOUTH GRANT DRIVE CENTENNIAL, CO 80121 303.806.9140

NOT FOR CONSTRUCTION


DATE: <u>(SIP 01) 01/10/2020</u> (SIP 02) 04/05/2020

> SHEET TITLE: LANDSCAPE DETAILS

16'-6"

11 of 27

SCALE: 1/4" = 1'-0"

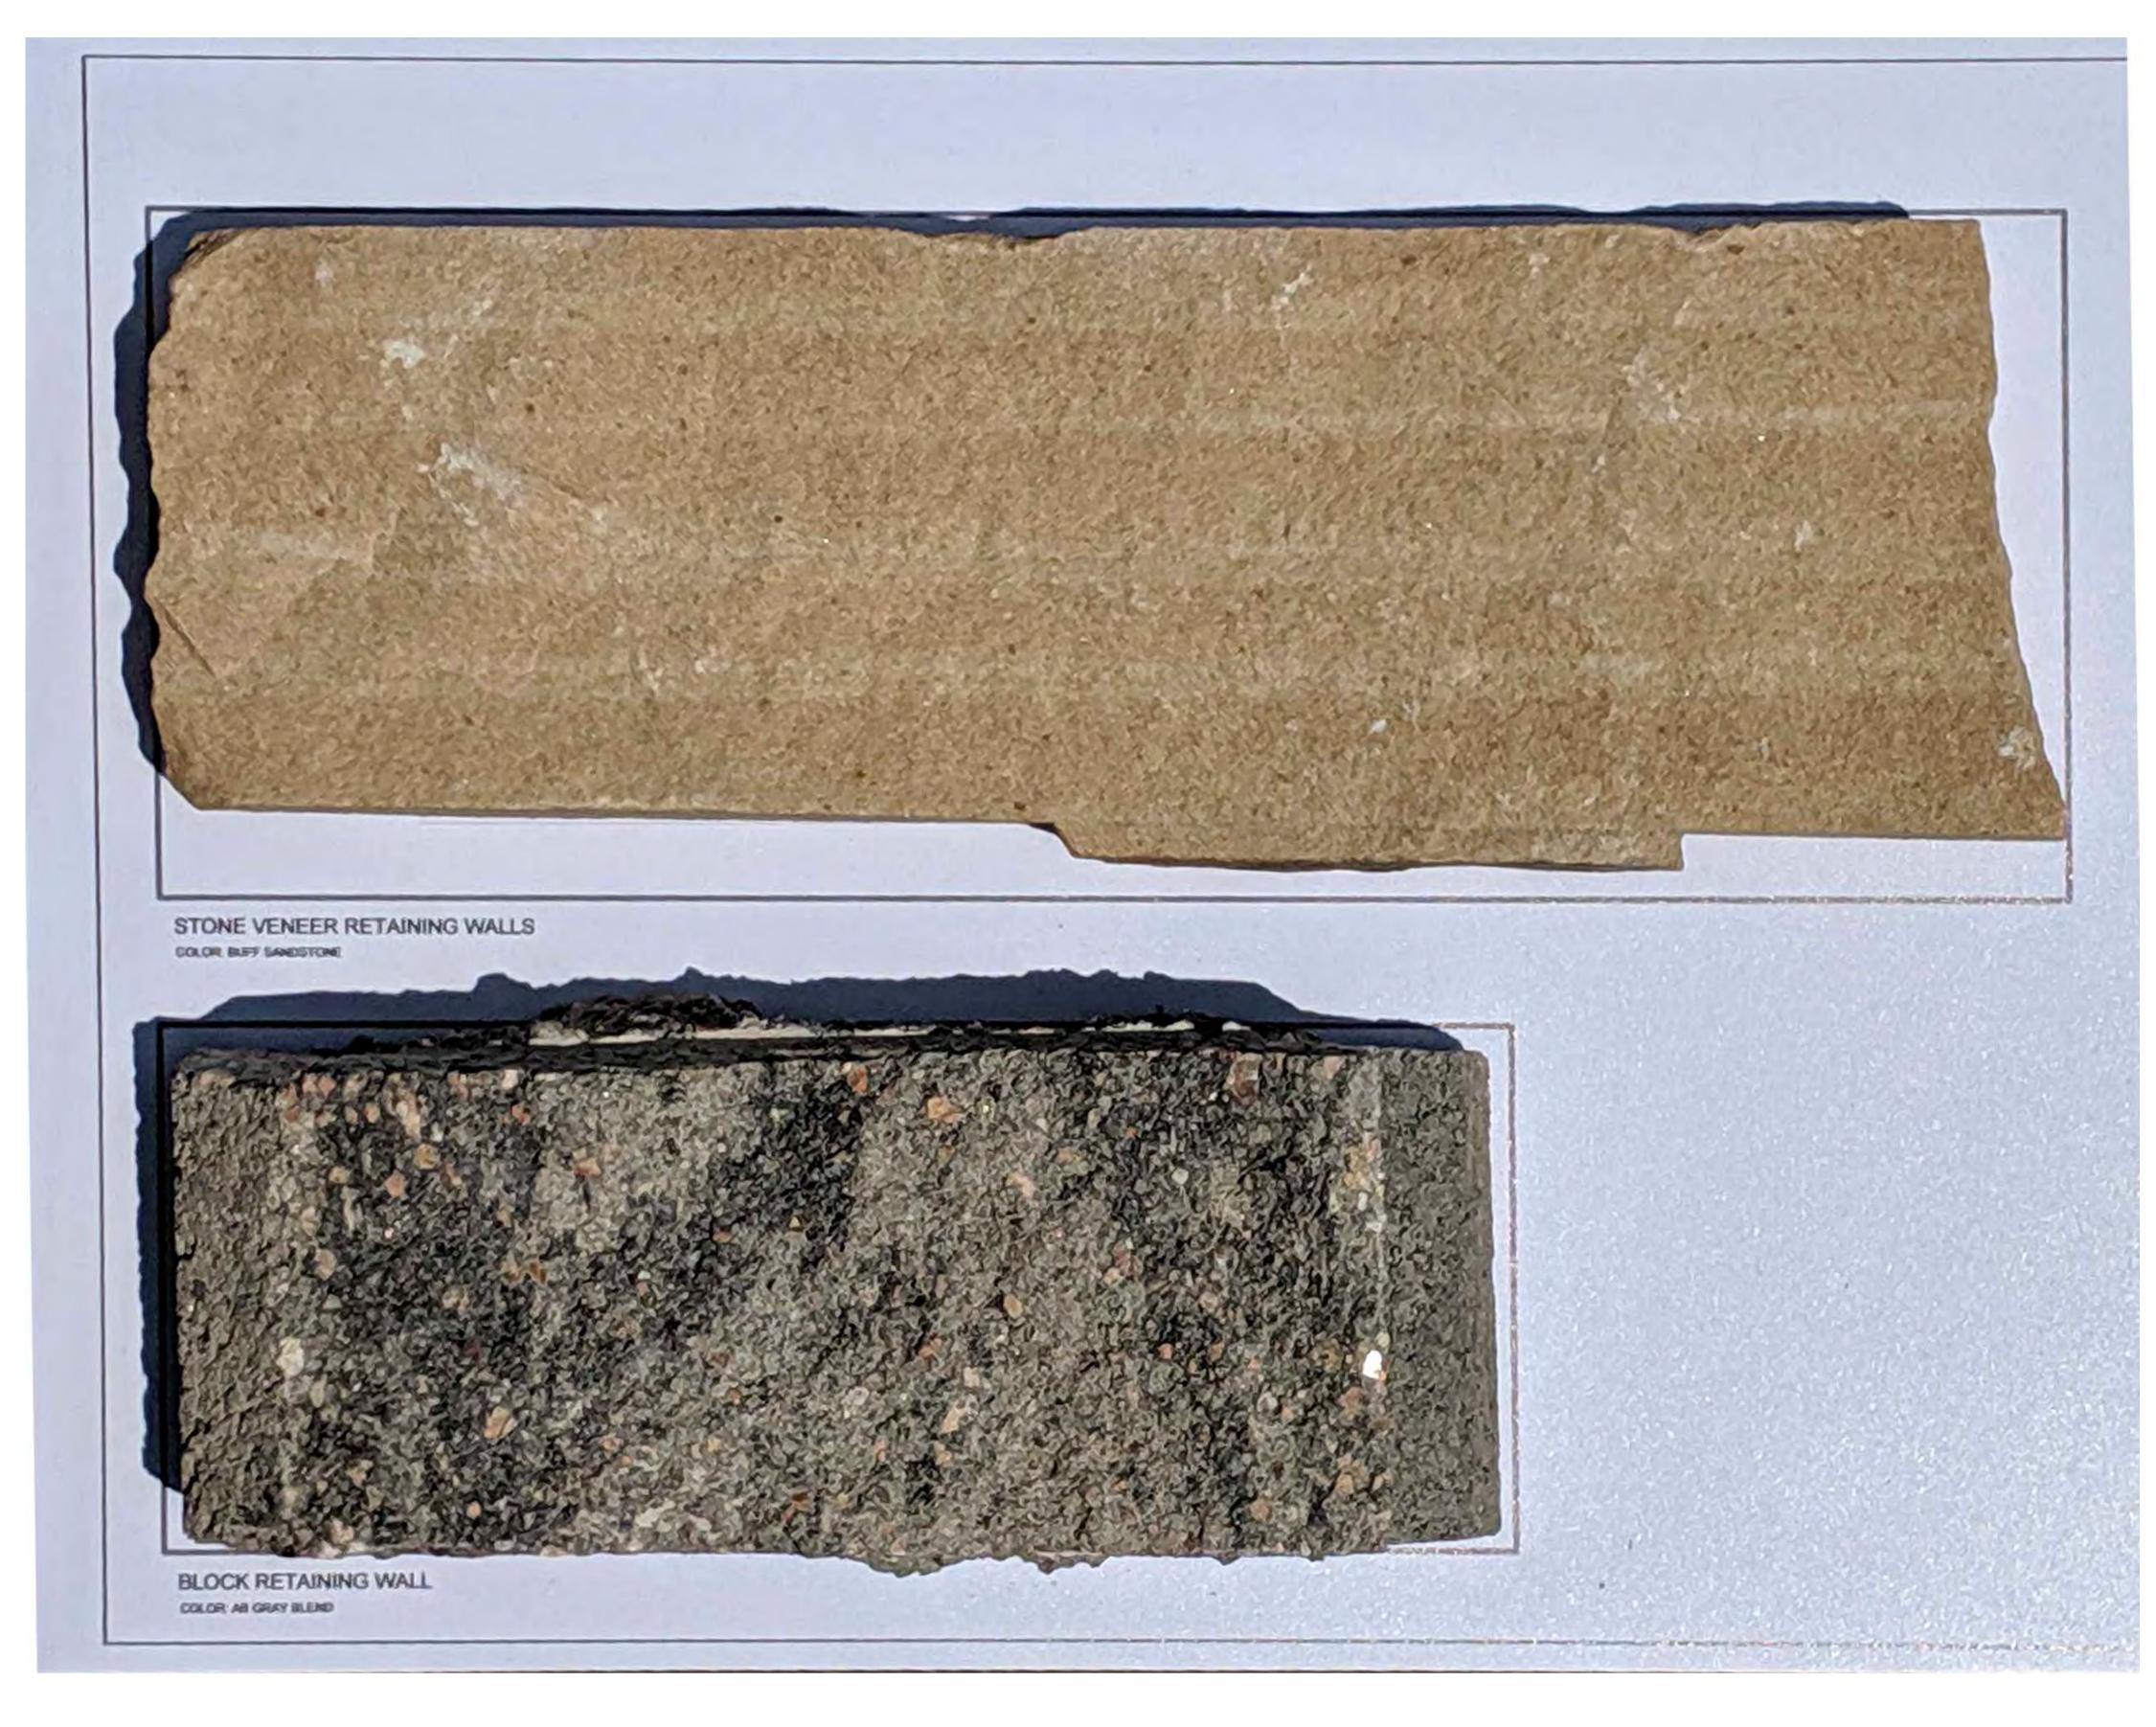

NW WW CHECKED BY: DRAWN BY:

TALL TALES RANCH

A PARCEL OF LAND LOCATED IN THE NORTHWEST QUARTER OF SECTION 23, TOWNSHIP 6 SOUTH, RANGE 67 WEST OF THE SIXTH PRINCIPAL MERIDIAN, CITY OF LONE TREE, COUNTY OF DOUGLAS, STATE OF COLORADO 4.01 ACRES

SP20-02





1101 Bannock Street Denver, Colorado 80204 P 303.892.1166 www.norris-design.com




OWNER:

TALL TALES RANCH SUSAN MOONEY 6311 SOUTH GRANT DRIVE CENTENNIAL, CO 80121 303.806.9140

NOT FOR CONSTRUCTION

DATE: <u>(SIP 01) 01/10/2020</u> <u>(SIP 02) 04/05/2020</u>

> SHEET TITLE: LANDSCAPE MATERIALS

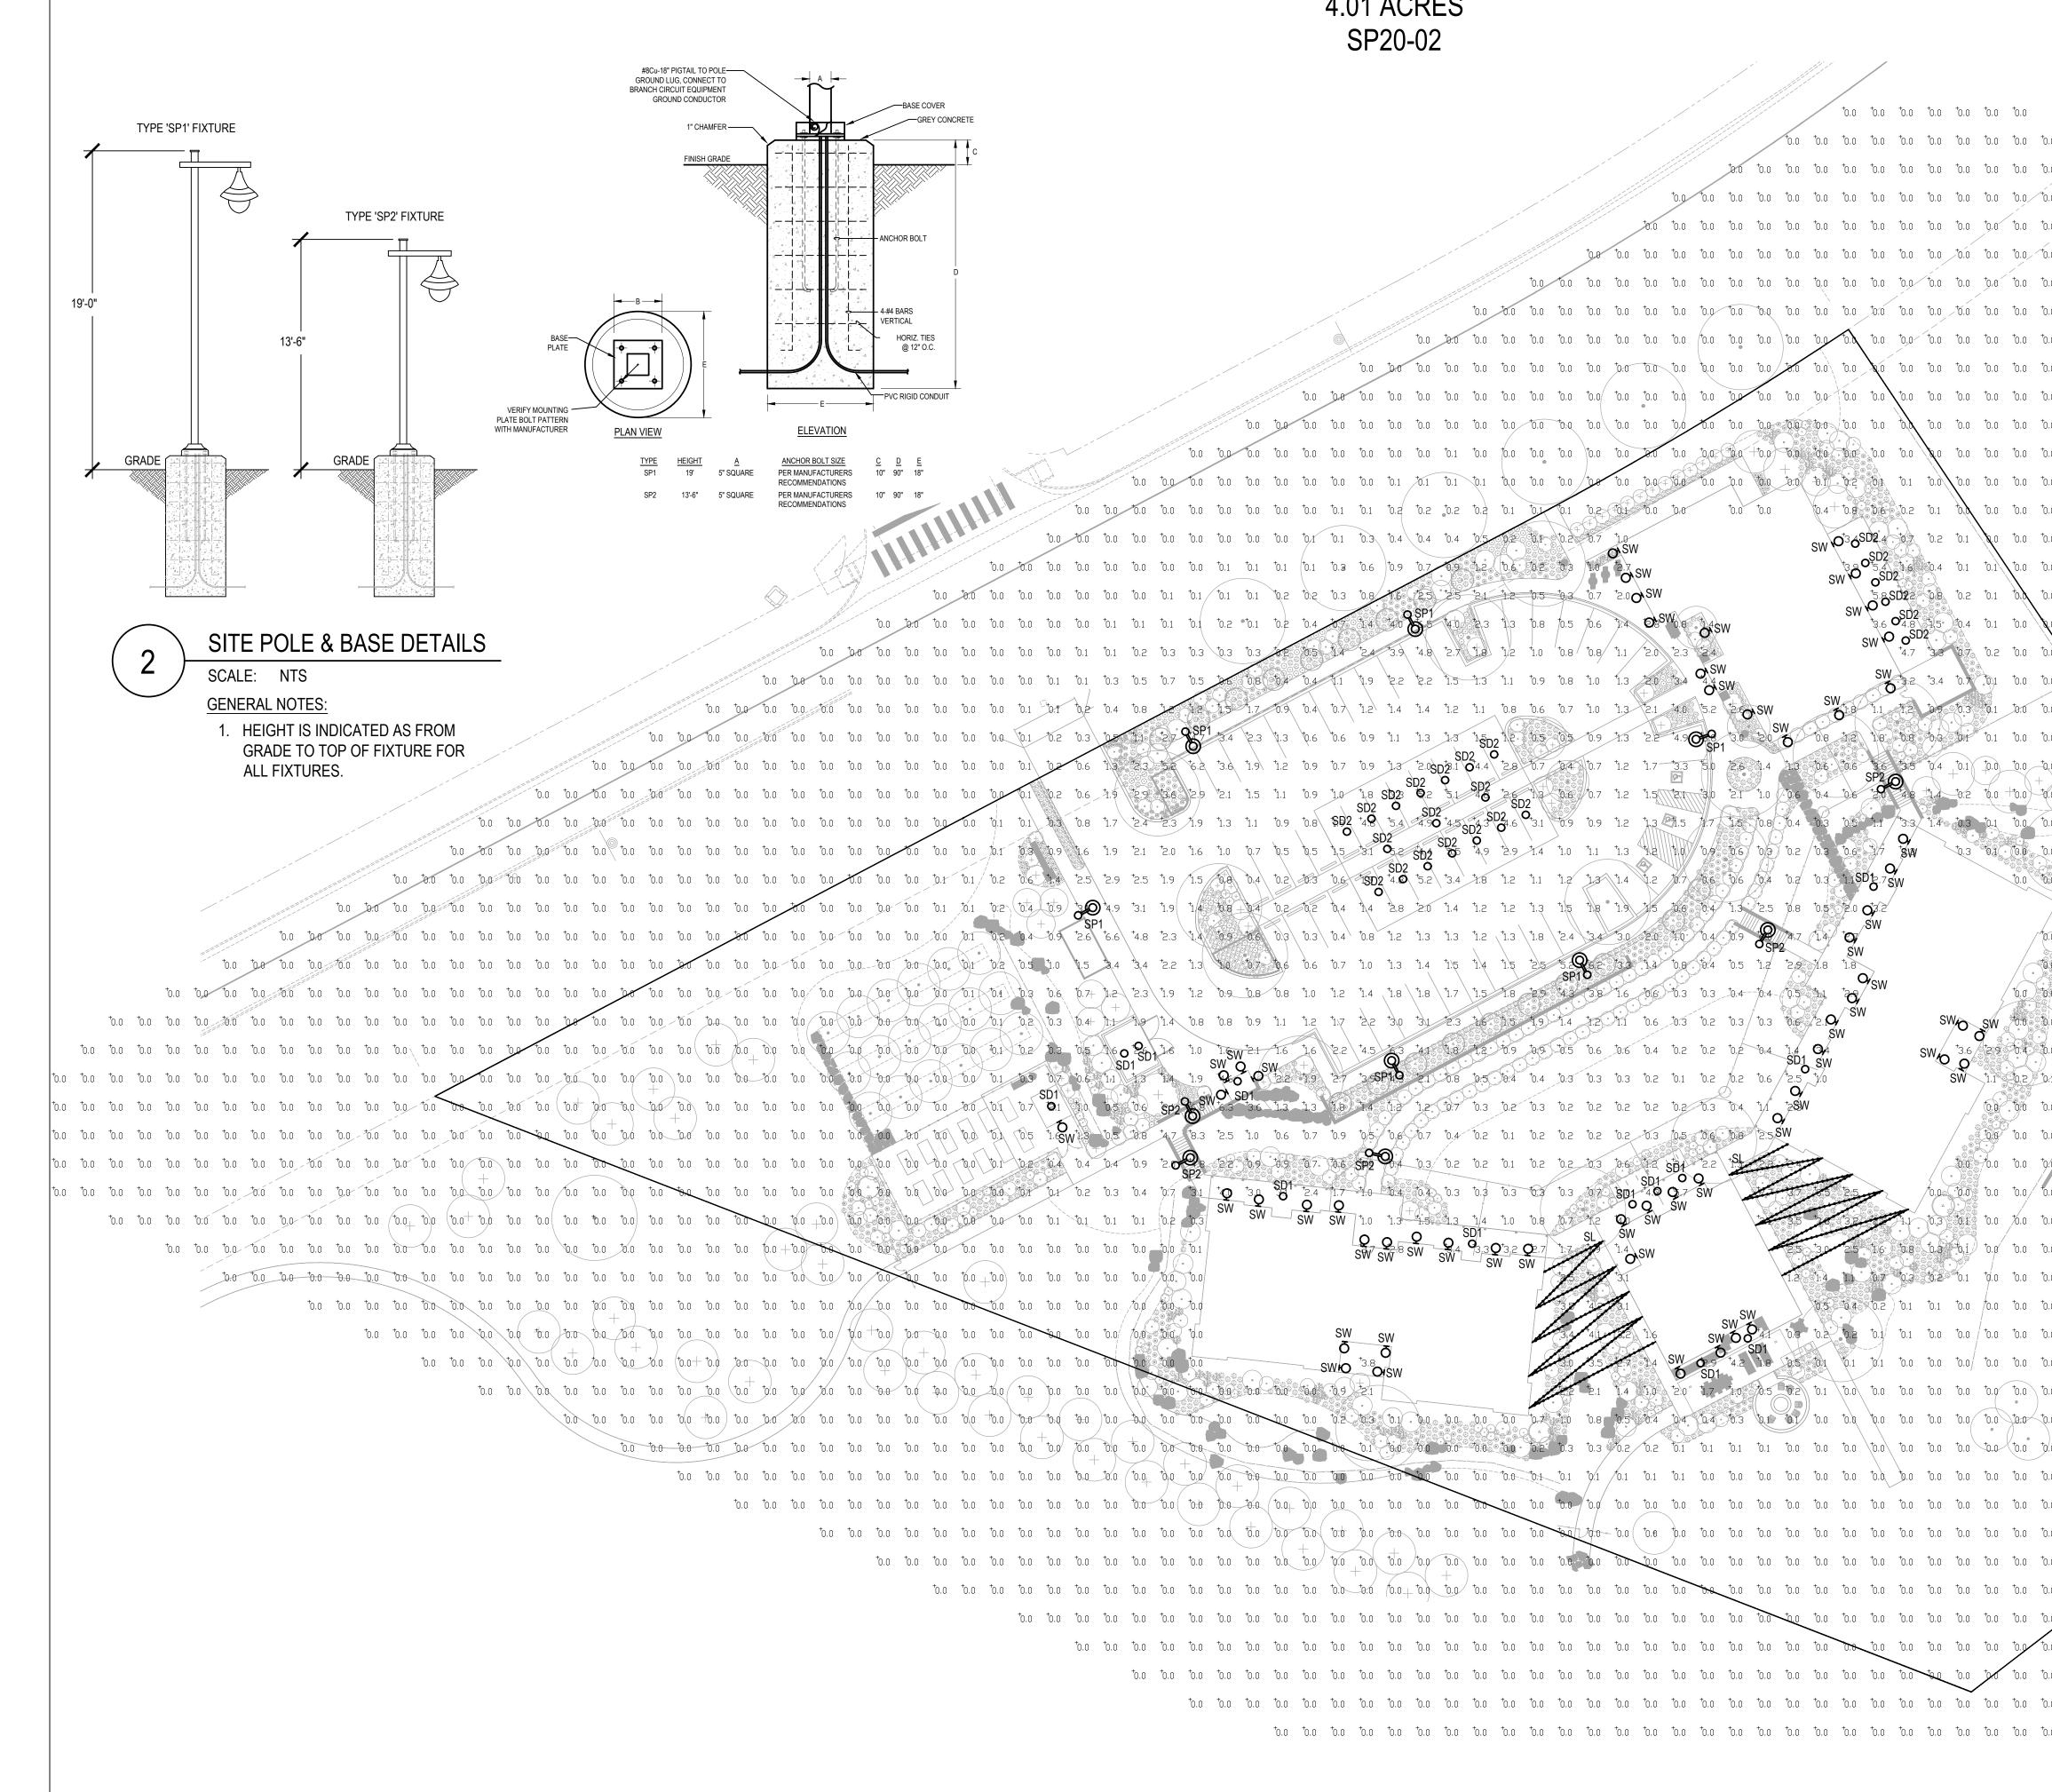

SM CHECKED BY DRAWN BY:

TALL TALES RANCH

4.01 ACRES SP20-02

¹.9 ¹2.1 ¹2.0 ¹1.6 ¹1.0 ¹0.7 ¹0.5 ¹0.5 ¹1.5 ¹3.

⁺1.€₩⁺2.1 ⁺1.6

⁺47, ⁺8.3 ⁺2.5 ⁺1.0 ⁺0.6 ⁺0.7 ⁺0.9 ⁺0.5 ⁺0.6 ⁺0.7

 $^{+0.5}$ $^{+0.5}$ $^{+0.5}$ $^{+0.5}$ $^{+0.5}$ $^{+1.6}$ $^{+1.0}$

†0.0 †0.0/ <u>†0.0 *0.0</u>

\$P2 \$ \$W+6.3

to.2 to.3 to.4 to.7 t31 to t30 to t

14 1.9 9.5 9 1.2 1.9 12 13 SP149 12.1 10.8 10.5 10.4 10.4 10.3 10.3 10.3 10.2 10.1 10.2 10.2 10.2 10.6



	SITE LIGHTING PHOTOMETRIC
	SCALE: 1" = 30'-0"
10.0 10.0	PHOTOMETRY PLAN GENERAL NOTES:
	1. VALUES SHOWN ARE MAINTAINED HORIZONTAL
to.o to.o to.o to.o to.o to.o to.o to.o	ILLUMINANCE VALUES MEASURED AT GRADE. 2. SITE LIGHTING DESIGN HAS BEEN COMPLETED TO
	PRODUCE EVEN ILLUMINATION OF PARKING AND
0.0 0.0 0.0 0.0 0.0 0.0 0.0 0.0 0.0 0.0	PAVED AREAS WITH MINIMAL GLARE ONTO ADJACENT PROPERTIES.
	3. ALL LIGHT FIXTURES SHALL BE FULLY SHIELDED
	AND DIRECT LIGHT DOWNWARDS. 4. THERE WILL BE NO OFF-SITE GLARE ALLOWED.
to.o to.o to.o to.o to.o to.o to.o to.o	
	CUT-OFF LIGHT FIXTURES THAT ARE INSTALLED WITHIN A DISTANCE OF 2.5 TIMES THE MOUNTING
	b.0 to.0 HEIGHT OF THE PROPERTY LINE.
	SITE LIGHTING DESIGN HAS BEEN COMPLETED TO
0 ⁺ 0.0 ⁺ 0.0 ⁺ 0.1 ⁺ 0.1 ⁺ 0.2 ⁺ 0.2 ⁺ 0.2 ⁺ 0.2 ⁺ 0.1 ⁺ 0.1 ⁺ 0.1 ⁺ 0.2 ⁺ 0.1 ⁺ 0.0	[•] [•] [•] [•] [•] • [•] • • • • • • •
$ \begin{array}{c} 0 & t_{0.0} & t_{0.1} & t_{0.3} & t_{0.4} & t_{0.4} & t_{0.4} & t_{0.5} & t_{0.2} & t_{0.7} & t_{1.0} \\ & & & & & & & & & \\ & & & & & & & \\ & & & & & & & \\ & & & & & & \\ & & & & & & \\ & & & & & & \\ & & & & & \\ & & & & & \\ & & & & & \\ & & & & & \\ & & & & & \\ & & & & & \\ & & & & & \\ & & & & & \\ & & & & & & \\ & & & & & \\ & & & & & & \\ & & & & & & \\ & & & & & & \\ & & & & & \\ & & & & & & \\ & & & & & \\ & & & & & & \\ & & & & & & \\ & & & & & & \\ & & & & & & \\ & & & & & & \\ & & & & & & \\ & & & & & & \\ & & & & & & \\ & & & & & & \\ & & & & & & \\ & & & & & & \\ & & & & & & \\ & & & & & & \\ & & & $	
$t_{0.1}$ $t_{0.1}$ $t_{0.3}$ $t_{0.6}$ $t_{0.7}$ $t_{0.9}$ $t_{0.7}$ $t_{0.6}$ $t_{0.8}$ $t_{0.3}$ $t_{0.7}$ $t_{0.0}$ t_{0	0 [†] 0.0 [†] 0.0 [†] 0.0
1 to.2 to.2 to.3 to.8 the 125 to 3 to.7 to.0 to.0 to.0 to.0 to.0 to.0 to.0 to.0	0 ⁺ 0.0 ⁺ 0.0 ⁺ 0.0 ⁺ 0.0
$\begin{array}{cccccccccccccccccccccccccccccccccccc$	0 ⁺ 0.0 ⁺ 0.0 ⁺ 0.0 ⁺ 0.0
3 82 0.5 14 24 3.9 4.8 2.7 1.8 1/2 1.0 0.8 0.8 1.1 2.0 2.3 2.4	
$\begin{array}{cccccccccccccccccccccccccccccccccccc$	o ⁺ o.0 ⁺ o.0 ⁺ o.0 ⁺ o.0 ⁺ o.0 ⁺ o.0
2 to 9 to 4 to 7 to 2 to 4 to 7 to 2 to 4 to 7 to 1.2 to 4 to 7 to 2 to 5.2 to	
$ \begin{array}{c ccccccccccccccccccccccccccccccccccc$	
5 1.1 0.9 1.0 1.8 SD2 0.2 5.1 40 2.6 1.2 0.6 0.7 1.2 1.5 121 30 2.1 1.0 0.6 0.4 0.6 120 48 1.4 0.2 0.0	
to.9 to.8 \$D2 +4.9 to.4 +4.90 to.5 to.4 to.5 to.5 to.5 to.5 to.5 to.5 to.5 to.5	
$\begin{array}{c ccccccccccccccccccccccccccccccccccc$	
	0 to 0
SW SW	
SBIO Of Ofsw	7 0.0
= 1.1 1.2 1.7 1.2 1.4 1.8 1.7 1.0 1.8 1.7 1.7 1.8 1.7 1.7 1.8 1.7 1.7 1.8 1.7 1.7 1.8 1.7 1.7 1.8 1.7 1.7 1.8 1.7 1.7 1.8 1.7 1.7 1.8 1.7 1.7 1.8 1.7 1.7 1.8 1.7 1.7 1.8 1.7 1.7 1.8 1.7 1.7 1.8 1.7 1.8 1.7 1.8 1.7 1.8 1.7 1.8 1.7 1.8 1.7 1.8 1.7 1.8 1.7 1.8 1.8 1.7 1.8 1.8 1.7 1.8 1.8 1.7 1.8 1.8 1.7 1.8 1	
$\begin{array}{cccccccccccccccccccccccccccccccccccc$	
$\begin{array}{c} \mathbf{SW} + \mathbf{SD} \\ \mathbf{SW} \\$	
6 1.3 1.3 1.8 1.4 1.2 1.2 1.2 0.7 0.3 0.2 0.3 0.2 0.2 0.2 0.2 0.2 0.2 0.2 0.4 1/1 28W	
0 to.6 to.7 to.9 to.5 to.6 to.7 to.4 to.2 to.2 to.2 to.2 to.2 to.3 to 5 to 6 to 8 t2.5 SW	
2 to 9 to 7 to 6 5 to 2 to	0.0 ^t 0.0 ^t 0.0 ^t 0.0 ^t 0.0 ^t 0.0
SD1 - 2.4 1.7 1.0 to.4 to.4 to.3 to.3 to.3 to.3 to.3 to.3 to.3 to.3	
Q Q	o to.o to.o to.o to.o to.o to.o
Q Q SUT SU	o ⁺ o.o ⁺ o.o ⁺ o.o ⁺ o.o ⁺ o.o ⁺ o.o
13 7 ¹ 4 7 3,1 SW 5 ¹ 0,4 ¹ 0.2 ¹ 0.1 ¹ 0.1 ¹ 0.0	o to.o to.o to.o to.o to.o
SW S	
SWIO 3.8 SWIO 3.8 SWIO 3.5 SWIO 3.5 SWIO 3.5 SUI 4.2 SWIO 9 4.2 SUI 5.5 SD1 SD1 SD1 SD1 SD1 SD1 SD1 SD1 SD1 SD1	o ⁺ o.o ⁺ o.o ⁺ o.o ⁺ o.o ⁺ o.o \
1 0.0 10.0 10.9 12.1 1.4 1.0 12.0 1.7 1.0 0.5 10.2 10.1 10.0 10.0 10.0 10.0 10.0 10.0	
- to	
	0 ⁺ 0.0 ⁺ 0.0 ⁺ 0.0 ⁺ 0.0 [−] 0.0
0 the test test test test test test test	
	J 0.0
	J


OWNER:

TALL TALES RANCH SUSAN MOONEY 6311 SOUTH GRANT DRIVE CENTENNIAL, CO 80121 303.806.9140

NOT FOR CONSTRUCTION

DATE: <u>(SIP 01) 01/10/2020</u> (SIP 02) 04/05/2020

> SHEET TITLE: SITE LIGHTING PHOTOMETRIC

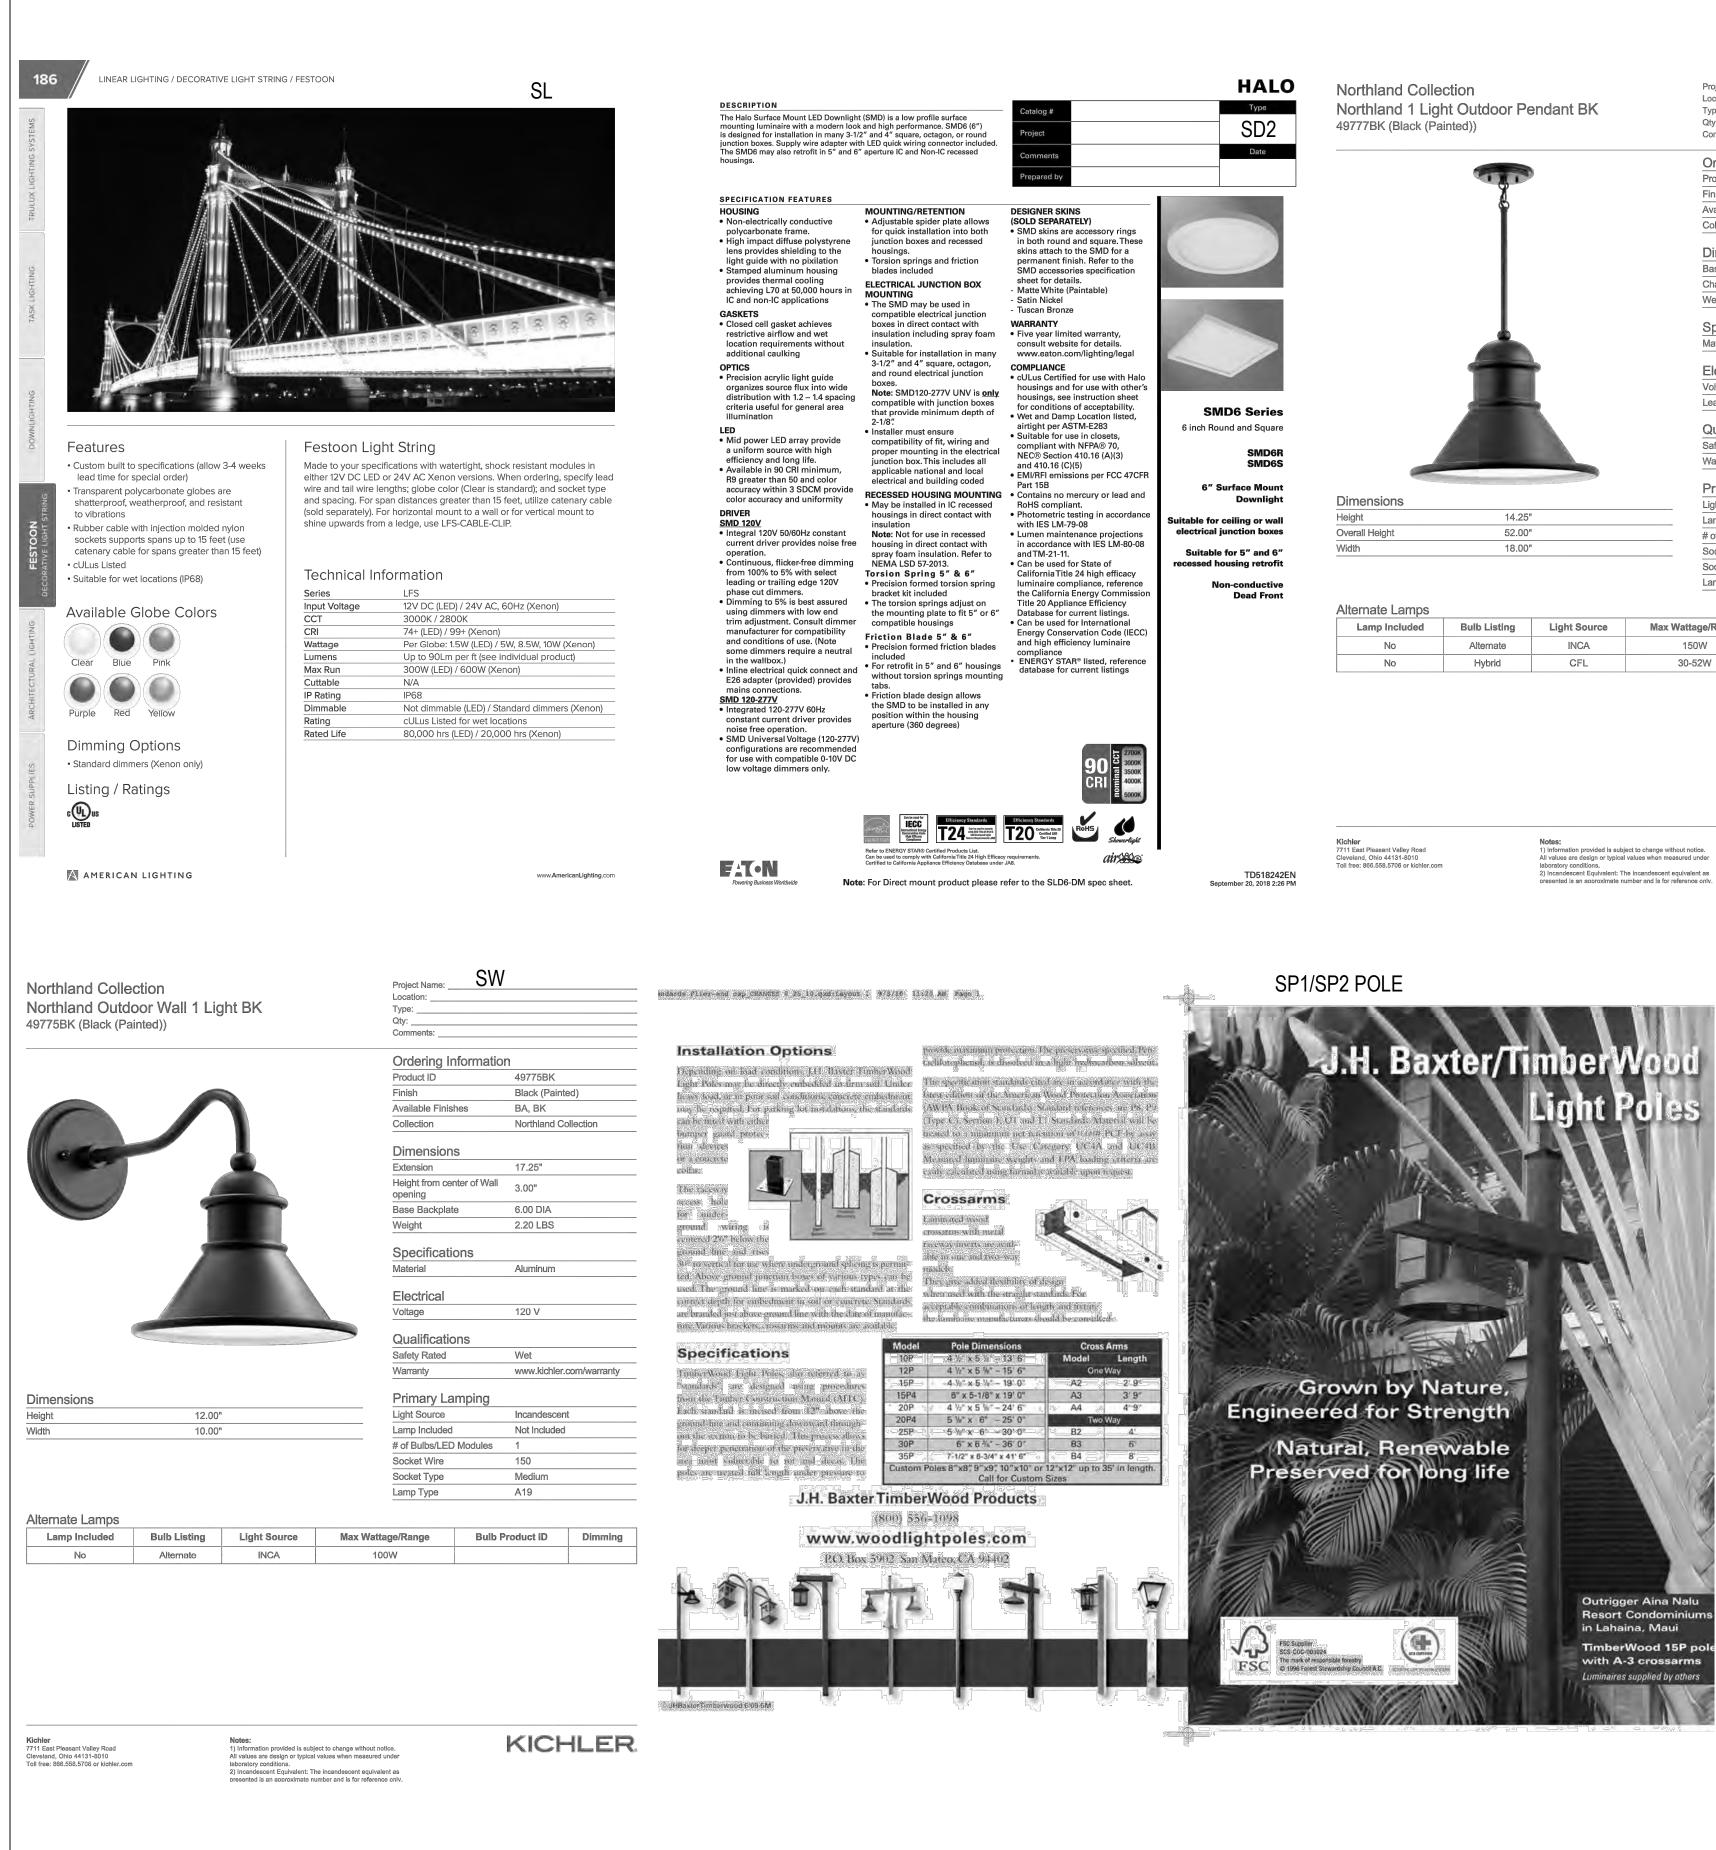


TALL TALES RANCH

A PARCEL OF LAND LOCATED IN THE NORTHWEST QUARTER OF SECTION 23, TOWNSHIP 6 SOUTH, RANGE 67 WEST OF THE SIXTH PRINCIPAL MERIDIAN, CITY OF LONE TREE, COUNTY OF DOUGLAS, STATE OF COLORADO

4.01 ACRES SP20-02

					SCHEDULE							
			Symbol	Label	General Description	Mounting Height	Color	Catalog Number	Lamp	LLF	Watts	SHIELDING
HALO	Northland Callection	Project Name:SD1			PENDANT DOWNLIGHT	10'-0" AFG	BLACK	KICHLER	LED	1.00	13W	FULL CUT-
Туре	Northland Collection Northland 1 Light Outdoor Pendant BK	Location:		SD1								
SD2	49777BK (Black (Painted))	Type: Qty:			ENTRIES			49777BK				
Date	· · · · · ·	Comments:	-									
		Ordering Information		0.000	DOWNLIGHT	10'-0" AFG	NA	HALO	LED	1.00	9.6W	FULL CUT-
		Product ID 49777BK Finish Black (Painted)		SD2	OVERHANGS			SMD6R-6-930-WH				
	80 C	Available Finishes BA, BK										
		Collection Northland Collection	. 🦻		CATENARY LIGHTS	12'-0" AFG	N/A	AMERICAN LIGHTING	LED	1.00	1.5W/FT	N/A
S		Dimensions	ø	SL				LFS-12V-1.5-LED				
		Base Backplate 6.00 DIA Chain/Stem Length 36.00"			FRONT COURTYARD							
		Weight 2.50 LBS	·							1.00	40714	
		Specifications		SP1	PARKING POLE	19'-0" AFG	BRONZE LUMINAIRE	LUMCA CPL6405-EKF-48LED07	LED	1.00	107W	FULL CUT
		Material Aluminum		5P1	PARKING/DRIVES		W/ WOODEN	107W-30K-L4-120-BE				
							POLE	POLE				
		Electrical Voltage 120 V						TIMBERWOOD 15P4				
CMDC Carias		Lead Wire Length 67.00"						W/ A2 CROSSARM				
SMD6 Series inch Round and Square		Qualifications			PEDESTRIAN POLE	13'-6" AFG	BRONZE	LUMCA	LED	1.00	30W	FULL CUT-
SMD6R		Safety Rated Damp		SP2			LUMINAIRE	CPL6414-EKF-18LED07				
SMD6S		Warranty www.kichler.com/warranty			SIDEWALKS		W/ WOODEN POLE	30W-30K-L2B-120-BE				
6" Surface Mount		Primary Lamping						POLE				
Downlight le for ceiling or wall	Dimensions Height 14.25"	Light Source Incandescent	-					TIMBERWOOD 10PV				
ctrical junction boxes	Overall Height 52.00"	# of Bulbs/LED Modules 1										
Suitable for 5″ and 6″ essed housing retrofit	Width 18.00"	Socket Wire 105			WALL SCONCE	8'-0" AFG	BLACK	KICHLER	LED	1.00	13W	FULL CUT
Non-conductive		Socket Type Medium Lamp Type A21	Q	SW	ENTRIES			49775BK				
Dead Front												
	Lamp Included Bulb Listing Light Source No Alternate INCA No Hybrid CFL	Max Wattage/RangeBulb Product IDDimming150W30-52W										
TD518242EN Sentember 20.0018 2:26 PM	Lamp Included Bulb Listing Light Source No Alternate INCA	150W 30-52W ange without notice. then measured under lescent equivalent as	- P									
September 20, 2018 2:26 PM	Lamp Included Bulb Listing Light Source No Alternate INCA No Hybrid CFL	150W 30-52W ange without notice. then measured under the measured under the secont equivalent as d is for reference only. KICHLERR	P611		SP2	Dark Sky with lens #4 Image: A start of the		/ Location Project name		SP1		Dark Sky witi
September 20, 2018 2:26 PM	Lamp Included Bulb Listing Light Source No Alternate INCA No Hybrid CFL No Mybrid Supervised Isource Mybrid The function provided Is subject to a function colspan="2">Alternation colspan="2">Alternation colspan="2">Alternation colspan="2">Alternation colspan="2">Alternation colspan="2">Alternation colspan="2">Alternation colspan="2">Alternatis colspan="2" VIEND	150W 30-52W ange without notice. then measured under the measured under the secont equivalent as d is for reference only. KICHLERR	P611	- 300 - 1 to - Ligh - Too - IP66 - CSA - Dar	LED WARD WARD WARD WARD WARD WARD WARD WAR	 F: G: G	Date City Type C	/Location Project name TY - 30 - 11 - Li, - Tc - IP - CS	0000K (30K) ar to 4 LED mod ight distribut pol-less acces 266. SA / CSA-US d	nd 4000K (40k dules (30 to 1 tion available ss. certified.	().	
September 20, 2018 2:26 PM	Lamp Included Bulb Listing Light Source No Alternate INCA No Hybrid CFL No Mybrid Supervised Isource Mybrid The function provided Is subject to a function colspan="2">Alternation colspan="2">Alternation colspan="2">Alternation colspan="2">Alternation colspan="2">Alternation colspan="2">Alternation colspan="2">Alternation colspan="2">Alternatis colspan="2" VIEND	150W 30-52W ange without notice. then measured under the measured under the secont equivalent as d is for reference only. KICHLERR	P611	- 300 - 1 to - Ligh - Too - IP66 - CSA - Dar	LED WARD WARD WARD WARD WARD WARD WARD WAR	 Image: A second s	Date City Type C	/Location Project name TY	0000K (30K) ar to 4 LED mod ight distribut pol-less acces 266. SA / CSA-US d	nd 4000K (40k dules (30 to 1 tion available ss. certified.	(). 20 watts). in type II, III, I	V and V.
September 20, 2018 2:26 PM	Lamp Included Bulb Listing Light Source No Alternate INCA No Hybrid CFL No Mybrid Supervised Isource Mybrid The function provided Is subject to a function colspan="2">Alternation colspan="2">Alternation colspan="2">Alternation colspan="2">Alternation colspan="2">Alternation colspan="2">Alternation colspan="2">Alternation colspan="2">Alternatis colspan="2" VIEND	150W 30-52W ange without notice. then measured under the measured under the secont equivalent as d is for reference only. KICHLERR	P611	- 300 - 1 to - Ligh - Too - IP66 - CSA - Dar	LED WARD WARD WARD WARD WARD WARD WARD WAR	 Image: A second s	Date City Type C	/Location Project name TY - 30 - 11 - Li, - Tc - IP - CS	0000K (30K) ar to 4 LED mod ight distribut pol-less acces 266. SA / CSA-US d	nd 4000K (40k dules (30 to 1 tion available ss. certified.	(). 20 watts). in type II, III, I	V and V.

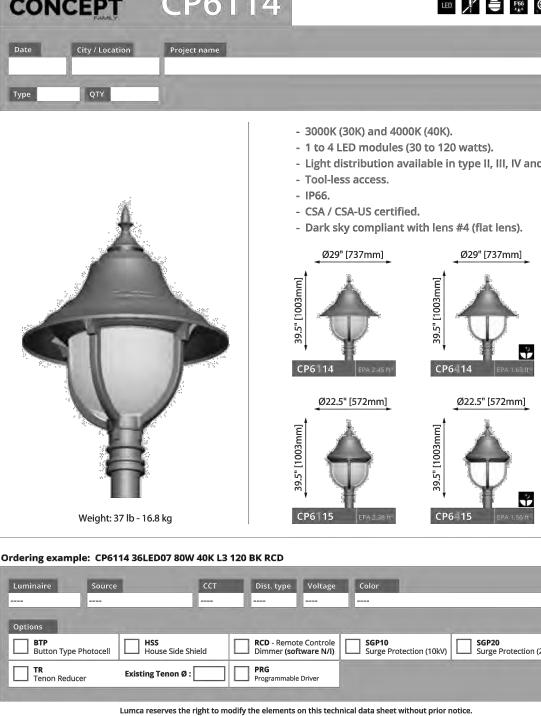

പന്നാ LIGHTING LIFE T : 877.650.1693 | www.lumca.com





OWNER:

TALL TALES RANCH SUSAN MOONEY 6311 SOUTH GRANT DRIVE CENTENNIAL, CO 80121 303.806.9140


NOT FOR

CONSTRUCTION

DATE:

<u>(SIP 01) 01/10/2020</u>

(SIP 02) 04/05/2020

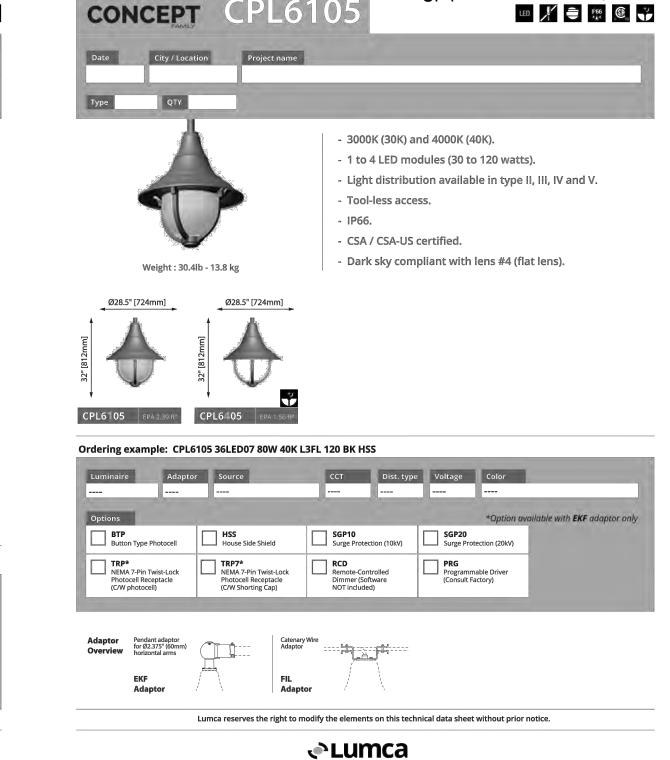

T : 877.650.1693 | www.lumca.com

SHEET TITLE: SITE LIGHTING DETAILS



TALL TALES RANCH

4.01 ACRES

SIP SP20-02



2 EAST ELEVATION

3/16" = 1'-0"

15 OF 27

SHEET TITLE: BARN ELEVATIONS

NOT FOR CONSTRUCTION

DATE:

TALL TALES RANCH SUSAN MOONEY 6311 SOUTH GRANT DRIVE CENTENNIAL, CO 80121 303.806.9140





 \bigcirc Godden|Sudik ARCHITECTS 5975 S. Quebec Street, Suite 250 Centennial, Colorado 80111 ph 303.455.4437 fx 303.477.5680

www.goddensudik.com





AC UNITS -WEST ELEVATION 2 3/16" = 1'-0"

TALL TALES RANCH

4.01 ACRES SIP SP20-02



16 OF 27

BARN ELEVATIONS

SHEET TITLE:

DATE: <u>(SIP 01) 01/10/2020</u> (SIP 02) 04/05/2020


NOT FOR CONSTRUCTION

6311 SOUTH GRANT DRIVE CENTENNIAL, CO 80121 303.806.9140

OWNER: TALL TALES RANCH SUSAN MOONEY

ANCH R AN S a L Ż Ξ A -E IMPROVE E TREE, COLORAD **___** ' 4 Ō SITE

Godden|Sudik ARCHITECTS 5975 S. Quebec Street, Suite 250 Centennial, Colorado 80111 ph 303.455.4437 fx 303.477.5680 www.goddensudik.com

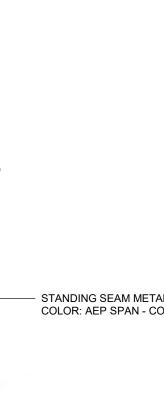

- DIMENSIONAL ASPHALT SHINGLE ROOF COLOR: WEATHERED WOOD - LP SMARTSIDE - DEEP GRAIN VERTICAL SIDING COLOR: TETON - CEMENTITIOUS HARDBOARD FASCIA COLOR: GAUNTLET GRAY – VINYL WINDOWS CEMENTITIOUS HARDBOARD TRIM COLOR: DRIFT OF MIST - STANDING SEAM METAL ROOF COLOR: AEP SPAN - COOL ZINC GRAY 2ND LEVEL

- 6" CEMENTITIOUS LAP SIDING

COLOR: EARL GREY

1ST LEVEL 100'-0"

- AC UNITS

-

2ND LEVEL - WALL MOUNT OUTDOOR LIGHT FIXTURE COLOR: BRUSHED ALUMINUM 6" CEMENTITIOUS LAP SIDING COLOR: EARL GREY CEMENTITIOUS HARDBOARD
 TRIM AT WINDOWS AND DOORS
 COLOR: DRIFT OF MIST 1ST LEVEL 100'-0"

- STANDING SEAM METAL ROOF COLOR: AEP SPAN - COOL ZINC GRAY





TALL TALES RANCH

SIP SP20-02

17 OF 27

PAIRED 7-PLEX ELEVATIONS

SHEET TITLE:

NOT FOR

CONSTRUCTION

DATE:

<u>(SIP 01) 01/10/2020</u> (SIP 02) 04/05/2020

303.806.9140

Ö

CIT

TALL TALES SITE IMPROVEMENT F LONE TREE, COLORADO AL OWNER: TALL TALES RANCH SUSAN MOONEY 6311 SOUTH GRANT DRIVE CENTENNIAL, CO 80121

RANCH

N L PL

 DIMENSIONAL ASPHALT SHINGLE ROOF COLOR: WEATHERED WOOD - DIMENSIONAL ASPHALT SHINGLE ROOF COLOR: WEATHERED WOOD CEMENTITIOUS BOARD AND BATT SIDING COLOR: DRIFT OF MIST CEMENTITIOUS HARDBOARD FASCIA COLOR: GAUNTLET GRAY


VINYL WINDOWS

CEMENTITIOUS HARDBOARD TRIM COLOR: SNOWBOUND

- STANDING SEAM METAL ROOF COLOR: AEP SPAN - COOL ZACTIQUE II

- WALL MOUNT OUTDOOR LIGHT FIXTURE COLOR: BRUSHED ALUMINUM

WOOD POSTS, BEAMS & BRACKETS COLOR: SNOWBOUND 6" CEMENTITIOUS LAP SIDING COLOR: GRAY CLOUDS CEMENTITIOUS HARDBOARD
 TRIM AT WINDOWS AND DOORS
 COLOR: SNOWBOUND

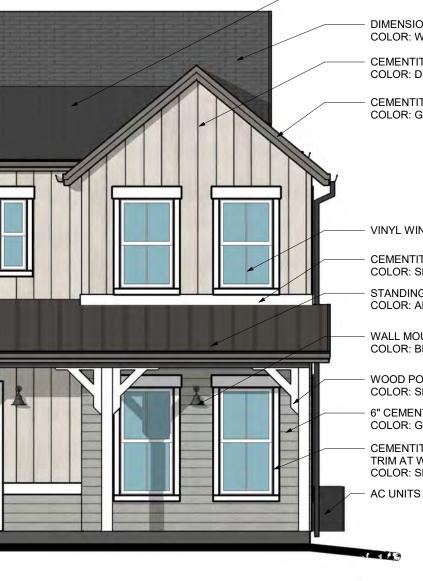

\sim Godden|Sudik ARCHITECTS

5975 S. Quebec Street, Suite 250 Centennial, Colorado 80111 ph 303.455.4437 fx 303.477.5680 www.goddensudik.com



EAST ELEVATION 3/16" = 1'-0"



TALL TALES RANCH

4.01 ACRES SIP SP20-02



Centennial, Colorado 80111 ph 303.455.4437 fx 303.477.5680 www.goddensudik.com

DIMENSIONAL ASPHALT SHINGLE ROOF COLOR: WEATHERED WOOD

DIMENSIONAL ASPHALT SHINGLE ROOF COLOR: WEATHERED WOOD CEMENTITIOUS BOARD AND BATT SIDING COLOR: DRIFT OF MIST CEMENTITIOUS HARDBOARD FASCIA COLOR: GAUNTLET GRAY

VINYL WINDOWS

- CEMENTITIOUS HARDBOARD TRIM COLOR: SNOWBOUND

- 6" CEMENTITIOUS LAP SIDING COLOR: GRAY CLOUDS

- CEMENTITIOUS HARDBOARD TRIM AT WINDOWS AND DOORS COLOR: SNOWBOUND AC UNITS



OWNER:

TALL TALES RANCH SUSAN MOONEY 6311 SOUTH GRANT DRIVE CENTENNIAL, CO 80121 303.806.9140

NOT FOR CONSTRUCTION

DATE: <u>(SIP 01) 01/10/2020</u> (SIP 02) 04/05/2020

SHEET TITLE: PAIRED 7-PLEX ELEVATIONS

18 OF 27

DIMENSIONAL ASPHALT SHINGLE ROOF COLOR: WEATHERED WOOD

- CEMENTITIOUS HARDBOARD FASCIA COLOR: GAUNTLET GRAY

CEMENTITIOUS BOARD AND BATT SIDING COLOR: DRIFT OF MIST

VINYL WINDOWS

- CEMENTITIOUS HARDBOARD TRIM COLOR: SNOWBOUND - STANDING SEAM METAL ROOF


COLOR: AEP SPAN - COOL ZACTIQUE II - WALL MOUNT & PENDANT OUTDOOR LIGHT FIXTURES COLOR: BRUSHED ALUMINUM

WOOD POSTS, BEAMS & BRACKETS
 COLOR: SNOWBOUND

- 6" CEMENTITIOUS LAP SIDING

CEMENTITIOUS HARDBOARD TRIM AT WINDOWS AND DOORS COLOR: SNOWBOUND

- AC UNITS

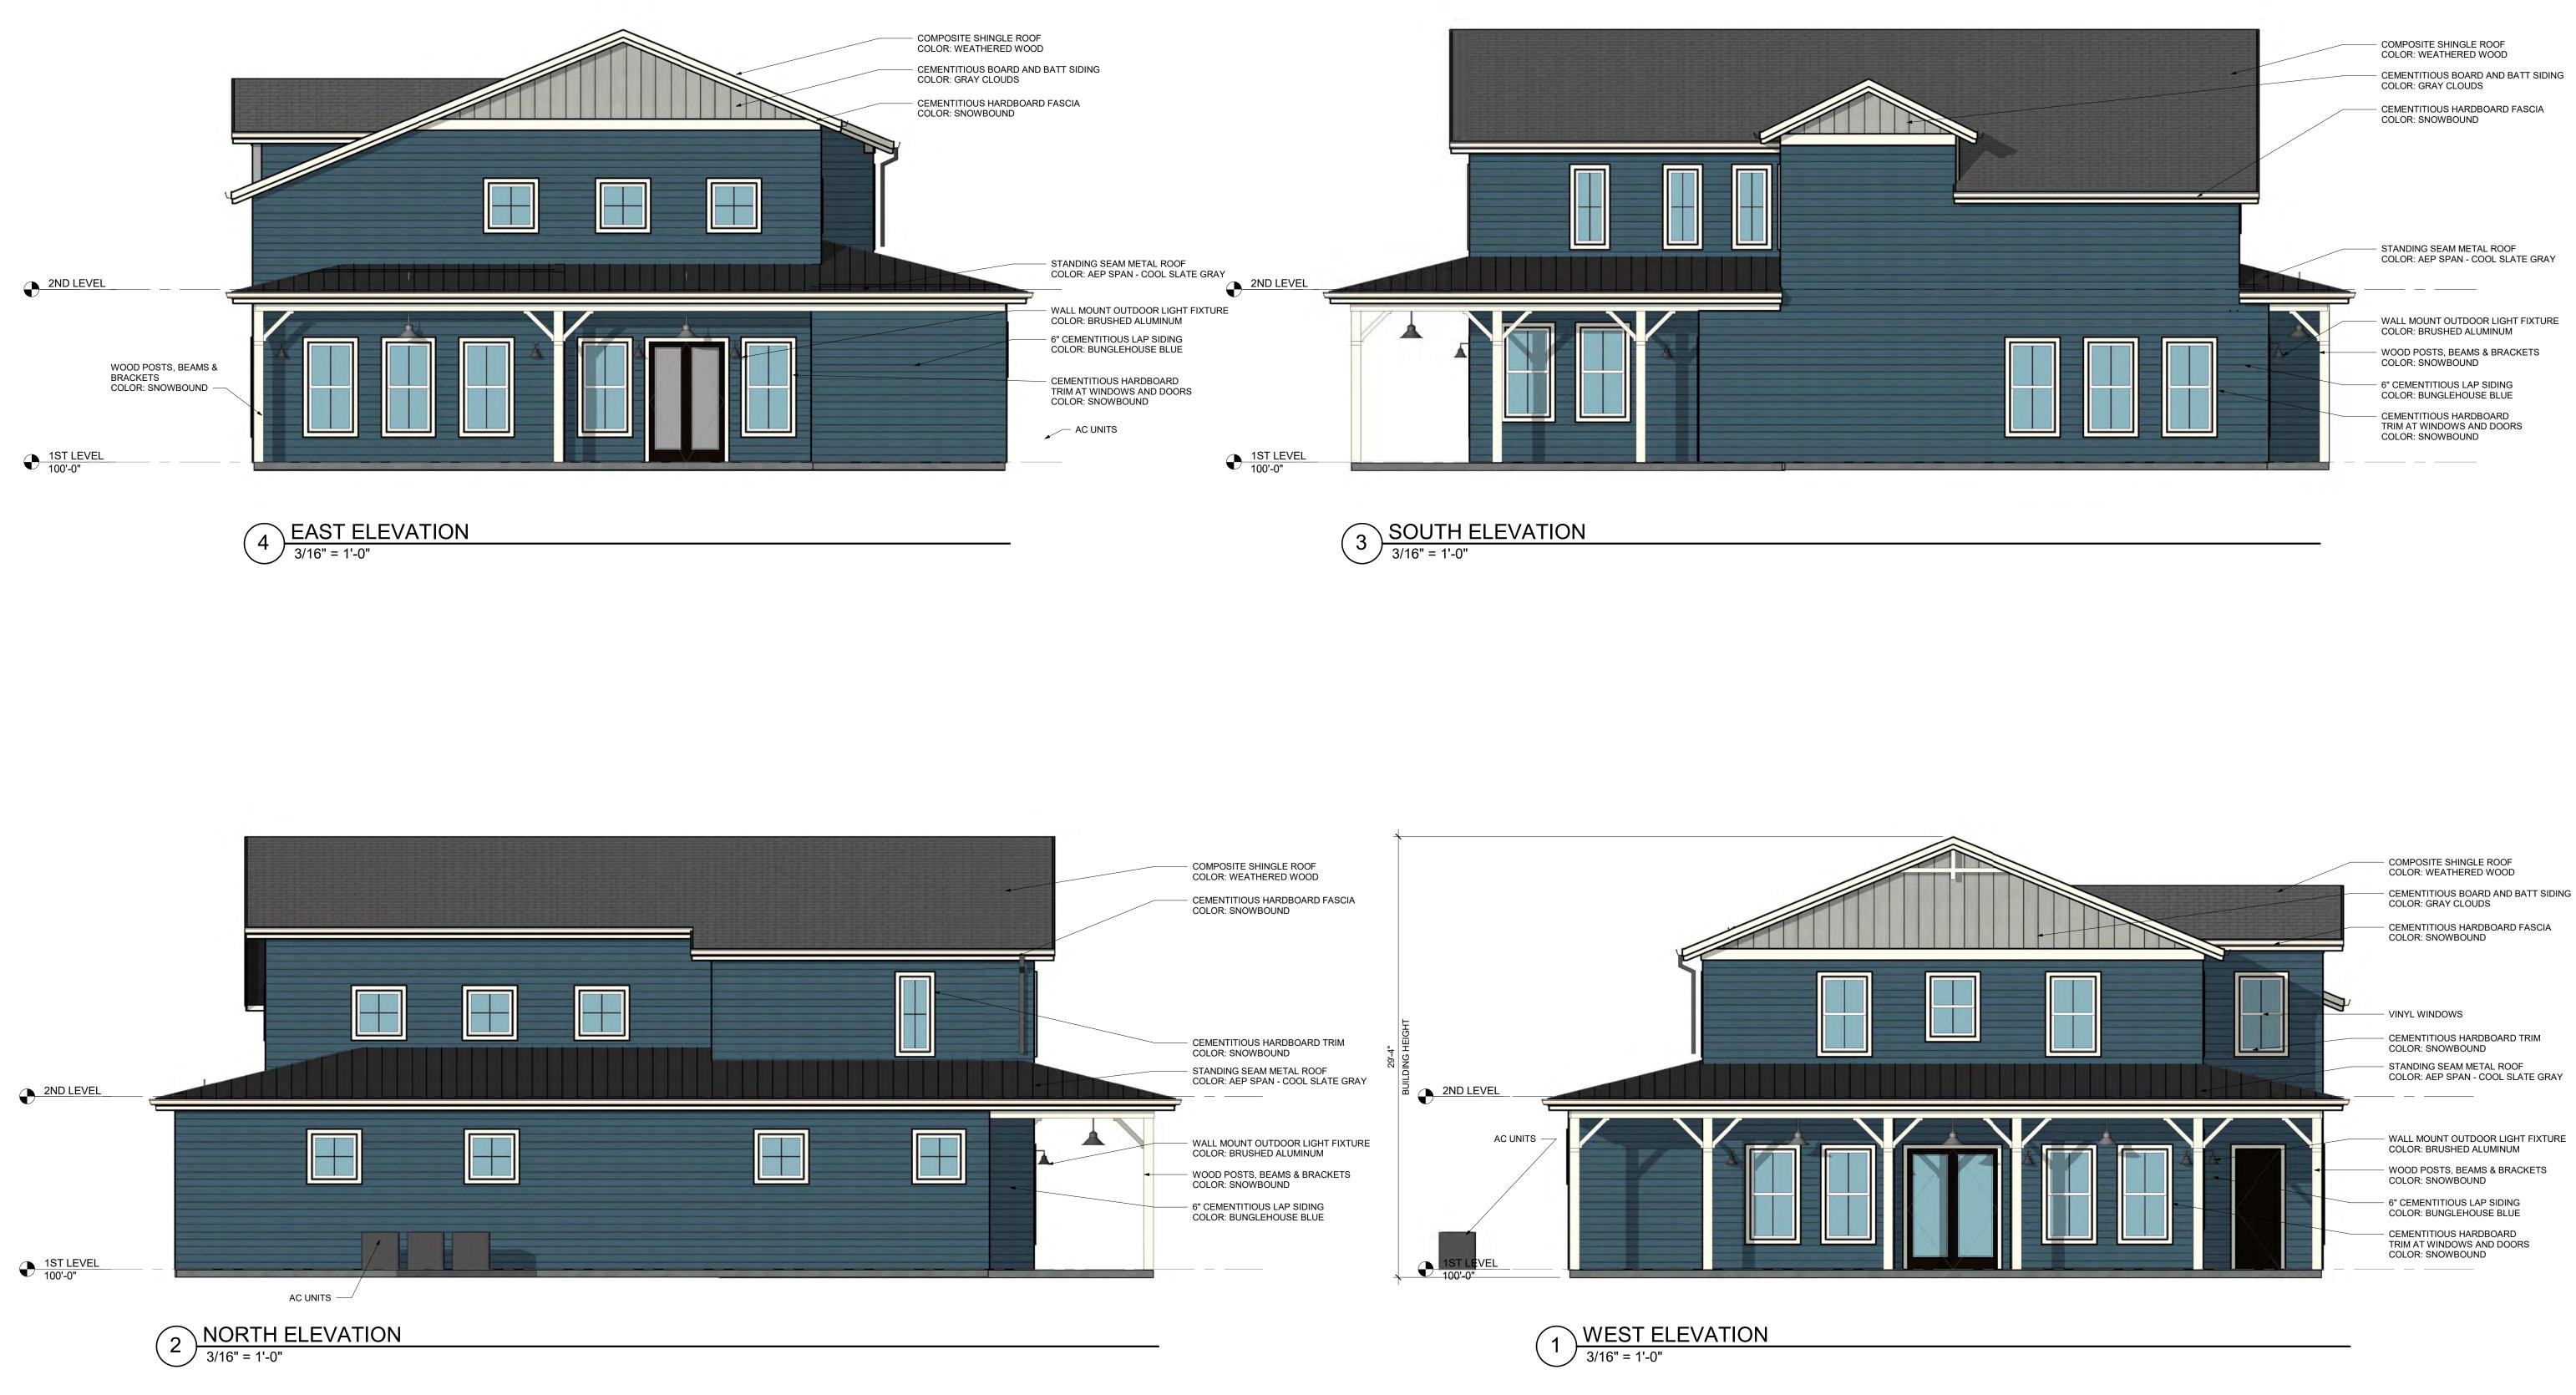

TALL TALES RANCH

4.01 ACRES SIP SP20-02

19 OF 27

SHEET TITLE: MAIN COTTAGE ELEVATIONS

DATE:

<u>(SIP 01) 01/10/2020</u>

(SIP 02) 04/05/2020

NOT FOR CONSTRUCTION

TALL TALES RANCH SUSAN MOONEY 6311 SOUTH GRANT DRIVE CENTENNIAL, CO 80121 303.806.9140

OWNER:


COLOR: AEP SPAN - COOL SLATE GRAY

WALL MOUNT OUTDOOR LIGHT FIXTURE WOOD POSTS, BEAMS & BRACKETS

Ζ N C, \geq 4 IMPROVI REE, COLORAE 0

ARCHITECTS 5975 S. Quebec Street, Suite 250 Centennial, Colorado 80111 ph 303.455.4437 fx 303.477.5680 www.goddensudik.com

Godden|Sudik

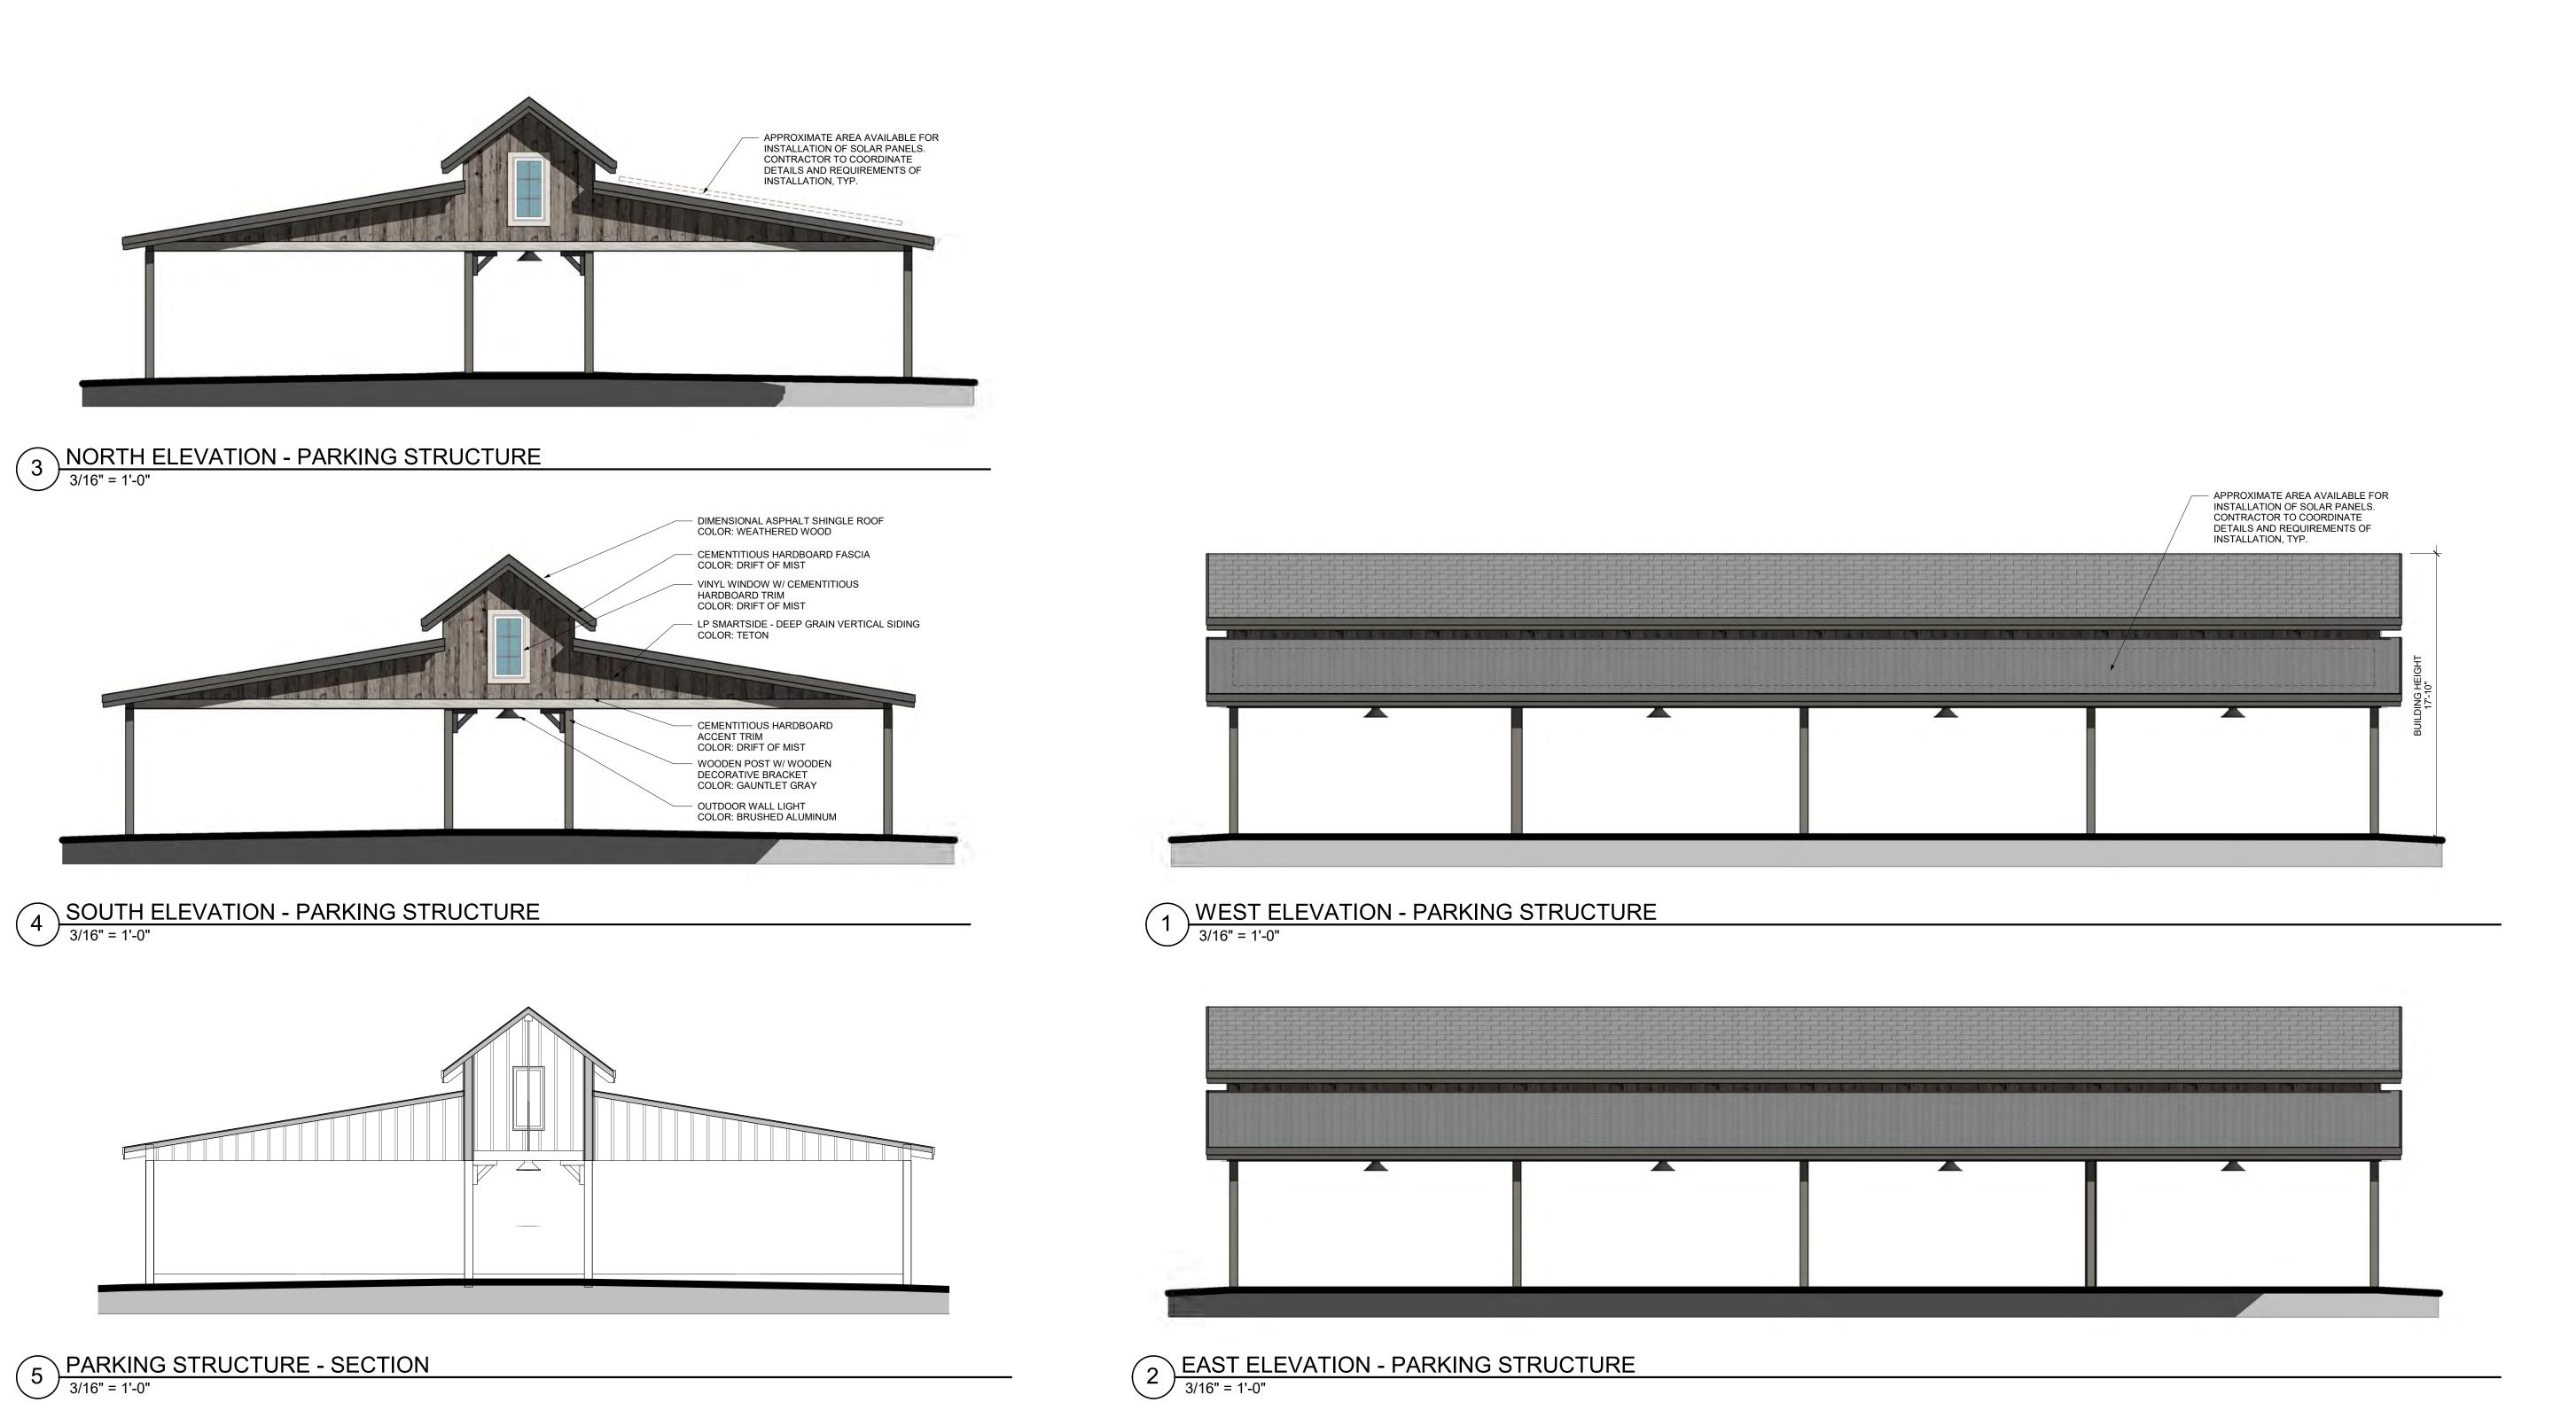


TALL TALES RANCH

4.01 ACRES SIP SP20-02



SHEET TITLE: PARKING STRUCTURE

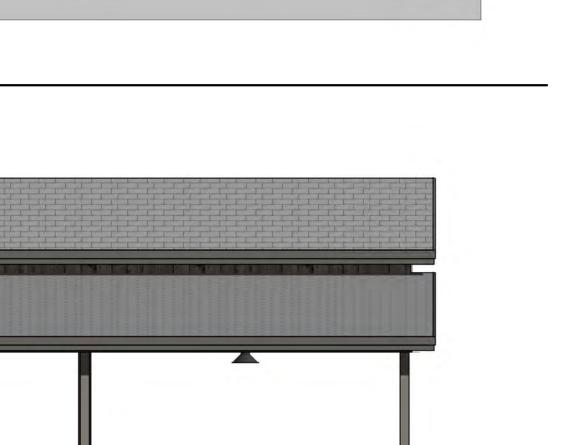



IMPI REE, co

OWNER:

TALL TALES RANCH SUSAN MOONEY 6311 SOUTH GRANT DRIVE CENTENNIAL, CO 80121 303.806.9140

NOT FOR CONSTRUCTION

DATE:


<u>(SIP 01) 01/10/2020</u> (SIP 02) 04/05/2020

Godden|Sudik ARCHITECTS 5975 S. Quebec Street, Suite 250 Centennial, Colorado 80111 ph 303.455.4437 fx 303.477.5680

www.goddensudik.com





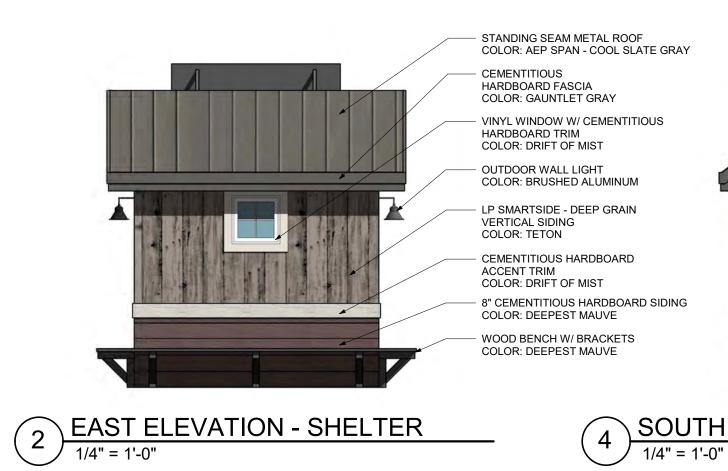

TALL TALES RANCH


4.01 ACRES SIP SP20-02



5 SOUTH ELEVATION - POTTING SHED



4 SOUTH ELEVATION - SHELTER

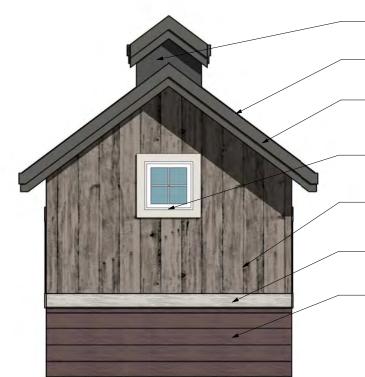


CEMENTITIOUS HARDBOARD PANEL COLOR: GAUNTLEY GRAY STANDING SEAM METAL ROOF COLOR: AEP SPAN - COOL SLATE GRAY

CEMENTITIOUS

HARDBOARD FASCIA COLOR: GAUNTLET GRAY VINYL WINDOW W/ CEMENTITIOUS HARDBOARD TRIM COLOR: DRIFT OF MIST LP SMARTSIDE - DEEP GRAIN VERTICAL SIDING COLOR: TETON CEMENTITIOUS HARDBOARD ACCENT TRIM COLOR: DRIFT OF MIST 8" CEMENTITIOUS HARDBOARD SIDING COLOR: DEEPEST MAUVE

1/4" = 1'-0"



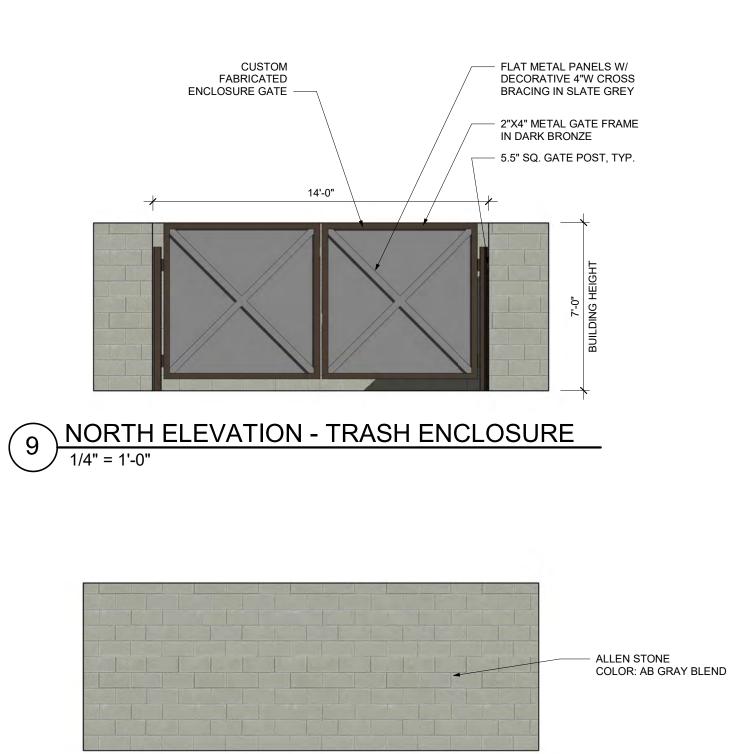

10 SOUTH ELEVATION - TRASH ENCLOSURE


21 OF 27

SHEET TITLE:

ACCESSORY

BUILDINGS

12 WEST ELEVATION - TRASH ENCLOSURE

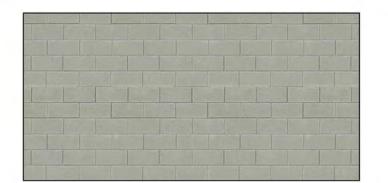







DATE: <u>(SIP 01) 01/10/2020</u> <u>(SIP 02) 04/05/2020</u>



303.806.9140

OWNER: TALL TALES RANCH SUSAN MOONEY 6311 SOUTH GRANT DRIVE CENTENNIAL, CO 80121


ANCH

Ľ

S

AN

Ш NON JOR

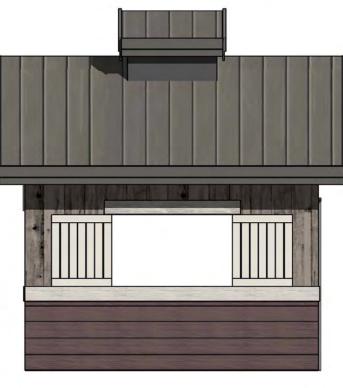









	6" LAP SIDING	BOARD & BATT	VERTICAL SIDING	TRIM	FASCIA	ACCENTS	ASPHALT ROOF	METAL ROOF	MASONRY
EVENT BARN/COFFEE SHOP				1		- H			1222
DEEPEST MAUVE - SW 0005	•				1.4				
LP SMARTSIDE - DEEP GRAIN - TETON			•			1			
DRIFT OF MIST - SW 9166				•					
GAUNTLET GRAY - SW 7019					•		0		
EARL GREY - SW 7660	COFFEE SHOP		J. I.						
GAF - WEATHERED WOOD					- <u>-</u>		•		
AEP SPAN - COOL ZINC GRAY					ti ()			•	
PAIRED 7-PLEX COTTAGES									
GRAY CLOUDS - SW 7658	•								
DRIFT OF MIST - SW 9166		•)		
SNOWBOUND - SW 7004				•					
GAUNTLET GRAY - SW 7019					•				
GAF - WEATHERED WOOD			1						
AEP SPAN - COOL ZACTIQUE II									
		0						je r	
MAIN COTTAGE									
BUNGLEHOUSE BLUE - SW 0048	•					1			
GRAY CLOUDS - SW 7658		•							
SNOWBOUND - SW 7004				•	•	•			
GAF - WEATHERED WOOD							•		
AEP SPAN - COOL SLATE GRAY								•	
						ý -			
ACCESSORY BUILDINGS	/								
DEEPEST MAUVE - SW 0005	•								
P SMARTSIDE - DEEP GRAIN - TETON			•						
DRIFT OF MIST - SW 9166		1		•					
GAUNTLET GRAY - SW 7019	1	- tr				•	1		1
GAF - WEATHERED WOOD							PKG STRUCTURE		
AEP SPAN - COOL SLATE GRAY					1				
ALLEN STONE, AB GREY BLEND				-		-1			TRASH ENCLOSURE

TALL TALES RANCH

4.01 ACRES SIP SP20-02



5975 S. Quebec Street, Suite 250 Centennial, Colorado 80111 ph 303.455.4437 fx 303.477.5680 www.goddensudik.com



OWNER:

TALL TALES RANCH SUSAN MOONEY 6311 SOUTH GRANT DRIVE CENTENNIAL, CO 80121 303.806.9140

NOT FOR CONSTRUCTION

DATE: (SIP 01) 01/10/2020 (SIP 02) 04/05/2020

SHEET TITLE: SITE MATERIAL SCHEDULE



IRRIGATION GENERAL NOTES

- 1. THE CONTRACTOR SHALL PROVIDE ALL LABOR, MATERIALS AND EQUIPMENT NECESSARY TO INSTALL THE IMPROVEMENTS SHOWN ON THE PLANS.
- 2. THE IRRIGATION CONTRACTOR SHALL COORDINATE AS NECESSARY WITH THE GENERAL CONTRACTOR AND OWNER'S REPRESENTATIVE FOR SUCCESSFUL COMPLETION OF THIS WORK.
- 3. THE CONTRACTOR ASSUMES ALL LIABILITY ASSOCIATED WITH THE MODIFICATION OF THE IRRIGATION SYSTEM DESIGN WITHOUT NOTIFYING THE OWNER'S REPRESENTATIVE.
- 4. ALL IRRIGATION EQUIPMENT IS TO BE AS SPECIFIED OR APPROVED EQUAL PER THE DISCRETION OF THE OWNER'S REPRESENTATIVE.
- 5. IT IS THE CONTRACTOR'S RESPONSIBILITY TO CONDUCT A THOROUGH SITE INSPECTION AND REVIEW OF THE PROJECT CONSTRUCTION DOCUMENTS INCLUDING BUT NOT LIMITED TO THE FOLLOWING: LANDSCAPE PLAN, UTILITY PLAN, CIVIL PLAN, GRADING AND DRAINAGE PLAN AND ALL OTHER ASSOCIATED PLANS THAT AFFECT THIS WORK PRIOR TO BEGINNING CONSTRUCTION. IF THE CONTRACTOR OBSERVES ANY DISCREPANCIES AMONG THE CONSTRUCTION DOCUMENTS AND THE EXISTING CONDITIONS ON SITE, IT IS THEIR RESPONSIBILITY TO CONTACT THE OWNER'S REPRESENTATIVE IMMEDIATELY.
- THE CONTRACTOR SHALL CONFORM TO ALL LOCAL AND STATE REGULATIONS AND INSTALL THE IRRIGATION SYSTEM AND ITS COMPONENTS PER THE MANUFACTURER'S SPECIFICATIONS. THE CONTRACTOR SHALL OBTAIN AND PROVIDE PAYMENT FOR ALL PERMITS REQUIRED BY ANY LOCAL AND STATE AGENCIES AND UTILITY COMPANIES HAVING JURISDICTION OVER THIS SITE.
- 7. THE CONTRACTOR IS RESPONSIBLE FOR SCHEDULING AND PAYING FOR TESTING OF THE BACKFLOW PREVENTER BY A STATE CERTIFIED INSPECTOR PER THE UDC AND MOUNTAIN WATER COMPANY GUIDELINES. THE CONTRACTOR SHALL PROVIDE CERTIFICATES TO OWNER'S REPRESENTATIVE.
- 8. THE CONTRACTOR MUST VERIFY THE LOCATION OF ALL UNDERGROUND UTILITIES PRIOR TO CONSTRUCTION. IF THE CONTRACTOR FAILS TO DO SO AND DAMAGES ANY UNDERGROUND UTILITIES THROUGH THE COURSE OF HIS WORK THE CONTRACTOR SHALL PAY FOR ANY REPAIR WORK ASSOCIATED WITH SAID DAMAGES.
- 9. IT IS THE INTENT OF THIS DESIGN THAT ALL IRRIGATION EQUIPMENT BE INSTALLED WITHIN LANDSCAPE AREAS AND WITHIN THE PROJECT LIMITS. EQUIPMENT SHOWN OUTSIDE OF THESE LIMITS IS SHOWN FOR GRAPHIC CLARITY ONLY. IF THERE IS A QUESTION REGARDING THE LOCATION OF ANY COMPONENT OF THE IRRIGATION SYSTEM, IT IS THE CONTRACTOR'S RESPONSIBILITY TO CONTACT THE OWNER'S REPRESENTATIVE. IF THE CONTRACTOR NEGLECTS TO NOTIFY THE NECESSARY PARTIES, THE CONTRACTOR SHALL PAY FOR ANY REPLACEMENT OR MODIFICATION TO INSURE PROPER LOCATION AND OPERATION OF THE IRRIGATION SYSTEM AND ITS COMPONENTS.
- 10. ALL IRRIGATION DISTRIBUTION LINES AND EQUIPMENT INCLUDING BUT NOT LIMITED TO, MAINLINE, LATERALS, SPRAY HEADS, ROTORS, ROTARY SPRAYS, DRIP EMITTERS SHALL BE KEPT A MINIMUM DISTANCE OF 6' AWAY FROM ALL BUILDING AND WALL FOUNDATIONS, OR AS STIPULATED IN THE GEOTECHNICAL REPORT, WHICHEVER IS GREATER.
- 11. ALL VALVE BOXES AND LIDS SHALL BE PLASTIC WITH SELF LOCKING COVERS. LID COLOR TO BE GREEN. INSTALL PER THE CONSTRUCTION DETAILS. DO NOT INSTALL IN PAVED OR TURF GRASS AREAS.
- 12. ALL VALVE BOXES SHALL BE INSTALLED A MINIMUM OF 1'-0" FROM THE EDGE OF PAVED SURFACES AND 3'-0" FROM THE CENTERLINE OF DRAINAGE SWALES OR RETENTION BASINS. THE CONTRACTOR SHALL ADJUST ALL VALVE BOXES TO BE FLUSH FINISH GRADE.
- 13. GROUNDING FOR THE IRRIGATION CONTROLLER IS TO BE INSTALLED PER THE MANUFACTURER'S SPECIFICATIONS AND PER THE AMERICAN SOCIETY OF IRRIGATION CONSULTANTS GUIDELINE 100-2002 FOR EARTH GROUNDING ELECTRONIC EQUIPMENT IN IRRIGATION SYSTEMS FOUND AT www.asic.org/Design_Guides.aspx. FOR TECHNICAL SUPPORT REGARDING THE IRRIGATION CONTROLLER OR GROUNDING PLEASE CONTACT HUNTER INDUSTRIES (800) 733-2823.
- 14. CONTRACTOR SHALL EXTEND SPARE WIRES (1 COMMON AND 2 CONTROL) AT THE END OF ALL MAINLINE BRANCHES SERVING THAT CONTROLLER. COIL 30" LENGTH MIN. OF SPARE WIRES IN A 10" ROUND VALVE BOX.
- 15. CONTROLLER WIRE SHALL BE 14GA MIN. UL APPROVED WIRE, TAPED AND BUNDLED EVERY 10'. CONTRACTOR SHALL USE UL APPROVED WIRE STRIPPER AND WATERPROOF CONNECTIONS AT ALL SPLICES AND CONNECTIONS POINTS.
- 16. CONTRACTOR SHALL INSTALL TRACER WIRE IN ALL PRESSURE MAINLINE TRENCHES. SEE IRRIGATION DETAILS FOR MORE INFORMATION.
- 17. IT IS THE CONTRACTOR'S RESPONSIBILITY TO ENSURE ADEQUATE VERTICAL SEPARATION BETWEEN ALL IRRIGATION DISTRIBUTION LINES AND ALL UTILITIES (EXISTING OR PROPOSED), CONDUIT, STORM WATER COMPONENTS, DRAINS, ETC.
- 18. PLANT MATERIAL LOCATIONS TAKE PRECEDENCE OVER IRRIGATION LINES. COORDINATE INSTALLATION OF IRRIGATION EQUIPMENT SO THAT IT DOES NOT INTERFERE WITH THE PLANTING OF TREES OR OTHER LANDSCAPE MATERIAL INCLUDING PERENNIAL BEDS.
- 19. THE CONTRACTOR SHALL STAKE THE LOCATION OF THE MAINLINE, DRIP IRRIGATION LINES, CONTROL VALVES, GATE VALVES, ETC. AND SCHEDULE A REVIEW WITH THE OWNER'S REPRESENTATIVE PRIOR TO INSTALLATION
- 20. LAYOUT DRIP LATERALS PARALLEL TO TOPOGRAPHY WHEREVER POSSIBLE. STAKE 3/4" DRIP TUBING IN PLACE AT 12" DEPTH AND BURY. INSTALL HOSE END FLUSHABLE TYPE END CAP AT ENDS OF ALL 3/4" POLYETHYLENE DRIP TUBING AND FLUSH THOROUGHLY BEFORE INSTALLING EMITTERS.
- 21. TREES, SHRUBS AND GROUNDCOVER SHALL BE IRRIGATED BY PRESSURE REGULATING SINGLEI-OUTLET EMITTERS, SEE EMITTER SCHEDULE FOR ADDITIONAL INFORMATION.
- 22. CONTRACTOR SHALL FINE TUNE AND ADJUST NOZZLE DIRECTION AND RADIUS TO REDUCE OVERSPARY ONTO PAVING OR HARD SURFACES.
- 23. CONTRACTOR SHALL INSTALL A QUICK COUPLER IN 10" VALVE BOX AT THE END OF ALL BRANCHES OF THE MAINLINE, OR AS SHOWN ON PLANS, FOR WINTERIZATION AND FLUSHING OF MAINLINE.
- 24. THIS IRRIGATION SYSTEM HAS BEEN DESIGNED TO OPERATE DURING EVENING HOURS, WITHIN A 12 HOUR PER NIGHT, 5 NIGHTS PER WEEK WATERING WINDOW. ESTABLISHMENT WATERING WILL REQUIRE UP TO TWICE AS MUCH IRRIGATION FOR A 21 DAY PERIOD. THE DESIGN IS BASED ON THE FOLLOWING PROJECTED WEEKLY APPLICATION RATES AFTER ESTABLISHMENT. THESE FIGURES WILL NEED TO BE ADJUSTED DUE TO SEASONAL CHANGES AND WEATHER CONDITIONS ABOVE AND BELOW THE AVERAGE VALUES UTILIZED
 - SOD BLEND 1.75" PER WEEK PEAK SEASON
- 25. THE CONTRACTOR SHALL PROVIDE A SEASONAL MAINTENANCE SCHEDULE WHICH SHALL BEGIN ON APRIL 15 AND END ON OCTOBER 15 TO INSURE THE EFFICIENCY AND LONGEVITY OF THE IRRIGATION SYSTEM. THE MAINTENANCE SCHEDULE SHALL INCLUDE BUT IS NOT LIMITED TO THE FOLLOWING LIST OF BEST MANAGEMENT PRACTICES:
 - SYSTEM PERFORMANCE AUDIT AT INITIAL START UP.
 - CHECK HEADS FOR COVERAGE AND LEAKAGE.
 - CHECK CONTROLLER PROGRAMMING AND ADJUST FOR SEASONAL CHANGES AS NECESSARY.
 - VERIFY THAT THE WATER SUPPLY AND PRESSURE ARE AS STATED IN THE DESIGN.
 - CERTIFY THE BACKFLOW PREVENTION DEVICE AND SUBMIT TEST RESULTS TO THE PROPERTY MANAGER.
 - PERIODICALLY VERIFY THE THE SENSORS IN THE IRRIGATION SYSTEM ARE OPERATING CORRECTLY.
 - WINTERIZATION PROCEDURES PRIOR TO OCTOBER 15.
 - SPRING START UP PROCEDURES PRIOR TO APRIL 15.

TALL TALES RANCH

A PARCEL OF LAND LOCATED IN THE NORTHWEST QUARTER OF SECTION 23, TOWNSHIP 6 SOUTH, RANGE 67 WEST OF THE SIXTH PRINCIPAL MERIDIAN, CITY OF LONE TREE, COUNTY OF DOUGLAS, STATE OF COLORADO

4.01 ACRES SP20-02

IRRIGATION POINT OF CONNECTION NOTES

. POINT OF CONNECTION: THERE ARE TWO (2) POINTS OF CONNECTION ON THIS PROJECT:

- POC 1 IS LOCATED NEAR THE NORTHEAST CORNER OF THE PARKING LOT, AS SHOWN ON THE PLANS. CONNECT DOWNSTREAM OF THE 1-1/2" DEDICATED IRRIGATION WATER METER (PROVIDED BY OTHERS) WITH 1-1/2" TYPE K COPPER AT A DEPTH OF 48" OR PER LOCAL CODE, WHICHEVER IS GREATER TO THE BACKFLOW PREVENTER ASSEMBLY. INSTALL ONE 1-1/2" FEBCO 825YA BACKFLOW PREVENTER IN A GUARDSHACK ENCLOSURE WITH FROST BLANKET. EXTEND 1 1/2" TYPE K COPPER A MINIMUM 30" BEYOND ENCLOSURE. INSTALL ONE 1-1/2" GATE VALVE. TRANSITION TO AND EXTEND 1-1/2" CL200 PVC MAINLINE TO ONE MANUAL DRAIN VALVE, ONE 1" QUICK COUPLER VALVE, AND EXTEND MAINLINE TO MASTER VALVE AS SHOWN. ALL PIPING FROM METER THROUGH FLOW SENSOR TO BE SAME SIZE AS METER.
- POC 2 IS LOCATED NEAR THE SOUTHWEST CORNER OF THE PARKING LOT, AS SHOWN ON THE PLANS. CONNECT DOWNSTREAM OF THE 1" DEDICATED IRRIGATION WATER METER (PROVIDED BY OTHERS) WITH 1" TYPE K COPPER AT A DEPTH OF 48" OR PER LOCAL CODE, WHICHEVER IS GREATER TO THE BACKFLOW PREVENTER ASSEMBLY. INSTALL ONE 1" FEBCO 825YA BACKFLOW PREVENTER IN A GUARDSHACK ENCLOSURE WITH FROST BLANKET. EXTEND 1" TYPE K COPPER A MINIMUM 30" BEYOND ENCLOSURE. INSTALL ONE 1" GATE VALVE. TRANSITION TO AND EXTEND 1" CL200 PVC MAINLINE TO ONE MANUAL DRAIN VALVE. ONE 1" QUICK COUPLER VALVE. AND EXTEND MAINLINE TO MASTER VALVE AS SHOWN. ALL PIPING FROM METER THROUGH FLOW SENSOR TO BE SAME SIZE AS METER.
- THE CONTRACTOR SHALL CONFORM TO ALL LOCAL CODES, OBTAIN AND PROVIDE PAYMENT FOR ALL PERMITS ASSOCIATED WITH THIS WORK. FINAL LOCATION OF BACKFLOW PREVENTERS SHALL BE APPROVED BY THE OWNER'S REPRESENTATIVE PRIOR TO INSTALLATION.
- 2. CONTROLLER LOCATION: THE HUNTER ACC2 CONTROLLER IS TO BE WALL MOUNTED ON THE NORTH WALL OF THE BUILDING IN THE NORTHEAST CORNER OF THE PROJECT, AS INDICATED ON THE PLANS. CONTRACTOR TO COORDINATE WITH OWNER'S REPRESENTATIVE AND THE MECHANICAL AND ELECTRICAL PLANS FOR POWER SERVICE. ALL ELECTRICAL EQUIPMENT AND POWER CONNECTION INSTALLATION SHALL CONFORM TO ALL LOCAL CODES.
- SENSORS: MOUNT THE SOLAR SYNC RAIN/FREEZE SENSOR ON THE FASCIA OR GUTTER OF THE BUILDING ADJACENT TO THE CONTROLLER. THE SENSOR SHALL BE MOUNTED IN A LOCATION IN FULL SUN AND OPEN TO RAINFALL. SENSOR SHALL BE NO MORE THAN 200' FROM WIRELESS RECEIVER. MOUNT WIRELESS RECEIVER ON OR ADJACENT TO THE IRRIGATION CONTROLLER
- 4. FINAL BACKFLOW PREVENTER, IRRIGATION CONTROLLER, SENSOR LOCATION AND SENSOR MOUNTING SYSTEM TO BE APPROVED BY THE OWNER'S REPRESENTATIVE PRIOR TO INSTALLATION.
- 5. SYSTEM PRESSURE: THE SYSTEM HAS BEEN DESIGNED FOR A REQUIRED MINIMUM STATIC PRESSURE OF 70 PSI AND MAXIMUM SAFE FLOW OF 35 GPM IN POC 1; 16 GPM IN POC 2. THE CONTRACTOR IS RESPONSIBLE FOR VERIFYING THE PRESSURE IN THE FIELD AT THE POINT OF CONNECTION BEFORE CONSTRUCTION BEGINS AND FOR NOTIFYING THE OWNER'S REPRESENTATIVE OF ANY DISCREPANCY BETWEEN THE DESIGN PRESSURE OF THE SYSTEM AND THE MEASURED PRESSURE IN THE FIELD. IF THE CONTRACTOR FAILS TO NOTIFY OWNER'S REPRESENTATIVE OF SUCH DISCREPANCIES, THEN THE CONTRACTOR ASSUMES ALL LIABILITY AND COSTS ASSOCIATED WITH SYSTEM MODIFICATIONS TO ACCOMMODATE THE ACTUAL PRESSURE
- 6. MASTER VALVE FLOW SENSOR: THE HUNTER MASTER VALVE REQUIRES A MINIMUM FLOW OF 0.2 GPM TO FUNCTION PROPERLY. THE HUNTER FLOW SENSOR REQUIRES A MINIMUM FLOW OF 2.0 GPM FOR PROPER FUNCTION. MULTIPLE DRIP ZONES MAY BE REQUIRED TO RUN AT THE SAME TIME TO ACHIEVE THE MINIMUM FLOWS REQUIRED. MAXIMUM FLOW VELOCITY IN ANY PVC PIPE IS NOT TO EXCEED 5 FPS.

SLEEVING COORDINATION NOTES

INSTALLATION OF IRRIGATION SLEEVING IS THE RESPONSIBILITY OF THE GENERAL CONTRACTOR.

- 2. SLEEVES SHALL BE INSTALLED PRIOR TO THE START OF PAVING OPERATIONS. THE GENERAL CONTRACTOR SHALL COORDINATE WITH THE IRRIGATION CONTRACTOR FOR LOCATION AND SIZING OF SLEEVES PRIOR TO THE START OF CONSTRUCTION. 3. THE CONTRACTOR SHALL SLEEVE ALL IRRIGATION DISTRIBUTION LINES, VALVE CONTROL WIRES AND COMMUNICATION WIRES
- UNDER ALL PAVED SURFACES, WALL FOOTERS, DRAINAGE CHANNELS, INLETS, CATCH BASINS, ETC. 4. ALL SLEEVES SHALL EXTEND A MINIMUM OF 1 FOOT BEYOND EDGE OF ALL OBSTRUCTIONS. NO TEES, ELLS OR OTHER TURNS IN
- PIPING SHALL BE LOCATED UNDER ANY OBSTRUCTIONS. MARK CURB OR PAVING WITH 2" 'X' AT SLEEVE LOCATIONS.
- 5. SLEEVING SHALL BE INSTALLED PER THE PLANS BASED ON THE CHART BELOW. ALL MAINLINE, VALVE CONTROL AND COMMUNICATION WIRES. LATERALS AND 3/4" POLYETHYLENE DRIP TUBING UNDER PAVED SURFACES ARE TO BE INSTALLED IN SEPARATE SLEEVING.
 - SLEEVED PIPE SIZE/WIRE QTY

CONTROL WIRES

ALL PIPING

REQUIRED SLEEVE SIZE AND QTY 3" PVC (1) 3" PVC (1)

PARKER TEMPORARY IRRIGATION NOTES

1. TEMPORARY IRRIGATION IS REQUIRED OVER ALL AREAS WHERE PERMANENT NATIVE SEEDING IS PROPOSED. THIS INCLUDES. BUT IS NOT LIMITED TO: DETENTION PONDS, DRAINAGEWAYS, PARK AND TRAIL AREAS, GENERAL OPEN SPACE, ETC.

- WHEN WORKING WITHIN PARKER WATER AND SANITATION DISTRICT'S (PWSD) JURISDICTION, THE FOLLOWING IS REQUIRED: • TEMPORARY IRRIGATION FOR NATIVE SEED MUST BE SUPPLIED BY A FIRE HYDRANT HOOK-UP. USE OF PROPOSED/EXISTING LANDSCAPE IRRIGATION TAPS IS NOT ALLOWED. PLEASE INDICATE ON THE IRRIGATION PLANS FIRE HYDRANTS THAT ARE TO BE USED FOR THE TEMPORARY IRRIGATION MAINLINE AND PROVIDE A DETAIL FOR THE CONNECTION. THIS DETAIL SHOULD SHOW THE HYDRANT, PRV, PWSD WATER METER, A 2" BACKFLOW ASSEMBLY, A 2" X 2" CAM LOCK FOR FIRE DEPARTMENT QUICK DISCONNECT AND A SUPPORT SYSTEM FOR ALL COMPONENTS
- THE FOLLOWING NOTE MUST BE SHOWN ON THE IRRIGATION PLAN SET "TEMPORARY IRRIGATION FOR ESTABLISHMENT OF NATIVE VEGETATION MUST BE INSTALLED ABOVE GROUND. AND REMOVED IMMEDIATELY AFTER ESTABLISHMENT IS COMPLETE, OR IN NO CASE, ANY LONGER THAN ONE GROWING SEASON." PWSD MAY ALLOW TEMPORARY IRRIGATION TO CONTINUE FOR ONE ADDITIONAL GROWING SEASON WITH PRIOR APPROVAL
- THE FOLLOWING NOTE MUST BE SHOWN ON THE IRRIGATION PLAN SET "ALL TEMPORARY IRRIGATION COMPONENTS INCLUDING BUT NOT LIMITED TO MAINLINES. LATERALS. VALVES. HEADS AND QUICK COUPLERS MUST BE INSTALLED ABOVE GROUND."
- ALL TEMPORARY IRRIGATION COMPONENTS INCLUDING BUT NOT LIMITED TO MAINLINES, LATERALS, VALVES, HEADS AND QUICK COUPLERS MUST BE CLEARLY LABELED ON THE PLANS.
- PROVIDE DETAIL DRAWINGS FOR ALL ABOVE GROUND COMPONENTS INCLUDING BUT NOT LIMITED TO MAINLINES. LATERALS, VALVES, HEADS AND QUICK COUPLERS.

	NATIVE SEED	
SYMBOL	DESCRIPTION	IRRIGATION APPLICATION
	IRRIGATED SEED	NATIVE SEED AREAS SHOWN ON IRRIGATION PLANS SHALL BE TEMPORARILY IRRIGATED PER THE PARKER TEMPORARY IRRIGATION NOTES.
	IRRIGATED NO-MOW GRASS	NATIVE NO-MOW GRASS AREAS SHALL BE PERMANENTLY IRRIGATED WITH 12" POP-UP ROTARIES AT APPROXIMATELY 50% OF HEAD-TO-HEAD COVERAGE.
	EMITTER NOTES	
1. ALL PLANT MATERIAL SHA	ALL BE IRRIGATED W/ RAIN BIRD XB SERI	ES PRESSURE REGULATING EMITTERS.

1		
	SYMBOL	DESCRI
		POINT

POC 1 POC 2	CONNE
M1 M2	IRRIGA MET
1	BACKF PREVEI
NOT	SECU
SHOWN	ENCLO
C	CONTRO
RS	RAIN SE
	MANU DRAIN V
0	QUIC
×	GATE V
Ø	MAST VALV FLO SENS
•	VAL ASSEN TUF
\oplus	VAL ASSEN
	DRI AIR / VA
æ	RELIEF
 ⑧ ⑧ ● ● ● ■ ● ●	TURF S 8'-1
R-VAN 14 C-VAN 14 360 R-VAN 18 R-VAN 18 R-VAN 18 360 R-VAN 24 C	TURF RC SPR 10'-2
R-VAN 24 360 R-VAN14 R-VAN18 R-VAN24 R-VAN24 R-VAN14-360 R-VAN18-360 R-VAN24-360 R-VAN24-360	NATI GRA ROTA SPR 10'-2
	SLEEV
	SERVICI
 	MAINLI MAINLI
	SPRA
	LATEF DRI
	LATEI END (
	VALVE C
# - X"	X

1/4" DISTRIBUTION TUBING NOT TO EXCEED 8' IN LENGTH.

3. RAIN BIRD DBC-025 DIFFUSER BUG CAP AND TS-025 STAKE ON ALL 1/4" DISTRIBUTION TUBING

IRRIGATION SCHEDULE

JN S	SCHED	ULE			
IPTION	MFR	MODEL NO.		COMMENTS	DETAIL
T OF CTION	NA	1-1/2" Dedicated Irrigation W 1" Dedicated Irrigation Water		Refer to Civil Site and Utility Plan	
ATION Fer	NA	1-1/2" Dedicated Irrigation W 1" Dedicated Irrigation Water	ater Meter	Refer to Civil Utility and Water Plans	
FLOW ENTER	FEBCO	POC 1: 1-1/2" Backflow Prev POC 2: 1" Backflow Prevente	· · ·	In Guardshack Enclosure	25- D1
irity)Sure	GUARD- SHACK	Lift-off Enclosure (GS-1) 10"W X 24"H X 22"L		Color: Green	25- D2
ATION OLLER	HUNTER	Automatic ACC2 Controller (Expansion Modules (A2M-60	,	Metal Cabinet Wall Mount 19 Valves	25- D3
ENSOR	HUNTER	Rain/Freeze Sensor (WSS-S Wireless	EN)	Mount Adjacent to Controller on Bldg.	25- D4
UAL VALVE	WATTS	Carson Round Valve Box (91 1" Bronze Gate Valve (WGV-	,		25- D7
ICK PLER	RAIN BIRD	Carson Round Valve Box (91 1" Coupler (LRC-44)			25- D9
VALVE	WATTS	Carson Round Valve Box (91 Bronze Gate Valve (WGV-X)	,	Size per line size Threaded ends	25- D8
TER VE / DW SOR	HUNTER	(2) Carson Standard Valve B Sch. 80 PVC Ball Valve 1-1/2, 1" Control Valve (ICV-7 POC 1: 1-1/2"FLOW-SYNC F w/ 1-1/2" FCT Fitting (FCT-1 POC 2: 1" FLOW-SYNC Flow w/ 1" FCT Fitting (FCT-100)	151G, ICV-101G) Flow Sensor (HST) 50)	2 - 35 GPM Range Size per POC	26- D2
_VE MBLY RF	RAIN BIRD	Carson Jumbo Valve Box (12 Sch. 80 PVC Ball Valve Per V 1",1-1/2" Control Valve (ICV-	Valve Size		26- D3
LVE MBLY SIP	RAIN BIRD	Carson Jumbo Valve Box (13 1" Sch. 80 PVC Ball Valve 1" Drip Control Zone Kit (ICZ-		Operate at 25 psi	26- D4
ACUUM VALVE	CRISPIN	Carson Round Valve Box (91 1" Sch. 80 PVC Ball Valve Air and Vacuum Valve (AL-Se	0)	Locate at high point of mainline. Size per Manufacturer's Recommendation for Mainline Length.	26- D1
SPRAY 10' OTARY RAY 24'	RAIN BIRD	Turf Spray (RD-06-S-P30) 8/10 Series MPR and Variab 6.0" Pop-Up Riser Seal-A-Matic check valve In-stem pressure regulating t 1/2" inlet. Turf Rotary (RD-1800-P45) 14/18/24 R-Van Nozzles - Ac 6.0" Pop-Up Riser Seal-A-Matic Check Valve In-stem pressure regulating t 1/2" inlet.	o 30 psi lj./360 (Full)	Matched precipitation rate:1.6"/hr @ 30 psi SA series pre-assembled swing-joints sized per inlet. Matched precipitation rate: 0.6"/hr@ 45 psi SA series pre-assembled swing-joints sized per inlet.	26- D5 26- D5
TVE ASS ARY RAY 24'	RAIN BIRD	Shrub Rotary (RD-1800-P45) 14/18/24 R-Van Nozzles - Ad 12.0" Pop-Up Riser Seal-A-Matic Check Valve In-stem pressure regulating t 1/2" inlet.	lj./360 (Full)	Matched precipitation rate: 0.6"/hr@ 45 psi SA series pre-assembled swing-joints sized per inlet.	26- D5
VING	NA	Class 200 PVC		See Sleeving Notes	25- D5
E LINE	NA	POC 1: 1-1/2" Type K Coppe POC 2: 1" Type K Copper Pip	pe	POC to Backflow	25- D6
INE 1 INE 2	NA	1-1/2" Class 200 BE PVC Pip 1" Class 200 BE PVC Pipe All Mainline to have tracer wi		Unless otherwise noted on the plan	25- D6
AY RAL	NA	3/4" Class 200 PVC Pipe		Unless otherwise noted on the plan	25- D6
RIP RAL	NA	3/4" Polyethylene Drip Tubing	g		25- D6
CAP	NA	Carson 910 Round Valve Bo Poly Hose Flush End Cap	X		27- D1
			MITTER SCHEDUL		
-	Station Number esignation:	PLANT TYPE	EMITTER RATE	# EMITTERS	
D(Drip),	, G(Turf),	PERENNIALS		BUBBLERS	
N (Nativ	ve Grass)	ORNAMENTAL GRASSES	0.5 GPH	ONE EACH	
		DECIDUOUS SHRUBS	0.5 GPH	TWO EACH	
	low: (GPM)	EVERGREEN SHRUBS	0.5 GPH	TWO EACH	
Valve S	bize	DECIDUOUS TREE	1.0 GPH	SIX EACH	
		EVERGREEN TREE	1.0 GPH	SIX EACH	

))))))**NORRIS DESIGN**

1101 Bannock Street Denver, Colorado 80204 P 303.892.1166 www.norris-design.com




OWNER:

TALL TALES RANCH SUSAN MOONEY 6311 SOUTH GRANT DRIVE CENTENNIAL, CO 80121 303.806.9140

NOT FOR CONSTRUCTION

DATE: (SIP 01) 01/10/2020 (SIP 02) 04/05/2020



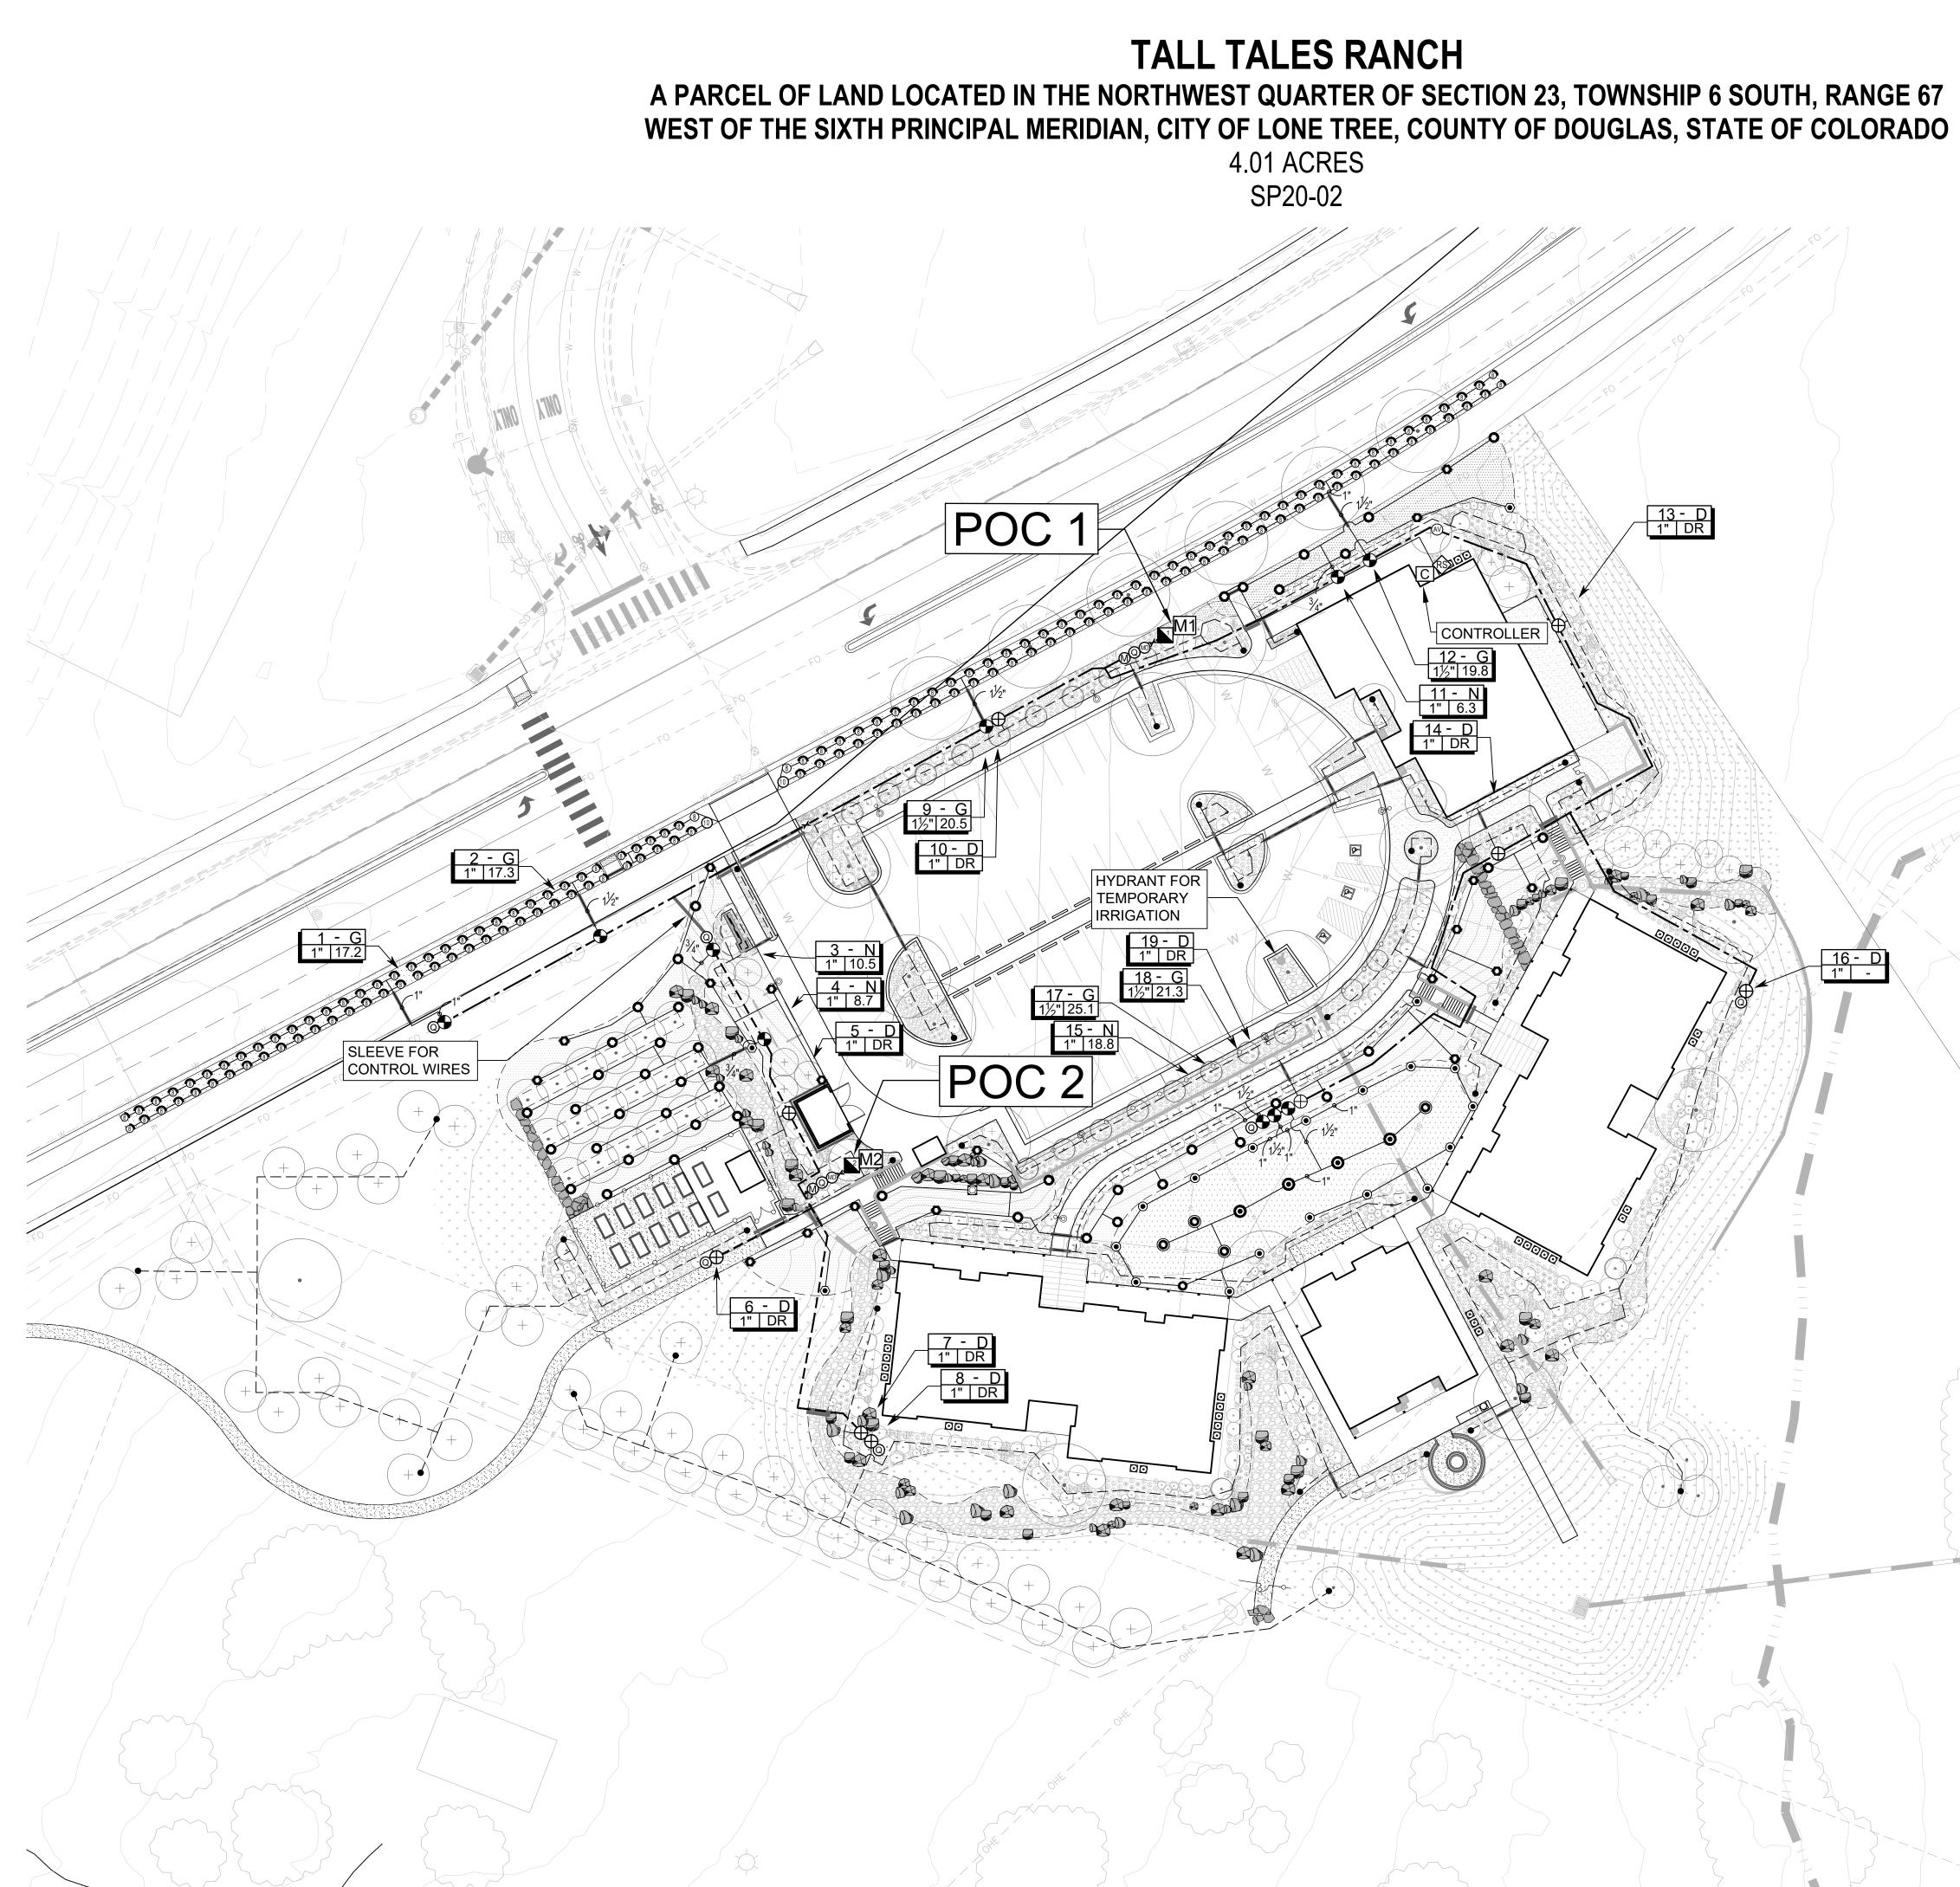



1101 Bannock Street Denver, Colorado 80204 P 303.892.1166 www.norris-design.com




OWNER:


TALL TALES RANCH SUSAN MOONEY 6311 SOUTH GRANT DRIVE CENTENNIAL, CO 80121 303.806.9140

NOT FOR CONSTRUCTION

DATE: <u>(SIP 01) 01/10/2020</u> (SIP 02) 04/05/2020

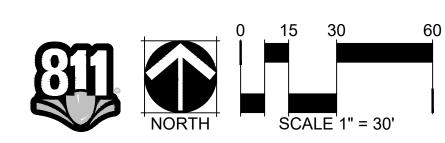

SHEET TITLE: IRRIGATION PLAN

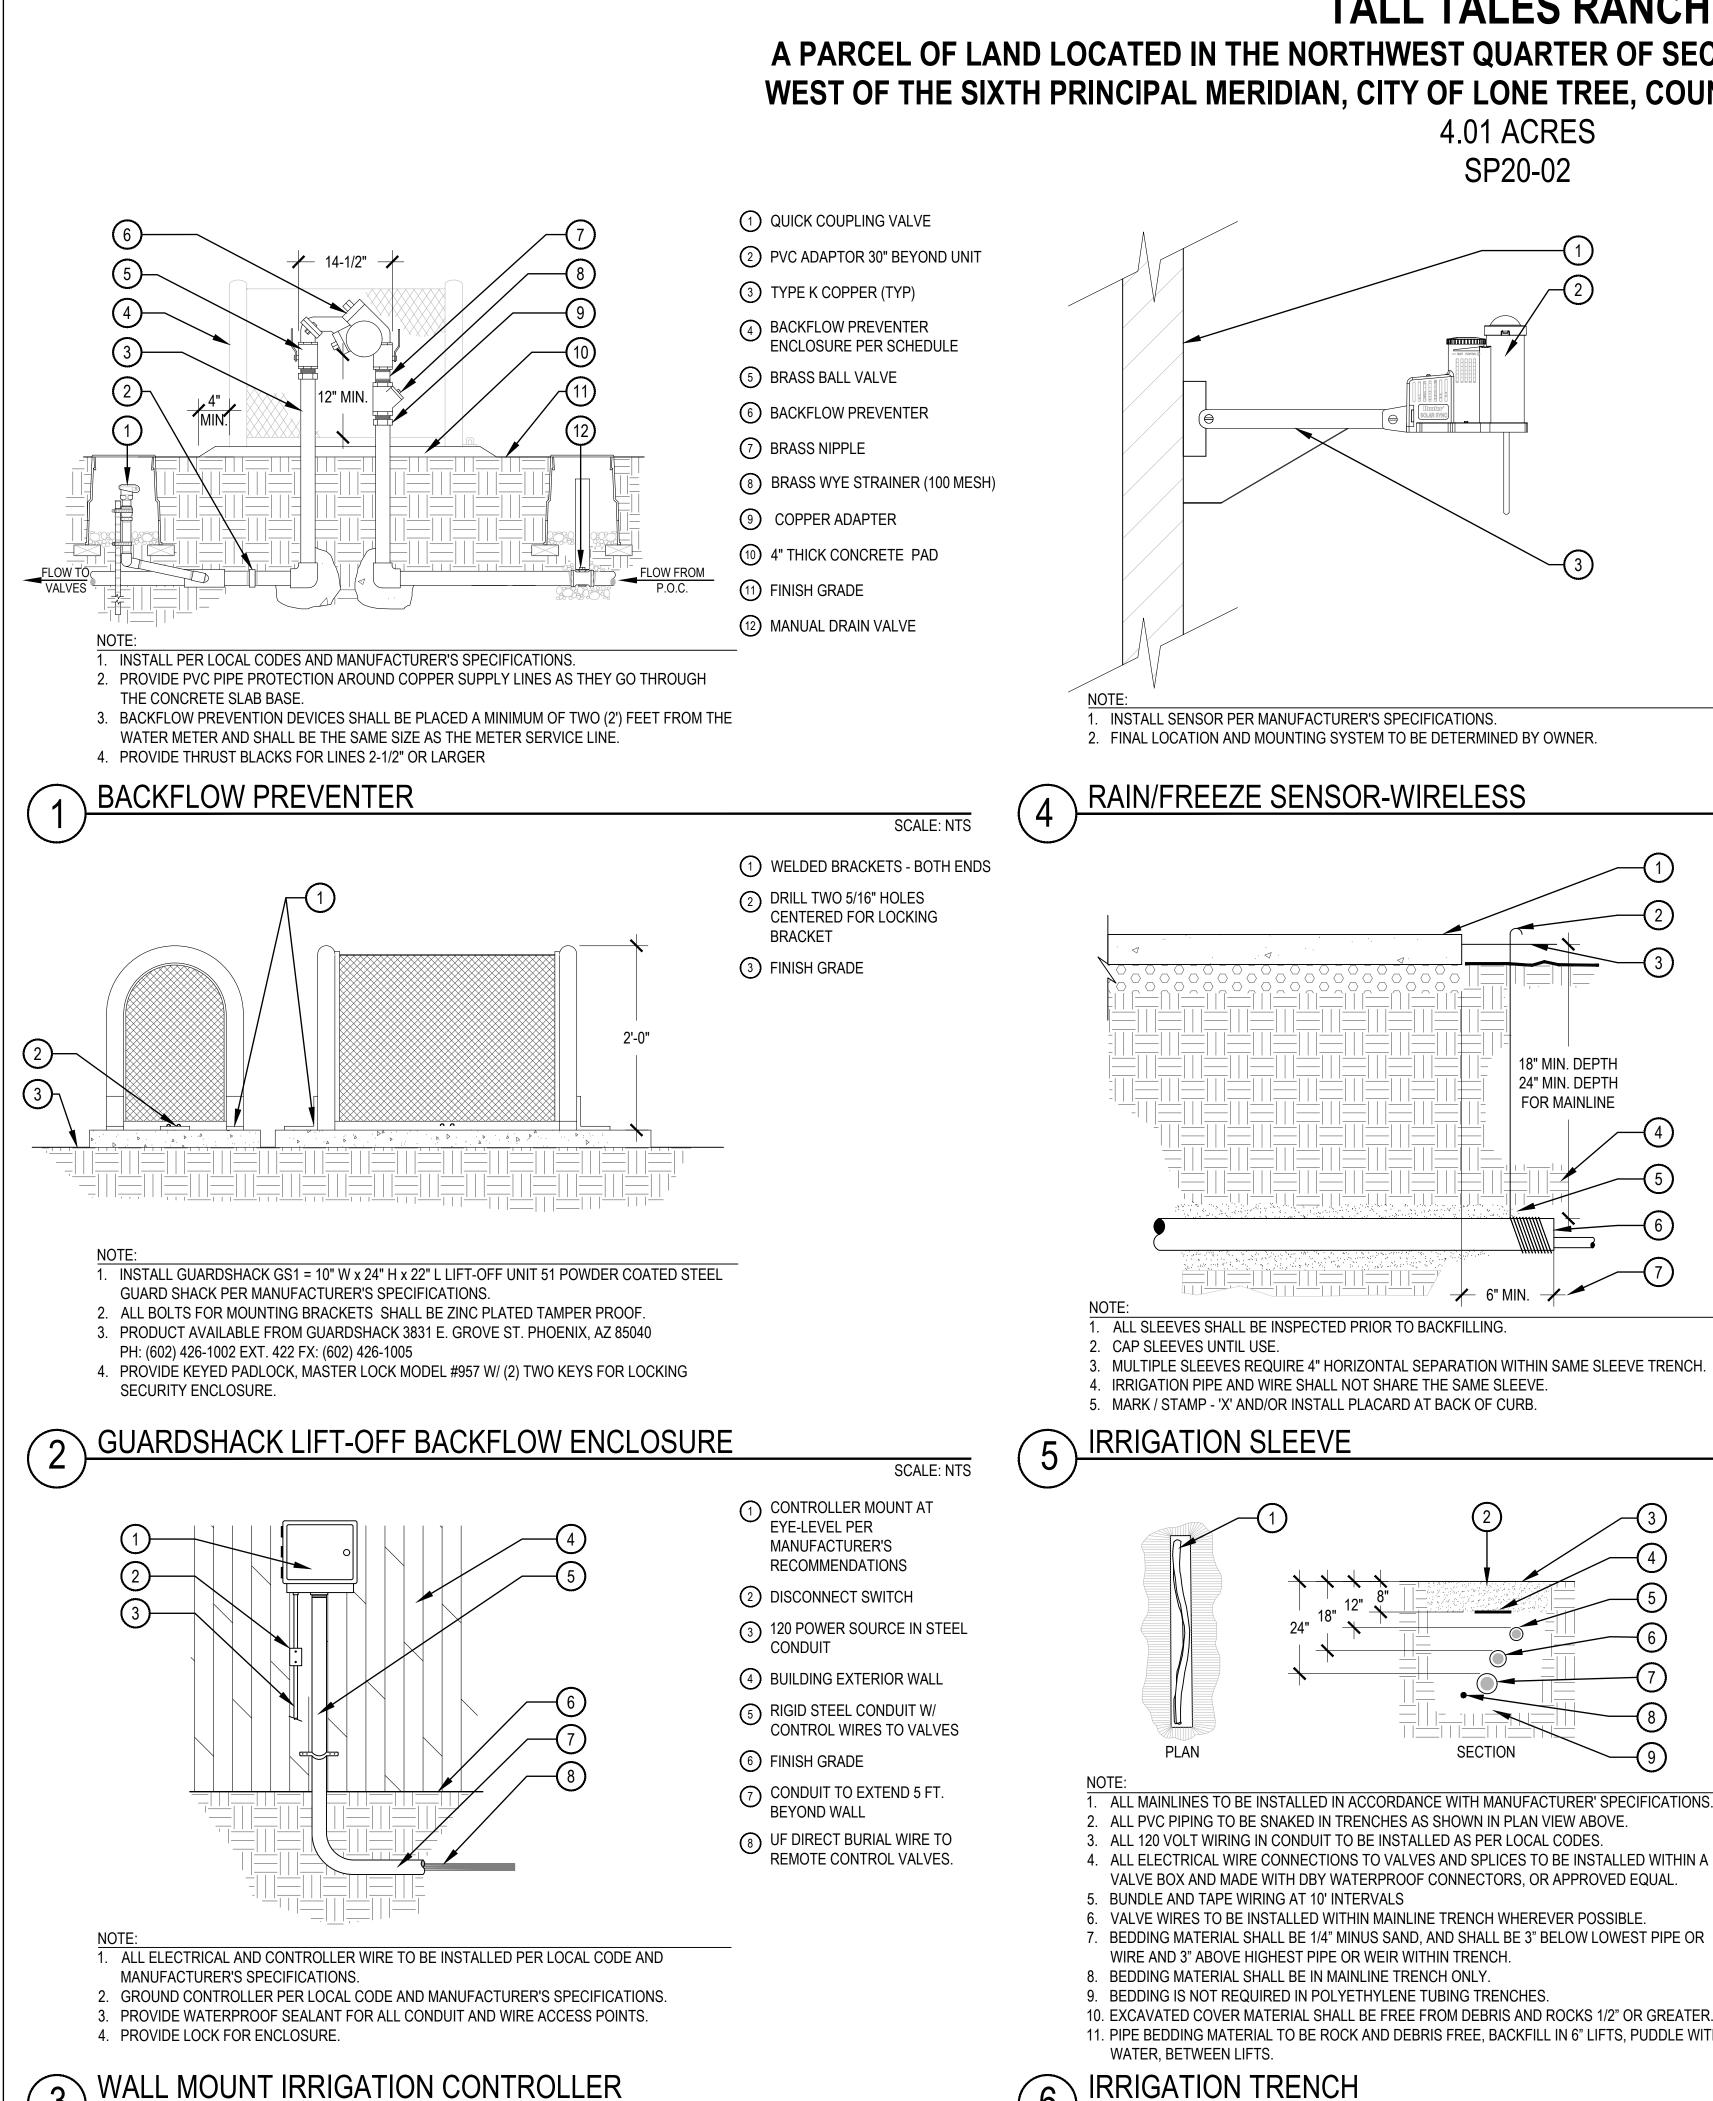

MS CHECKED BY DRAWN BY:


SCALE: NTS

6

TALL TALES RANCH

A PARCEL OF LAND LOCATED IN THE NORTHWEST QUARTER OF SECTION 23, TOWNSHIP 6 SOUTH, RANGE 67 WEST OF THE SIXTH PRINCIPAL MERIDIAN, CITY OF LONE TREE, COUNTY OF DOUGLAS, STATE OF COLORADO

- (1) SUITABLE FASCIA, WALL, OR GUTTER MOUNT. MOUNT IN LOCATION WHERE SENSOR CAN RECEIVE FULL SUN, IS OPEN TO RAINFALL AND OUT OF SPRINKLER SPRAY PATTERN (2) SENSOR 200' MAX. FROM
- CONTROLLER
- 3 MOUNTING BRACKET PER MANUFACTURER

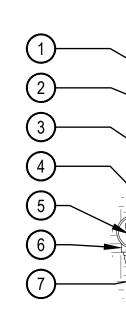

- 1. ALL MAINLINES TO BE INSTALLED IN ACCORDANCE WITH MANUFACTURER' SPECIFICATIONS. (7) IRRIGATION MAINLINE
- 4. ALL ELECTRICAL WIRE CONNECTIONS TO VALVES AND SPLICES TO BE INSTALLED WITHIN A

- 11. PIPE BEDDING MATERIAL TO BE ROCK AND DEBRIS FREE, BACKFILL IN 6" LIFTS, PUDDLE WITH

IRRIGATION TRENCH

SCALE: NTS

- 1 PAVING
- (2) WRAP 12 GAUGE GALVANIZED WIRE AROUND EACH END OF SLEEVE (10 WRAPS MIN.) AND EXTEND TO SURFACE AS A LOCATING DEVICE.
- (3) FINISH GRADE / TOP OF DG.
- (4) COMPACT SOIL AROUND SLEEVE TO SAME DENSITY AS ADJACENT UNDISTURBED SOIL.
- 5 WASHED AND GRADED MORTAR SAND BACKFILL IN ROCKY SOIL CONDITIONS.
- 6 PVC SLEEVE PER SCHEDULE. TWICE DIAMETER OF THE SUM OF THE PIPES/ WIRES
- 7 EXTEND SLEEVES 6" BEYOND EDGES OF PAVING

ЩК

- UNDISTURBED SUBGRADE.
- 3. PROVIDE GATE VALVE KEY LENGTH AS REQUIRED.

GATE VALVE 3" & SMALLER 8

1 SNAKE PVC OR POLYETHYLENE PIPE IN TRENCH

SCALE: NTS

- 2 EXCAVATED COVER MATERIAL (SEE NOTES)
- 3 FINISH GRADE
- INDICATOR TAPE (MAIN LINE)
- 5 POLYEHTELENE DRIP LATERAL (12" MIN. COVERAGE, 18" MIN. COVERAGE BELOW PEDESTRIAN WALKS.)
- 6 IRRIGATION SUB-MAIN LATERAL
- 8 VALVE WIRING
- (9) BEDDING MATERIAL (SEE NOTES)

- NOTE:

- UNDISTURBED SUBGRADE.


SCALE: NTS

9






1101 Bannock Street Denver, Colorado 80204 P 303.892.1166 www.norris-design.com

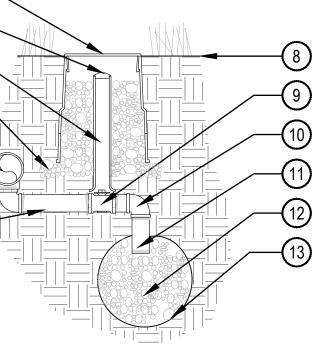


1. ALL THREADED CONNECTIONS SHALL BE COATED WITH TEFLON TAPE 2. LOCATE DRAIN VALVE AT POINT OF CONNECTION AND AT ALL LOW POINT(S) ALONG THE IRRIGATION MAINLINE AS NEEDED.

MANUAL DRAIN VALVE

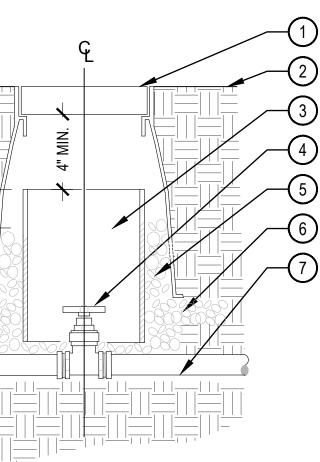

1. COMPACT SOIL AROUND GATE VALVE ASSEMBLY TO THE SAME DENSITY AS ADJACENT

2. DO NOT REST VALVE BOX OR ACCESS SLEEVES ON MAINLINE OR LATERAL LINE.

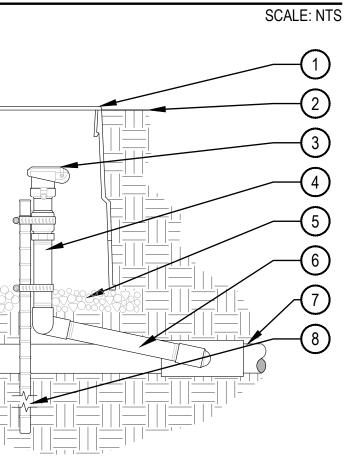

- 1. EACH QUICK COUPLER SHALL BE IN A SEPARATE VALVE BOX
- 2. PROVIDE (1) QUICK COUPLER KEY FOR EACH QUICK COUPLER VALVE. 3. QUICK COUPLER SHALL HAVE YELLOW LOCKING RUBBER COVER
- 4. COMPACT SOIL AROUND GATE VALVE ASSEMBLY TO THE SAME DENSITY AS ADJACENT
- 5. ALL THREADED CONNECTIONS SHALL BE COATED WITH TEFLON TAPE.
- **\ QUICK COUPLER**

- 1 10" LOCKING ROUND BOX & COVER PER SCHEDULE. TOP OF BOX TO BE FLUSH WITH FINISH GRADE.
- 2 2" VALVE MARKER
- 3 2" CL160 PVC ACCESS SLEEVE LENGTH AS REQUIRED.
- (4) 3" DEPTH 3/4" CRUSHED GRAVEL 6" BEYOND EDGE OF BOX
- 5 PVC PRESSURE MAIN LINE
- 6 SCH. 80 TEE PER MAINLINE SIZE. ALIGN IN A DOWNWARD POSITION
- (7) SCH. 80 PVC NIPPLE
- (8) FINISH GRADE
- (9) 1" BRONZE STOP VALVE WITH SLOTTED KEY OPERATOR
- (10) SCH. 80 PVC ELL
- (11) SCH. 80 PVC NIPPLE
- (12) 3/4" GRAVEL SUMP 1 CU. FT. MIN
- (13) SOIL BLANKET ENCLOSING SUMP AMOCO ENG. FABRIC 4545 - 4.5 OZ. OR EQUAL

SCALE: NTS

- 1 LOCKING ROUND BOX & COVER PER SCHEDULE. TOP OF BOX TO **BE FLUSH WITH FINISH GRADE**
- (2) FINISH GRADE
- 3 2" CL160 PVC ACCESS SLEEVE LENGTH AS REQUIRED.
- (4) GATE VALVE W/ CROSS HANDLE AND SOLID WEDGE DISC PER SCHEDULE
- 5 3/4" GRAVEL SUMP FILL IN AND AROUND BOX AS REQUIRED.
- 6 3" DEPTH 3/4: GRAVEL EXTEND 6" BEYOND EDGE OF BOX
- (7) PVC MAINLINE AS PER PLAN




OWNER:

TALL TALES RANCH SUSAN MOONEY 6311 SOUTH GRANT DRIVE CENTENNIAL, CO 80121 303.806.9140

- (1) 6" ROUND BOX & COVER PER SCHEDULE. TOP OF BOX TO FLUSH WITH FINISH GRADE
- 2 FINISH GRADE
- 3 QUICK COUPLING VALVE W/ LOCKING COVER PER SCHEDULE
- 4 SCH. 80 NIPPLE
- 5 3" DEPTH 3/4" GRAVEL BASE
- EXTEND 6" BEYOND EDGE OF BOX
- 6 1" PVC SWING JOINT
- 7 PVC MAINLINE
- (8) 24" #4 REBAR TO HOLD COUPLER IN PLACE W/ (2) STAINLESS STEEL CLAMPS

DATE: <u>(SIP 01) 01/10/2020</u> (SIP 02) 04/05/2020

> SHEET TITLE: IRRIGATION DETAILS

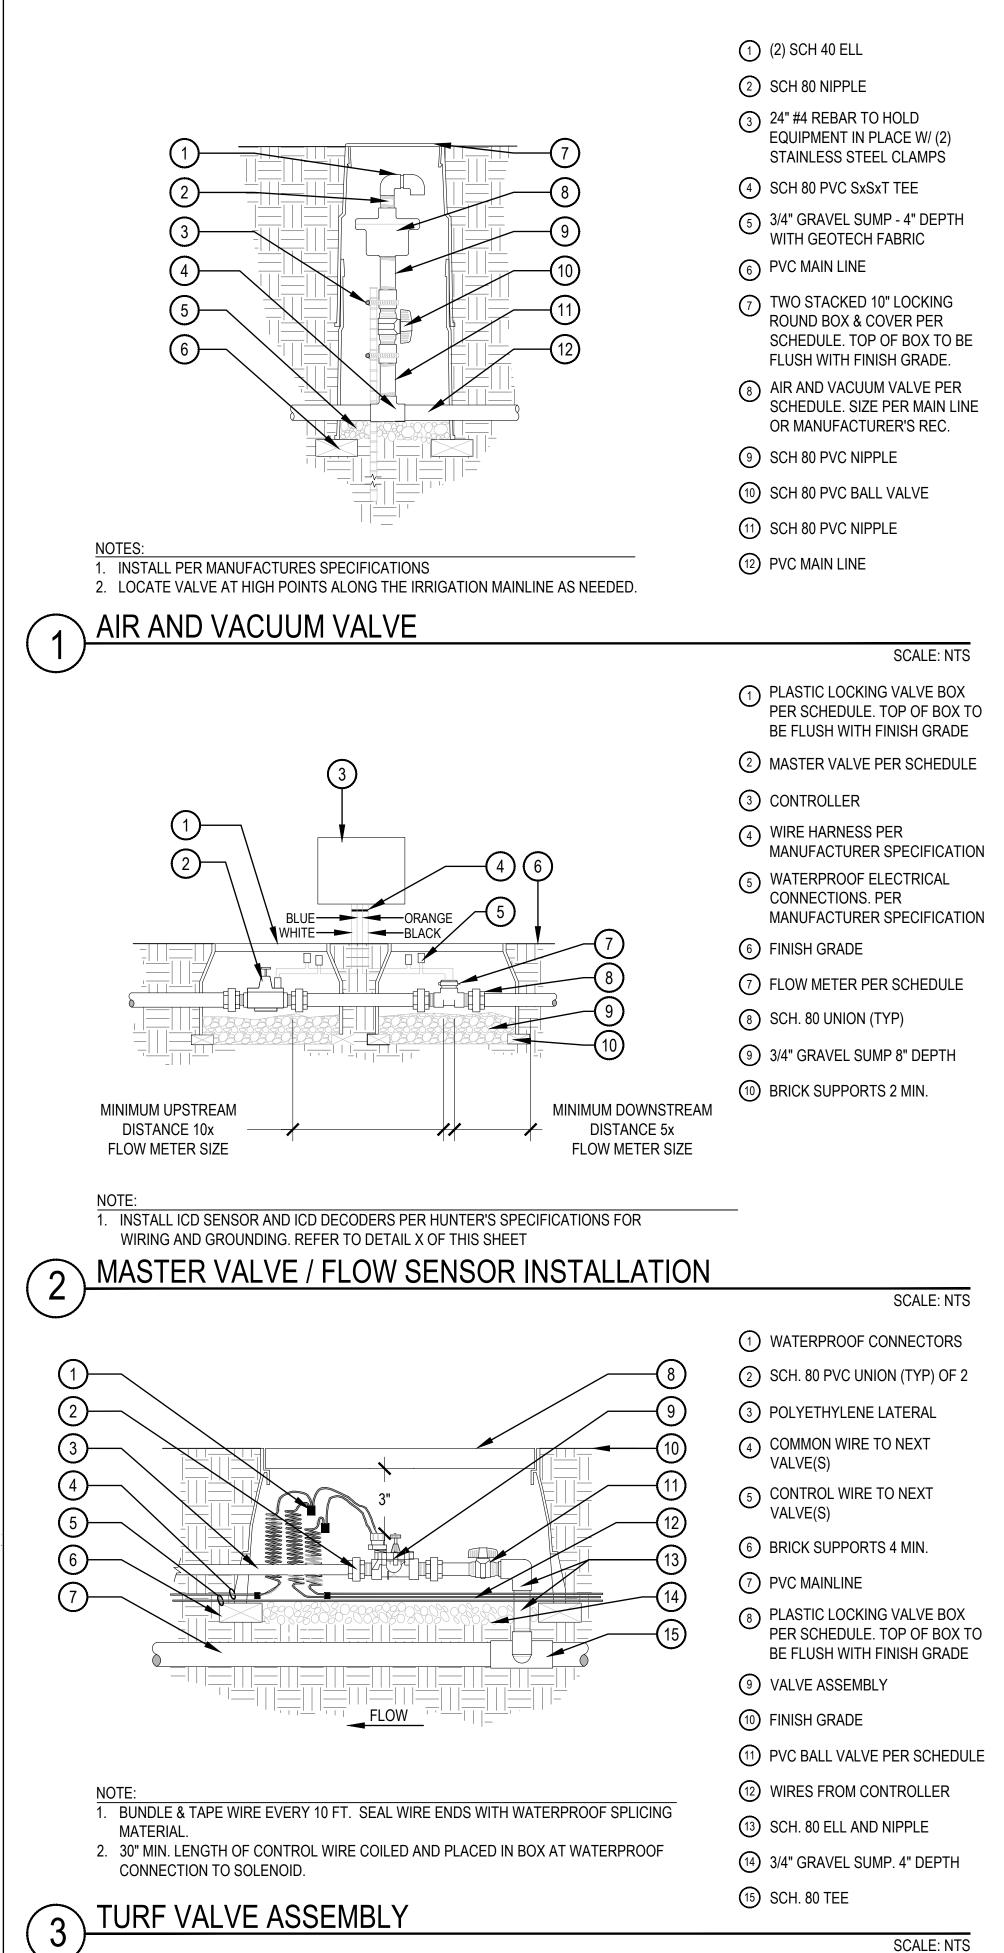

MS

CHECKED BY DRAWN BY:

NOTE

(6)


CONNECTION TO SOLENOID.


DRIP VALVE ASSEMBLY

MIN.

6

5

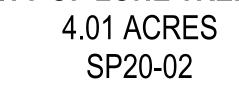

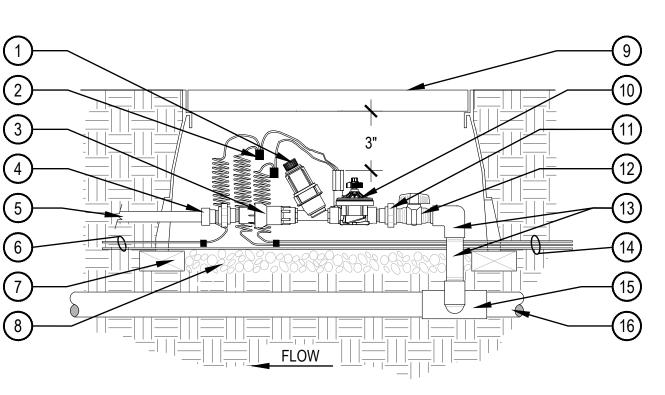

2. 30" MIN. LENGTH OF CONTROL WIRE COILED AND PLACED IN BOX AT WATERPROOF

- (1) WYE FILTER PER SCHEDULE
- ② WATERPROOF CONNECTORS
- (3) PRESSURE REGULATOR PER SCH.
- 4 PVC TO POLY ADAPTER
- 5 3/4" POLY DRIP LATERAL
- 6 COMMON AND CONTROL WIRE TO NEXT VALVE(S)
- 7 BRICK SUPPORTS 4 MIN.
- (8) 3/4" GRAVEL SUMP. 4" DEPTH
- (9) PLASTIC LOCKING VALVE BOX PER SCHEDULE. TOP OF BOX TO BE FLUSH WITH FINISH GRADE
- (10) CONTROL VALVE

1 FINISH GRADE

4 PVC LATERAL PIPE

THREADED

5 PVC SCH. 40 TEE OR ELL,

6 EDGE OF PAVING OR HEADER

1 UNIVERSAL 1/4" TUBING STAKE

LENGTH NOT TO EXCEED 8'

2 DBC-25 DIFFUSER CAP

4 TOP OF MULCH

5 FINISH GRADE

SCHEDULE

(3) 1/4" DISTRIBUTION TUBING:

6 PRESSURE COMPENSATING EMITTER PER EMITTER

(7) 3/4" POLYETHYLENE TUBING DEPTH PER DETAIL


- (1) SCH. 80 PVC UNION (TYP.) OF 2
- (12) PVC BALL VALVE PER SCHEDULE
- (13) SCH. 80 ELL AND NIPPLE
- 1. BUNDLE & TAPE WIRE EVERY 10 FT. SEAL WIRE ENDS WITH WATERPROOF SPLICING MATERIAL. (14) WIRES FROM CONTROLLER
 - (15) SCH. 80 PVC TEE

2 POP-UP SPRAY SPRINKLER PER SCHEDULE

3 FLEXIBLE SWING JOINT - 18" MAX




SCALE: NTS

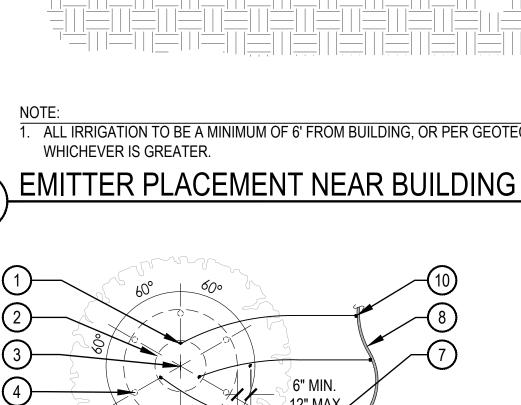



- (10)-NOTE:
- 1. MAXIMUM LENGTH OF ONE DISTRIBUTION TUBE SHALL BE 8' 2. ALL EMISSION POINTS SHALL BE LOCATED ON UPHILL SIDE OF PLANT MATERIAL. ONE EMISSION POINT SHALL BE DIRECTLY TO PLANT BALL AS INDICATED. ADDITIONAL EMISSION
- POINTS SHALL BE WITHIN PLANT PIT PERIMETER AS DIRECTED IN THE EMITTER SCHEDULE.
- SECOND EMISSION POINTS (IF NEEDED) AS PER THE EMITTER SCHEDULE FOR TREES WITH 3" CALIPER OR GREATER OR CONIFEROUS TREES 10' OR GREATER IN HEIGHT
- 4. THIS IS A WATERING GUIDE ONLY. SITE, SOIL AND PLANT CONDITIONS VARY GREATLY. CONTRACTOR MUST OBSERVE THE PLANT MATERIAL AND MAKE ADJUSTMENTS AS

TREE EMITTER PLACEMENT 8



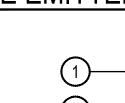

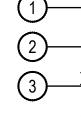

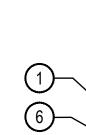


NC	TE:
1.	EMITTERS SHALL BE EQUALLY SPACED AROUND ROOTBALL

- 2. FLUSH ALL LINES THOROUGHLY PRIOR TO EMITTER INSTALLATION.
- 2. IF PLANTING ON A 4:1 SLOPE OR STEEPER, INSTALL EMITTERS ON THE UPHILL SIDE OF PLANT.
- 3. EMITTERS SHALL BE SELF-FLUSHING PRESSURE COMPENSATING-TYPE UNLESS NOTED
- OTHERWISE
- 4. DRIP VALVE ZONES (HYDROZONES) ARE DESIGNED TO ACCOUNT FOR DIFFERENCES IN PLANT
- REQUIREMENTS AND SUN EXPOSURE.

3. ADJUST ALL SPRINKLERS HEADS SO THAT NO OVERSPRAY OCCURS ON ANY WALLS, WALKS, COURTS, ETC. 4. ALL THREADED CONNECTIONS SHALL BE COATED WITH TEFLON TAPE. 5. COMPACT SOIL AROUND HEAD TO THE SAME DENSITY AS ADJACENT UNDISTURBED SUBGRADE. POP-UP SPRAY ASSEMBLY

1. AFTER FLUSHING HEADS, REGRADE AND COMPACT AS NEEDED TO RETURN TO FINISH GRADE

2. SPRINKLERS SHALL BE MIN. 6" FROM ANY WALLS, WALKS, COURTS, AND12" FROM TURF EDGE

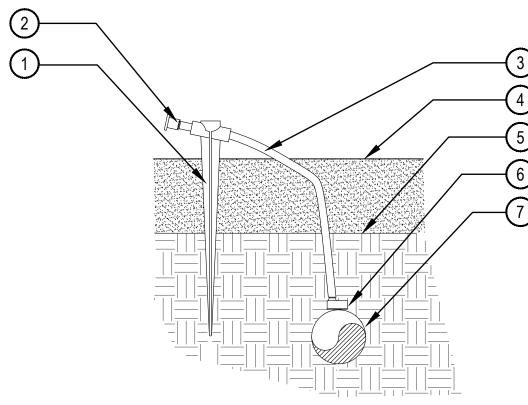

SINGLE OUTLET EMITTER

SCALE: NTS

SINGLE OUTLET EMITTER PLACEMENT

5. CONTRACTOR SHALL ENSURE HYDROZONES ARE VALVED SEPARATELY AS SHOWN ON PLAN.

- 3 PLANT CENTER (TYP.) (4) SECOND EMISSION POINTS SEE
- NOTE 3 BELOW

W/ DRIP STAKE (TYP.)

(2) PLANT ROOT BALL (TYP.)

- 5 TREE TRUNK
- 6 MULCH LAYER
- 7 1/4" DISTRIBUTION TUBING
- (LENGTH NOT TO EXCEED 8')
- (8) 3/4" POLYETHYLENE DRIP TUBING
- (9) SINGLE OUTLET EMITTER

1 DIFFUSER CAP W/ DRIP STAKE

4) SINGLE OUTLET EMITTER


6 1/4" DISTRIBUTION TUBING (LENGTH NOT TO EXCEED 8')


5 3/4" POLYETHYLENE DRIP TUBING

2 PLANT CENTER

3 PLANT ROOTBALL

- 10 ROOTBALL

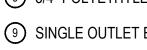

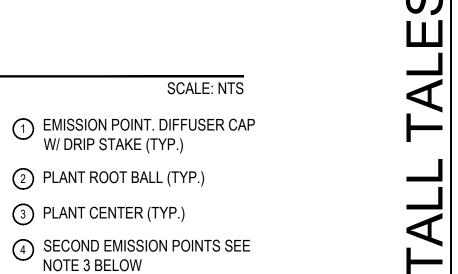

Ζ

R

OWNER:

TALL TALES RANCH SUSAN MOONEY 6311 SOUTH GRANT DRIVE CENTENNIAL, CO 80121 303.806.9140

DATE: <u>(SIP 01) 01/10/2020</u> (SIP 02) 04/05/2020

> SHEET TITLE: IRRIGATION DETAILS



1101 Bannock Street Denver, Colorado 80204 P 303.892.1166 www.norris-design.com




6" MIN.

212" MAX



1. ALL IRRIGATION TO BE A MINIMUM OF 6' FROM BUILDING, OR PER GEOTECH REPOR

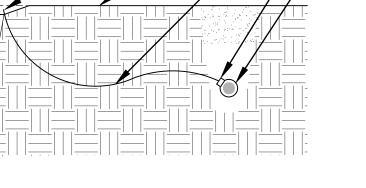

6 POLYETHYLENE LATERAL

5 EMITTER PER SCHEDULE

(4) 1/4" DISTRIBUTION TUBING

1 EXTERIOR OF BUILDING

DRIP STAKE (TYP.)

(2) EMISSION POINT. DIFFUSER CAP W/

3 FINISH GRADE

-(6)

SCALE: NTS

SCALE: NTS

26 of 27

NECESSARY FOR PROPER PLANT WATER REQUIREMENT.


Parker	Nater		Landscape/Irrig	ation Worksheet			
& SANIIA	Pr	oject Name:	all Tales Ranch				
	Landscape/Irrigat	ion Tap address (p	hysical location of	f tap) POC #1			
Landscape Area	High Water TURF (6,000sf = 1 SFE)	Low Water Native Grass and Spray Shrubs & Perennials (10,000sf = 1 SFE)	Drip Irrigated area (20,000sf = 1 SFE)	Non-Irrigated area	Sub-Total of (calculated) Areas	PWSD one SFE per 6000	SFE Requirement (Sub-Total Calculation divided by 6000 = requirement)
Area #1	<u>9,290</u> sf x 1 = <u>9,290</u>	<u>8,522</u> sf x .6 = 5,133	22,769 sf x .3 = 6,831	$\underline{\qquad sf x 0 =} \\ \underline{\qquad 0}$	<u>21,254</u> sf	6,000	<u>3.54</u> SFE's
Worksheet Con Company: Address: Phone #:	Norris	Design Toole Ave., Tucson, A	<u>Z 8570</u> 1	Owner/Developer: Attn: Billing Address: Phone #:	Tall Tales Ranch Susan Mooney 6311 South Grant I 303-806-9140	Drive, Centennial,	CO 80121
Manufacturer Model number	ET Controller (w. Hunter ACC2 A2C-1200M; Modu			0 - 1 SF 1.1 - 2.0 2.1 - 4.0 4.1 - 7.0	Requirements: E's requires a 3/4-incl SFE's requires a 1-in SFE's requires a 1 1/ SFE's requires a 2-in 0 SFE's requires a 3-	ch tap /2-inch tap ch tap	


Parker	Nater		Landscape/Irrig	ation Worksheet			
- & SANIIA	P.	roject Name:	Tall Tales Ranch				
	Landscape/Irriga	tion Tap address (p	ohysical location of	f tap) POC #2			
Landscape Area	High Water TURF (6,000sf = 1 SFE)	Low Water Native Grass and Spray Shrubs & Perennials (10,000sf = 1 SFE)			Sub-Total of (calculated) Areas	PWSD one SFE per 6000	SFE Requirement (Sub-Total Calculation divided by 6000 = requirement)
Area #1	<u>0</u> sf x 1 = 0	<u>5,416</u> sf x .6 = 3,250	1 <u>9,005</u> sf x .3 = 5,702	$\underline{\qquad} sf x 0 = \underline{\qquad} 0$	<u>8,952</u> sf	6,000	<u>1.49</u> _SFE's
Worksheet Com Company: Address: Phone #:	Norris	Design Toole Ave., Tucson, A	A <u>Z 8570</u> 1	Owner/Developer: Attn: Billing Address: Phone #:		Drive, Centennial,	, CO 80121
Manufacturer Model number	ET Controller (w Hunter ACC2 A2C-1200M; Mode			0 - 1 SF 1.1 - 2.0 2.1 - 4.0 4.1 - 7.0	e Requirements: E's requires a 3/4-incl SFE's requires a 1-in SFE's requires a 1 1/ SFE's requires a 2-in 0 SFE's requires a 3-	ch tap 2-inch tap ch tap	

SM CHECKED BY: DRAWN BY:

TALL TALES RANCH

4.01 ACRES SP20-02

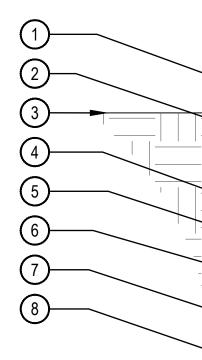

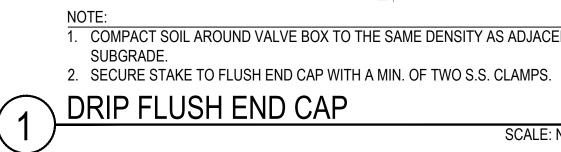


i

i

NORRIS DESIGN andscape Architecture | Branding

1101 Bannock Street Denver, Colorado 80204 P 303.892.1166 www.norris-design.com

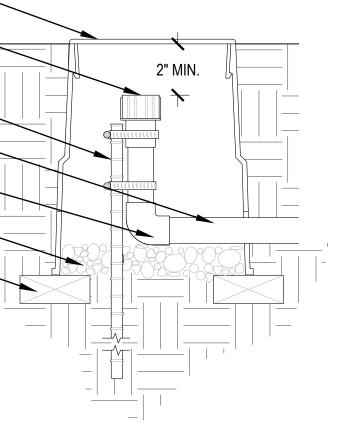

NOTE: 1. COMPACT SOIL AROUND VALVE BOX TO THE SAME DENSITY AS ADJACENT UNDISTURBED

SCALE: NTS

- LOCKING ROUND BOX & COVER
 PER SCHEDULE. TOP OF BOX TO
 BE FLUSH WITH FINISH GRADE
- 2 HOSE END SELF FLUSH CAP
- 3 FINISH GRADE
- 4 24" #4 REBAR TO HOLD END CAP IN PLACE W/ (2) STAINLESS STEEL CLAMPS
- 5 POLYETHYLENE LATERAL
- 6 ELBOW COMPRESSION FITTING
- (7) 3/4" GRAVEL SUMP- 4" DEPTH
- 8 BRICK (2 REQUIRED MIN.)

ANCH Ŷ

OWNER:

TALL TALES RANCH SUSAN MOONEY 6311 SOUTH GRANT DRIVE CENTENNIAL, CO 80121 303.806.9140

DATE: <u>(SIP 01) 01/10/2020</u> <u>(SIP 02) 04/05/2020</u>

SHEET TITLE: IRRIGATION CHARTS/DETAILS